Quonset State Airport

Runway 16/34 Reconstruction

North Kingstown, Rhode Island RIAC Construction Contract No. 33604

Pre-Bid Meeting Friday, February 24, 2023







Agenda

- Sign-In/Introductions
- Project Description
- Solicitation Schedule
- Bid Forms and Documents
- FAA General Provisions
- FAA Mandatory Requirements
- Other Pertinent Information
- Questions
- Site Visit



Introductions

RHODE ISLAND AIRPORT CORPORATION (RIAC)

Guy Zummo – Senior Vice President, Chief Infrastructure Officer Jessica Damicis, PE – Assistant Vice President, Engineering

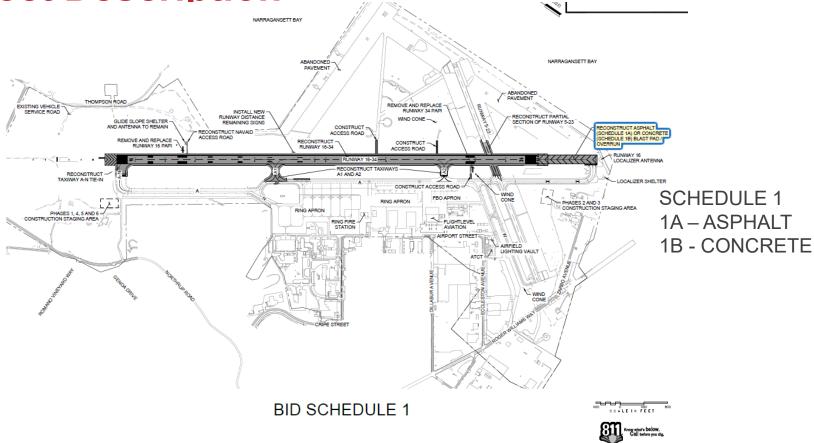
DESIGN TEAM

Paul Piro, PE – Kimley-Horn & Associates Ryan Burkett - Kimley-Horn & Associates






Project Description







Project Description

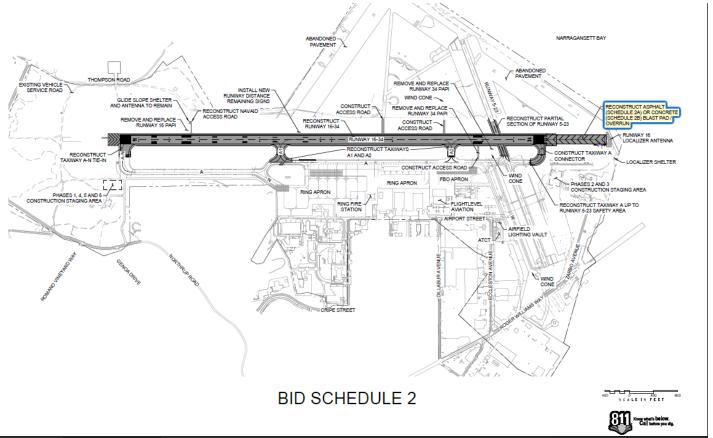





Solicitation Schedule

Solicitation Advertisement
Pre-Bid Conference & Site Visit
Deadline for Questions
Last Addendum Published
Bid Opening

February 16, 2023 February 24, 2023, 2:00 pm February 27, 2023, 2:00 pm March 3, 2023, 2:00 pm March 17, 2023, 2:00 pm

Contract Documents are available for examination and/or download online at www.flyri.com/riac/procurement. RIAC's support contact e-mail is procurement@pvdairport.com. This is the only way to be notified of solicitations and all addenda or other revisions issued during the bidding process.

All questions or requests for clarification regarding the bid documents or the project are to be submitted by email to the Office of Procurement at procurement@pvdairport.com.



Bid Forms and Documents

- DIVISION 0 BIDDING AND CONTRACT DOCUMENTS
- DIVISION 1 GENERAL PROVISIONS
- FAA GENERAL CONTRACT PROVISIONS
- TECHNICAL SPECIFICATIONS



FAA General Provisions

0 = 0	
• SECTION 20	PROPOSAL REQUIREMENTS AND CONDITIONS
• SECTION 30	AWARD AND EXECUTION OF CONTRACT
 SECTION 40 	SCOPE OF WORK
• SECTION 50	CONTROL OF WORK
• SECTION 60	CONTROL OF MATERIALS
• SECTION 70	LEGAL REGULATIONS AND RESPONSIBILITY TO PUBLIC
• SECTION 80	EXECUTION AND PROGRESS

MEASUREMENT AND PAYMENT

DEFINITION OF TERMS





• SECTION 90

• SECTION 10

FAA Mandatory Requirements

- Affirmative Action Equal Employment Opportunity (EEO)
- Davis Bacon Requirements
- DBE Goals and Good Faith Effort
- Buy American
- All other FAA Mandatory Requirements
- Certification Of Offeror/Bidder Regarding Tax
- Delinquency And Felony Convictions



Construction Schedule and Impact on Airfield

		Calendar Year (RW Only)													
Tasks	Approximate Duration (months)	20	23		20)24			20	25			20	26	
NTP - 8/4/2023		Q3	Q4	Q1	Q2	Q3	Q4	Q1	Q2	Q3	Q4	Q1	Q2	Q3	Q4
Administrative Prep	7														
Winter Shutdowns (Dec-Apr)	4														
Phase 1	8					RW 16/34									
Winter Shutdowns (Dec-Apr)	4														
Phase 2	3								RW5/23						

Runway Closures:				
8 months	RW 16/34 Closed	_		
3 months		R	RW5/23	







Other Pertinent Information

- Airport Access/Security Badging through PVD
- Submittal of Safety Plan Compliance Document
- DBE Goal of 9.56%
- Bid to be awarded within 180 days of bid opening
- Mobilization, C-105
- FAA Material Requirements
- Quality Control/Quality Assurance
- Liquidated Damages, GP-80



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Quonset State Airport

Runway 16/34 Reconstruction

THANK YOU!









Thursday, February 24, 2023

Quonset State Airport Runway 16/34 Reconstruction

Name	Company	Role	DBE (Y/N)	Contact Number	Email
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ART Scotton	0166060610	ES71 mg 708	N		ASCOTHOLC DIGRECORD COMP. COM
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Rachel Luna	VHB	Engner		781-752-7122	Orlungavhb.com

		SHEET IN	DEX		
NO.	SHEET	DESCRIPTION	SCHEDULE	STATION BEGIN	STATION END
1	C1.1	COVER SHEET			
3	C1.2 C1.3	SHEET INDEX SHEET INDEX			
4	C1.4	ABBREVIATIONS AND LEGEND			
5	C1.5	SUMMARY OF QUANTITIES			
6	C1.6	SUMMARY OF QUANTITIES			
7	C1.7	GENERAL NOTES			
8	C1.8	CONSTRUCTION SAFETY NOTES AND MISC. DETAILS			
9	C1.9 C1.10	PROJECT LAYOUT PLAN PROJECT LAYOUT PLAN	BID SCHEDULE 1 BID SCHEDULE 2		
11	C1.10	PROJECT LAYOUT PLAN	BID SCHEDULE 3		
12	C1.12	HORIZONTAL AND VERTICAL CONTROL PLAN			
16	C2.1	BORING LAYOUT PLAN			
17	C3.0	OVERALL CONSTRUCTION SAFETY AND PHASING PLAN			
18	C3.1	CONSTRUCTION SAFETY AND PHASING PLAN	BID SCHEDULE 3		
19	C3.2	CONSTRUCTION SAFETY AND PHASING PLAN	BID SCHEDULE 3		
20	C3.3	ELECTRICAL SAFETY AND PHASING PLAN	BID SCHEDULE 3		
21	C3.4	CONSTRUCTION SAFETY AND PHASING PLAN CONSTRUCTION SAFETY AND PHASING PLAN	BID SCHEDULE 3		
22 23	C3.5 C3.6	ELECTRICAL SAFETY AND PHASING PLAN	BID SCHEDULE 3 BID SCHEDULE 3		
23	C3.6	CONSTRUCTION SAFETY AND PHASING PLAN	BID SCHEDULE 3		
25	C3.8	CONSTRUCTION SAFETY AND PHASING DETAILS			
26	C4.0	OVERALL DEMOLITION PLAN			
27	C4.1	DEMOLITION PLAN	BID SCHEDULE 3	88+00	97+00
28	C4.2	DEMOLITION PLAN	BID SCHEDULE 3	97+00	106+00
29	C4.3	DEMOLITION PLAN	BID SCHEDULE 3	106+00	115+00
30	C4.4	DEMOLITION PLAN	BID SCHEDULE 3	115+00	124+00
31	C4.5	DEMOLITION PLAN	BID SCHEDULE 3	124+00	133+00
32	C4.6	DEMOLITION PLAN	BID SCHEDULE 3	133+00	141+00
33 34	C4.7 C4.8	DEMOLITION PLAN DEMOLITION PLAN	BID SCHEDULE 3 BID SCHEDULE 3	141+00	149+00 158+00
35	C4.9	DEMOLITION PLAN	BID SCHEDULE 3	158+00	167+00
36	C4.10	DEMOLITION PLAN	BID SCHEDULE 3	167+00	176+00
37	C4.11	DEMOLITION PLAN	BID SCHEDULE 3	176+00	184+00
38	C4.12	DEMOLITION PLAN	BID SCHEDULE 3	88+00	97+00
39	C4.13	DEMOLITION PLAN	BID SCHEDULE 3	97+00	106+00
40	C4.14	DEMOLITION PLAN	BID SCHEDULE 3	106+00	115+00
41	C4.15	DEMOLITION PLAN	BID SCHEDULE 3	115+00	124+00
42	C4.16	DEMOLITION PLAN	BID SCHEDULE 3	124+00	133+00
43 44	C4.17 C4.18	DEMOLITION PLAN DEMOLITION PLAN	BID SCHEDULE 3 BID SCHEDULE 3	133+00 141+00	141+00 149+00
45	C4.19	DEMOLITION PLAN	BID SCHEDULE 3	149+00	158+00
46	C4.20	DEMOLITION PLAN	BID SCHEDULE 3	158+00	167+00
47	C4.21	DEMOLITION PLAN	BID SCHEDULE 3	167+00	176+00
48	C4.22	DEMOLITION PLAN	BID SCHEDULE 3	176+00	184+00
49	C5.1	TYPICAL SECTIONS			
50	C5.2	TYPICAL SECTIONS			
51	C5.3	TYPICAL SECTIONS			
52 53	C5.4 C5.5	TYPICAL SECTIONS TYPICAL SECTIONS			
53 54	C5.5	TYPICAL SECTIONS TYPICAL SECTIONS			
55 55	C5.7	TYPICAL SECTIONS			
56	C5.8	TYPICAL SECTIONS			
57	C5.9	TYPICAL SECTIONS			
58	C5.10	TYPICAL SECTIONS			
59	C6.0	OVERALL GEOMETRIC LAYOUT PLAN			
60	C6.1	GEOMETRIC LAYOUT PLAN	BID SCHEDULE 3	97+00	106+00
61	C6.2	GEOMETRIC LAYOUT PLAN	BID SCHEDULE 3	106+00	124+00
62	C6.3	GEOMETRIC LAYOUT PLAN	BID SCHEDULE 3	124+00	133+00
63 64	C6.4 C6.5	GEOMETRIC LAYOUT PLAN GEOMETRIC LAYOUT PLAN	BID SCHEDULE 3 BID SCHEDULE 3	133+00 141+00	141+00 149+00
65	C6.6	GEOMETRIC LAYOUT PLAN	BID SCHEDULE 3	149+00	158+00
66	C6.7	GEOMETRIC LAYOUT PLAN	BID SCHEDULE 3	158+00	167+00
67	C6.8	GEOMETRIC LAYOUT PLAN	BID SCHEDULE 3	167+00	176+00
68	C6.9	GEOMETRIC LAYOUT PLAN	BID SCHEDULE 3	176+00	183+50
69	C6.10	GEOMETRIC LAYOUT PLAN	BID SCHEDULE 3		
70	C6.11	GEOMETRIC LAYOUT PLAN	BID SCHEDULE 1 AND 1A	176+00	182+00
71	C6.12	GEOMETRIC LAYOUT PLAN	BID SCHEDULES 1 AND 2	124+00	133+00
72	C6.13	GEOMETRIC LAYOUT PLAN	BID SCHEDULES 1 AND 2	150+00	159+00
73	C6.14	GEOMETRIC LAYOUT PLAN	BID SCHEDULES 1 AND 2	158+50	167+50
74 75	C6.15 C7.0	GEOMETRIC LAYOUT PLAN OVERALL GRADING AND DRAINAGE PLAN	BID SCHEDULE 2	164+50	173+50
/ O	L 07.0				
76	C7.1	GRADING AND DRAINAGE PLAN	BID SCHEDULE 3	88+00	97+00

		SHEET IND	DEX		
NO.	SHEET	DESCRIPTION	SCHEDULE	STATION BEGIN	STATION END
78	C7.3	GRADING AND DRAINAGE PLAN	BID SCHEDULE 3	106+00	115+00
79	C7.4	GRADING AND DRAINAGE PLAN	BID SCHEDULE 3	115+00	124+00
80 81	C7.5 C7.6	GRADING AND DRAINAGE PLAN GRADING AND DRAINAGE PLAN	BID SCHEDULE 3	124+00	133+00 141+00
82	C7.8	GRADING AND DRAINAGE PLAN	BID SCHEDULE 3 BID SCHEDULE 3	133+00	141+00
83	C7.8	GRADING AND DRAINAGE PLAN	BID SCHEDULE 3	149+00	158+00
84	C7.9	GRADING AND DRAINAGE PLAN	BID SCHEDULE 3	158+00	167+00
85	C7.10	GRADING AND DRAINAGE PLAN	BID SCHEDULE 3	167+00	176+00
86	C7.11	GRADING AND DRAINAGE PLAN	BID SCHEDULE 3	176+00	184+00
87	C7.12	GRADING AND DRAINAGE PLAN	BID SCHEDULE 3	88+00	97+00
88	C7.13	GRADING AND DRAINAGE PLAN	BID SCHEDULE 3	97+00	106+00
89	C7.14	GRADING AND DRAINAGE PLAN	BID SCHEDULE 3	106+00	115+00
90 91	C7.15 C7.16	GRADING AND DRAINAGE PLAN GRADING AND DRAINAGE PLAN	BID SCHEDULE 3 BID SCHEDULE 3	115+00 124+00	124+00 133+00
92	C7.10	GRADING AND DRAINAGE PLAN	BID SCHEDULE 3	133+00	141+00
93	C7.18	GRADING AND DRAINAGE PLAN	BID SCHEDULE 3	141+00	149+00
94	C7.19	GRADING AND DRAINAGE PLAN	BID SCHEDULE 3	149+00	158+00
95	C7.20	GRADING AND DRAINAGE PLAN	BID SCHEDULE 3	158+00	167+00
96	C7.21	GRADING AND DRAINAGE PLAN	BID SCHEDULE 3	167+00	176+00
97	C7.22	GRADING AND DRAINAGE PLAN	BID SCHEDULE 3	176+00	184+00
98	C8.0	OVERALL STORM DRAIN LAYOUT PLAN			
99	C8.1	STORM DRAIN PLAN	BID SCHEDULE 3	88+80	97+00
100	C8.2	STORM DRAIN PLAN	BID SCHEDULE 3	97+00	106+00
101	C8.3 C8.4	STORM DRAIN PLAN STORM DRAIN PLAN	BID SCHEDULE 3 BID SCHEDULE 3	106+00 115+00	115+00 124+00
102	C8.5	STORM DRAIN PLAN	BID SCHEDULE 3	124+00	133+00
103	C8.6	STORM DRAIN PLAN	BID SCHEDULE 3	133+00	142+00
105	C8.7	STORM DRAIN PLAN	BID SCHEDULE 3	142+00	151+00
106	C8.8	STORM DRAIN PLAN	BID SCHEDULE 3	151+00	160+00
107	C8.9	STORM DRAIN PLAN	BID SCHEDULE 3	160+00	169+00
108	C8.10	STORM DRAIN PLAN	BID SCHEDULE 3	169+00	178+00
109	C8.11	STORM DRAIN PLAN	BID SCHEDULE 3	178+00	187+00
110	C8.12	STORM DRAIN PLAN	BID SCHEDULE 3	97+00	106+00
111	C8.13	STORM DRAIN PLAN	BID SCHEDULE 3	106+00	115+00
112 113	C8.14 C8.15	STORM DRAIN PLAN STORM DRAIN PLAN	BID SCHEDULE 3 BID SCHEDULE 3	115+00 124+00	124+00 133+00
114	C8.16	STORM DRAIN PLAN	BID SCHEDULE 3	133+00	142+00
115	C8.17	STORM DRAIN PLAN	BID SCHEDULE 3	142+00	151+00
116	C8.18	STORM DRAIN PLAN	BID SCHEDULE 3	151+00	160+00
117	C8.19	STORM DRAIN PLAN	BID SCHEDULE 3	160+00	169+00
118	C8.20	STORM DRAIN PLAN	BID SCHEDULE 3	169+00	178+00
119	C8.21	STORM DRAIN PLAN	BID SCHEDULE 3	178+00	187+00
120	C8.22	STORM DRAIN PLAN	BID SCHEDULE 3		
121	C8.23	STORM DRAIN PLAN	BID SCHEDULE 3		
122 123	C8.24 C8.25	STORM DRAIN PLAN STORM DRAIN PLAN	BID SCHEDULE 3 BID SCHEDULE 3		
124	C8.26	STORM DRAIN PLAN	BID SCHEDULE 3		
125	C8.27	STORM DRAIN PLAN	BID SCHEDULE 3		
126	C8.28	STORM DRAIN PLAN	BID SCHEDULE 3		
127	C8.29	STORM DRAIN PLAN	BID SCHEDULE 3		
128	C8.30	DRAINAGE DETAILS			
129	C8.31	DRAINAGE DETAILS			
130	C8.32	DRAINAGE DETAILS			170+00
131	C8.33	STORM DRAIN PROFILE		85+00	130+00
132 133	C8.34	STORM DRAIN PROFILE STORM DRAIN PROFILE		130+00 175+00	175+00 190+00
134	C8.36	STORM DRAIN PROFILE STORM DRAIN PROFILE		85+00	130+00
135	C8.37	STORM DRAIN PROFILE		130+00	175+00
136	C8.38	STORM DRAIN PROFILE		175+00	190+00
137	C8.39	STORM DRAIN PROFILE			
138	C8.40	STORM DRAIN PROFILE			
139	C9.1	SANITARY SEWER PLAN	ALL SCHEDULES		
140	C9.2	SANITARY SEWER DETAILS			
141	C10.0	OVERALL PAVING PLAN AND PROFILE			
142	C10.1	PAVING PLAN AND PROFILE	BID SCHEDULE 3	88+00	97+00
143	C10.2	PAVING PLAN AND PROFILE	BID SCHEDULE 3	97+00	106+00
144 145	C10.3	PAVING PLAN AND PROFILE PAVING PLAN AND PROFILE	BID SCHEDULE 3 BID SCHEDULE 3	106+00 115+00	115+00 124+00
146	C10.4	PAVING PLAN AND PROFILE PAVING PLAN AND PROFILE	BID SCHEDULE 3	124+00	133+00
147	C10.6	PAVING PLAN AND PROFILE	BID SCHEDULE 3	133+00	142+00
148	C10.7	PAVING PLAN AND PROFILE	BID SCHEDULE 3	142+00	151+00
149	C10.8	PAVING PLAN AND PROFILE	BID SCHEDULE 3	151+00	160+00
150	C10.9	PAVING PLAN AND PROFILE	BID SCHEDULE 3	160+00	169+00
151	C10 10	DAVING DIANIAND DROFILE	DID COLIEDIUE 7	160 + 00	170 : 00

151 C10.10 PAVING PLAN AND PROFILE

ADDENDUM NO. 2 03/07/2023



Kimley»Horn

© 2023 KIMLEY-HORN AND ASSOCIATES, INC. 404 WYMAN STREET SUITE 385 WALTHAM, MA 02451 PHONE: (781) 328-0676

VANASSE HANGEN BRUSTLIN, INC.
1 CEDAR STREET
SUITE 400
PROVIDENCE, RI 02903

Michael Albert Norby

12875

REGISTERED

PROFESSIONAL ENGINEER

CIVIL

-		(3/07	/2023	3	
CKD	NAM					
DATE	03/07/23 MAN					
DESCRIPTION	ADDENDUM NO. 2					
ВУ	RAB					
REV BY	2					

QUONSET STATE AIRPORT RHODE ISLAND AIRPORT CORPORATION NORTH KINGSTOWN, RHODE ISLAND RUNWAY 16-34 RECONSTRUCTIO

 DATE
 03/07/2023

 DESIGNED BY
 RAB

 DRAWN BY
 RAB

 CHECKED BY
 MAN

 PROJECT NO.
 112214003

 FILE NO.
 NT-112214003

 AIP NO.0-00-0000-0000-0000

SHEET TITLE

SHEET INDEX

SHEET NO.
C1.2



178+00

169+00

BID SCHEDULE 3

RE-ISSUED SHEET

		SHEET INI	DEX		
NO.	SHEET	DESCRIPTION	SCHEDULE	STATION BEGIN	STATION END
152	C10.11	PAVING PLAN AND PROFILE	BID SCHEDULE 3	178+00	187+00
153 154	C10.12	PAVING PLAN AND PROFILE PAVING PLAN AND PROFILE	BID SCHEDULE 3 BID SCHEDULE 3	514+00 521+00	521+00 528+00
155	C10.13	PAVING PLAN AND PROFILE PAVING PLAN AND PROFILE	BID SCHEDULE 3	217+00	226+00
156	C10.15	PAVING PLAN AND PROFILE	BID SCHEDULE 3	226+00	233+00
157	C10.16	PAVING PLAN AND PROFILE	BID SCHEDULE 3	233+00	242+00
158	C10.17	PAVING PLAN AND PROFILE	BID SCHEDULE 3	242+00	251+00
159	C10.18	PAVING PLAN AND PROFILE	BID SCHEDULE 3	251+00	260+00
160	C10.19	PAVING PLAN AND PROFILE PAVING PLAN AND PROFILE	BID SCHEDULE 3	260+00	268+00 273+08.85
161 162	C10.20 C10.21	PAVING PLAN AND PROFILE PAVING PLAN AND PROFILE	BID SCHEDULE 3 BID SCHEDULE 3	268+00 4+62	10+00
163	C10.22	PAVING PLAN AND PROFILE	BID SCHEDULE 3	16+00	20+00
164	C10.23	PAVING PLAN AND PROFILE	BID SCHEDULE 3	26+00	30+00
165	C10.24	PAVING PLAN AND PROFILE	BID SCHEDULE 3	70+00	75+17
166	C10.25	PAVING PLAN AND PROFILE	BID SCHEDULE 3	36+00	49+02
167	C11.1	PAVEMENT JOINT LAYOUT PLAN	BID SCHEDULES 1B, 2B, AND 3B BID SCHEDULES 1B, 2B, AND 3B	160+00	190 90
168 169	C11.2 C11.3	PAVEMENT JOINT LAYOUT PLAN PAVEMENT JOINT DETAILS	BID SCHEDULES IB, 2B, AND 3B	169+00	180+82
170	C12.1	GROOVING PLAN	ALL BID SCHEDULES	98+50	143+50
171	C12.2	GROOVING PLAN	ALL BID SCHEDULES	143+50	185+00
172	C13.0	OVERALL PAVEMENT MARKING PLAN			
173	C13.1	PAVEMENT MARKING PLAN		161+00	176+00
174	C13.2	PAVEMENT MARKING PLAN		97+00	106+00
175 176	C13.3	PAVEMENT MARKING PLAN PAVEMENT MARKING PLAN		106+00 122+00	122+00 131+00
176	C13.4	PAVEMENT MARKING PLAN PAVEMENT MARKING PLAN		131+00	149+00
178	C13.6	PAVEMENT MARKING PLAN		149+00	158+00
179	C13.7	PAVEMENT MARKING PLAN	BID SCHEDULE 3	97+00	106+00
180	C13.8	PAVEMENT MARKING PLAN	BID SCHEDULE 3	106+00	124+00
181	C13.9	PAVEMENT MARKING PLAN	BID SCHEDULE 3	124+00	133+00
182	C13.10	PAVEMENT MARKING PLAN	BID SCHEDULE 3	133+00	141+00
183 184	C13.11 C13.12	PAVEMENT MARKING PLAN PAVEMENT MARKING PLAN	BID SCHEDULE 3 BID SCHEDULE 3	141+00 149+00	149+00 158+00
185	C13.13	PAVEMENT MARKING PLAN	BID SCHEDULE 3	158+00	167+00
186	C13.14	PAVEMENT MARKING PLAN	BID SCHEDULE 3	167+00	176+00
187	C13.15	PAVEMENT MARKING PLAN	BID SCHEDULE 3	176+00	183+50
188	C13.16	PAVEMENT MARKING PLAN	BID SCHEDULE 3		
189	C13.17	PAVEMENT MARKING PLAN	BID SCHEDULE 1	168+50	183+50
190 191	C13.18	PAVEMENT MARKING PLAN PAVEMENT MARKING PLAN	BID SCHEDULES 1 AND 2 BID SCHEDULES 1 AND 2	122+00 150+00	131+00 159+00
192	C13.19	PAVEMENT MARKING PLAN	BID SCHEDULES 1 AND 2	158+50	167+50
193	C13.21	PAVEMENT MARKING PLAN	BID SCHEDULE 2	164+50	173+50
194	C13.22	PAVEMENT MARKING DETAILS			
195	C13.23	PAVEMENT MARKING DETAILS			
196	C14.0	SOIL EROSION AND SEDIMENT CONTROL PLAN			
197	C14.1	SOIL EROSION AND SEDIMENT CONTROL NOTES			
198 199	C14.2 C14.3	SOIL EROSION AND SEDIMENT CONTROL DETAILS SOIL EROSION AND SEDIMENT CONTROL PLAN	BID SCHEDULE 3	 80+50	 113+50
200	C14.4	SOIL EROSION AND SEDIMENT CONTROL PLAN	BID SCHEDULE 3	113+50	136+50
201	C14.5	SOIL EROSION AND SEDIMENT CONTROL PLAN	BID SCHEDULE 3	136+50	160+00
202	C14.6	SOIL EROSION AND SEDIMENT CONTROL PLAN	BID SCHEDULE 3		
203	C14.7	SOIL EROSION AND SEDIMENT CONTROL PLAN	BID SCHEDULE 3	160+00	183+50
204	C14.8	SOIL EROSION AND SEDIMENT CONTROL PLAN	BID SCHEDULE 3		
205 206	C14.9 E1.0	SOIL EROSION AND SEDIMENT CONTROL PLAN OVERALL ELECTRICAL DEMOLITION PLAN	ALL BID SCHEDULES		
206	E1.0	ELECTRICAL DEMOLITION PLAN	BID SCHEDULE 3	88+00	97+00
208	E1.2	ELECTRICAL DEMOLITION PLAN	BID SCHEDULE 3	97+00	106+00
209	E1.3	ELECTRICAL DEMOLITION PLAN	BID SCHEDULE 3	106+00	115+00
210	E1.4	ELECTRICAL DEMOLITION PLAN	BID SCHEDULE 3	115+00	124+00
211	E1.5	ELECTRICAL DEMOLITION PLAN	BID SCHEDULE 3	124+00	133+00
212	E1.6	ELECTRICAL DEMOLITION PLAN	BID SCHEDULE 3	133+00	141+00
213	E1.7 E1.8	ELECTRICAL DEMOLITION PLAN ELECTRICAL DEMOLITION PLAN	BID SCHEDULE 3 BID SCHEDULE 3	141+00 149+00	149+00 158+00
215	E1.9	ELECTRICAL DEMOLITION PLANS	BID SCHEDULE 3	158+00	167+00
216	E1.10	ELECTRICAL DEMOLITION PLAN	BID SCHEDULE 3	167+00	176+00
217	E1.11	ELECTRICAL DEMOLITION PLAN	BID SCHEDULE 3	176+00	184+00
218	E1.12	ELECTRICAL DEMOLITION PLAN	BID SCHEDULE 3	115+00	124+00
219	E1.13	ELECTRICAL DEMOLITION PLAN	BID SCHEDULE 3	124+00	133+00
220	E1.14	ELECTRICAL DEMOLITION PLAN	BID SCHEDULE 3	133+00	141+00
221	E1.15 E1.16	ELECTRICAL DEMOLITION PLAN ELECTRICAL DEMOLITION PLAN	BID SCHEDULE 3 BID SCHEDULE 3	141+00 149+00	149+00 158+00
222		LEECTINGAL DEMOCTION FLAN	אוס אום און אוים אום אויס טום Joi1EDULE J	1+3+00	130700
222		ELECTRICAL DEMOLITION PLAN	BID SCHFDUI F .3	158+00	167+00
222223224	E1.17 E1.18	ELECTRICAL DEMOLITION PLAN ELECTRICAL DEMOLITION PLAN	BID SCHEDULE 3 BID SCHEDULE 3	158+00 167+00	167+00 176+00

		SHEET INDI	ΞX	STATION	STATIO
NO.	SHEET	DESCRIPTION	SCHEDULE	BEGIN	END
226	E1.20	ELECTRICAL DEMOLITION PLAN	BID SCHEDULES 1 AND 2		
227	E2.0	OVERALL LIGHTING AND SIGNAGE PLAN			100+00
228	E2.1	LIGHTING AND SIGNAGE PLAN	BID SCHEDULE 3	97+00	106+00
229 230	E2.2 E2.3	LIGHTING AND SIGNAGE PLAN LIGHTING AND SIGNAGE PLAN	BID SCHEDULE 3 BID SCHEDULE 3	106+00	124+00 133+00
231	E2.4	LIGHTING AND SIGNAGE PLAN	BID SCHEDULE 3	133+00	141+00
232	E2.5	LIGHTING AND SIGNAGE PLAN	BID SCHEDULE 3	141+00	149+00
233	E2.6	LIGHTING AND SIGNAGE PLAN	BID SCHEDULE 3	149+00	158+00
234	E2.7	LIGHTING AND SIGNAGE PLAN	BID SCHEDULE 3	158+00	167+00
235	E2.8	LIGHTING AND SIGNAGE PLAN	BID SCHEDULE 3	167+00	176+00
236	E2.9	LIGHTING AND SIGNAGE PLAN	BID SCHEDULE 3	176+00	185+00
237	E2.10	LIGHTING AND SIGNAGE PLAN	BID SCHEDULE 3		
238	E2.11	LIGHTING AND SIGNAGE PLAN	BID SCHEDULE 1	169+00	181+00
239	E2.12	LIGHTING AND SIGNAGE PLAN	BID SCHEDULES 1 AND 2	124+00	133+00
240	E2.13	LIGHTING AND SIGNAGE PLAN	BID SCHEDULES 1 AND 2	150+00	159+00
241	E2.14	LIGHTING AND SIGNAGE PLAN	BID SCHEDULES 1 AND 2	158+50	167+50
242	E2.15	LIGHTING AND SIGNAGE PLAN	BID SCHEDULE 2	164+50	173+50
243	E2.16	LIGHTING AND SIGNAGE PLAN	BID SCHEDULE 2	173+50	182+50
244	E2.17	ELECTRICAL LAYOUT PLAN	SCHEDULES 1 AND 2	XXX+XX	XXX+XX
245	E3.1	LIGHTING AND SIGNAGE DATA TABLES	SCHEDULE 3	97+00	106+00
246	E3.2	LIGHTING AND SIGNAGE DATA TABLES	BID SCHEDULE 3	106+00	124+00
247	E3.3	LIGHTING AND SIGNAGE DATA TABLES	BID SCHEDULE 3	124+00	133+00
248	E3.4	LIGHTING AND SIGNAGE DATA TABLES	BID SCHEDULE 3	133+00	141+00
249	E3.5	LIGHTING AND SIGNAGE DATA TABLES	BID SCHEDULE 3	141+00	149+00
250	E3.6	LIGHTING AND SIGNAGE DATA TABLES	BID SCHEDULE 3	149+00	158+00
251 252	E3.7 E3.8	LIGHTING AND SIGNAGE DATA TABLES	BID SCHEDULE 3 BID SCHEDULE 3	158+00	167+00 176+00
252 253	E3.9	LIGHTING AND SIGNAGE DATA TABLES LIGHTING AND SIGNAGE DATA TABLES	BID SCHEDULE 3	167+00	1/6+00
253 254	E3.10	LIGHTING AND SIGNAGE DATA TABLES LIGHTING AND SIGNAGE DATA TABLES	BID SCHEDULE 3		
255	E3.11	LIGHTING AND SIGNAGE DATA TABLES	BID SCHEDULES 1 AND 2	124+00	133+00
256	E3.12	LIGHTING AND SIGNAGE DATA TABLES	BID SCHEDULES 1 AND 2	150+00	159+00
257	E3.13	LIGHTING AND SIGNAGE DATA TABLES	BID SCHEDULES 1 AND 2	158+50	167+50
258	E3.14	LIGHTING AND SIGNAGE DATA TABLES	BID SCHEDULE 2	164+50	173+50
259	E4.0	LANDING ZONE LIGHTING SCOPE OF WORK			
260	E4.1	ASSAULT ZONE LIGHTING AND SIGNAGE PLAN	ALL BID SCHEDULES	98+00	116+23
261	E4.2	ASSAULT ZONE LIGHTING AND SIGNAGE PLAN	ALL BID SCHEDULES	116+23	134+23
262	E4.3	ASSAULT ZONE LIGHTING AND SIGNAGE PLAN	ALL BID SCHEDULES	134+23	152+23
263	E4.4	ASSAULT ZONE LIGHTING AND SIGNAGE PLAN	ALL BID SCHEDULES	152+23	170+23
264	E4.5	ASSAULT ZONE LIGHTING AND SIGNAGE PLAN	ALL BID SCHEDULES		
265	E5.0	AIRFIELD LIGHTING VAULT PROPOSED LAYOUT			
266	E5.1	AIRFIELD LIGHTING CONTROL AND MONITORING PLAN			
267	E5.2	ELECTRICAL DETAILS CONCRETE HANDHOLE			
268	E5.3	ELECTRICAL DETAILS TRENCHING & GROUNDING			
269	E5.4	ELECTRICAL DETAILS SIGNAGE			
270	E5.5	ELECTRICAL DETAILS LIGHT FIXTURES			
271	E5.6	ELECTRICAL DETAILS RDR SIGNAGE AND WINDCONE			
272	E5.7	ELECTRICAL DETAILS PAPI DETAILS			
273	E5.8	ELECTRICAL DETAILS PAPI SITING DETAILS			
274	E6.0	OVERALL RUNWAY 16-34 CIRCUIT MAP	BID SCHEDULE 1		
275	E6.1	RUNWAY 16-34 CIRCUIT MAP			
276	E6.2	RUNWAY 16-34 CIRCUIT MAP			
277	E6.3	RUNWAY 16-34 CIRCUIT MAP			
278	E6.4	OVERALL RUNWAY 16-34 CENTERLINE LIGHTING CIRCUIT MAP	BID SCHEDULE 1	<u> </u>	
279 280	E6.5 E6.6	RUNWAY 16-34 CENTERLINE LIGHTING CIRCUIT MAP RUNWAY 16-34 CENTERLINE LIGHTING CIRCUIT MAP			
280 281	E6.7	RUNWAY 16-34 CENTERLINE LIGHTING CIRCUIT MAP RUNWAY 16-34 CENTERLINE LIGHTING CIRCUIT MAP			
281 282	E6.7 E6.8	OVERALL TAXIWAY A CIRCUIT MAP	BID SCHEDULE 1		
283	E6.9	TAXIWAY A CIRCUIT MAP	DID SCHEDULE I		
284	E6.10	TAXIWAY A CIRCUIT MAP			
285	E6.11	TAXIWAY A CIRCUIT MAP			
286	E6.12	OVERALL RUNWAY 16-34 PAPI CIRCUIT MAP	BID SCHEDULE 1		
287	E6.13	RUNWAY 16-34 PAPI CIRCUIT MAP			
288	E6.14	RUNWAY 16-34 PAPI CIRCUIT MAP			
289	E6.15	RUNWAY 16-34 PAPI CIRCUIT MAP			
290	E6.16	OVERALL MILITARY LANDING ZONE LIGHTING CIRCUIT MAP	BID SCHEDULE 1		
291	E6.17	MILITARY LANDING ZONE LIGHTING CIRCUIT MAP			
292	E6.18	MILITARY LANDING ZONE LIGHTING CIRCUIT MAP			
293	E6.19	MILITARY LANDING ZONE LIGHTING CIRCUIT MAP			
294	E7.0	MALSR LAYOUT PLAN AND PROFILE	BID SCHEDULE 3		
295	E7.1	ELECTRICAL DETAILS - MALSR DETAILS	BID SCHEDULE 3		
200				1	
296	E7.2	ELECTRICAL DETAILS — MALSR DETAILS	BID SCHEDULE 3		
	E7.2 E7.3	ELECTRICAL DETAILS — MALSR DETAILS ELECTRICAL DETAILS — MALSR DETAILS	BID SCHEDULE 3		

BID SCHEDULE 3

298 E7.4 ELECTRICAL DETAILS - MALSR DETAILS

ADDENDUM NO. 2 03/07/2023



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Michael Albert Norby

No. 12875

REGISTERED

PROFESSIONAL ENGINEER

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DATE	03/07/23 MAN					
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QUONSET STATE AIRPORT RHODE ISLAND AIRPORT CORPORATION NORTH KINGSTOWN, RHODE ISLAND RUNWAY 16-34 RECONSTRUCTION

 DATE
 03/07/2023

 DESIGNED BY
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 DRAWN BY
 RAB

 CHECKED BY
 MAN

 PROJECT NO.
 112214003

 FILE NO.
 NT-112214003


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SHEET INDEX

SHEET NO.
C1.3

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SAFETY AND SECURITY NOTES

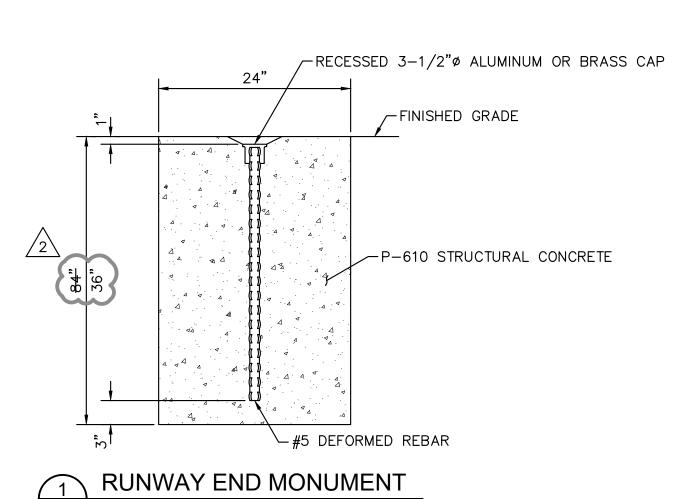- SAFETY AND SECURITY IS THE RESPONSIBILITY OF THE CONTRACTOR AND SHALL BE COORDINATED WITH THE RHODE ISLAND AIRPORT CORPORATION THROUGH THE RPR (SEE CONTRACT DOCUMENTS). REFER TO THE SECURITY NOTES, THIS SHEET, AND ADVISORY CIRCULAR AC 150/5370-2G, OPERATIONAL SAFETY ON AIRPORTS DURING CONSTRUCTION. CONTRACTOR SHALL IMPLEMENT PROCEDURES IN THE CONSTRUCTION SAFETY AND PHASING PLAN (CSPP).
- THE CONTRACTOR'S ACCESS POINTS TO THE CONSTRUCTION SITE WILL BE VERIFIED AT THE PRE-CONSTRUCTION MEETING AND SHALL BE LIMITED TO THOSE DESIGNATED BY AIRPORT OPERATIONS OR AS SHOWN ON THE PROJECT PHASING PLAN. ALL CONTRACTOR VEHICLES AND CONSTRUCTION TRAFFIC SHALL REMAIN WITHIN THE PROPOSED DESIGNATED CONSTRUCTION LIMITS OR HAUL ROUTES UNLESS AUTHORIZED OTHERWISE.
- 3. THE OWNER MAY SUSPEND THE WORK BY WRITTEN NOTICE WHEN, IN THEIR JUDGMENT, PROGRESS IS UNSATISFACTORY, WORK BEING DONE IS UNAUTHORIZED OR DEFECTIVE, WEATHER CONDITIONS ARE UNSUITABLE, OR THERE IS DANGER TO PUBLIC HEALTH AND SAFETY.
- 4. THE CONTRACTOR'S SUPERINTENDENT SHALL BE ON THE CONSTRUCTION SITE AT ALL TIMES DURING WORKING HOURS WHILE THIS PROJECT IS IN PROGRESS. THE CONTRACTOR'S SUPERINTENDENT SHALL BE DESIGNATED THE CONTRACTOR'S RESPONSIBLE REPRESENTATIVE AND SHALL BE AVAILABLE IN CASE OF EMERGENCIES ON A TWENTY-FOUR HOUR DAILY BASIS. THE CONTRACTOR SHALL PROVIDE THE PHONE NUMBERS OF THREE (3) OF ITS RESPONSIBLE PERSONNEL, INCLUDING THE PROJECT SUPERINTENDENT, AND TWO (2) EACH RESPONSIBLE PERSONNEL, FROM THE GRADING AND SAFETY OFFICIAL, EACH OF WHOM MAY BE CONTACTED IN AN EMERGENCY.
- ALL OF THE CONSTRUCTION WORK ON THIS PROJECT WILL OCCUR WITHIN THE AIR OPERATIONS AREA (AOA) AND IS SUBJECT TO OPERATIONAL SAFETY AND SECURITY REQUIREMENTS OF THE QUONSET STATE AIRPORT, THE FAA AND THE RHODE ISLAND NATIONAL GUARD (RING). ANY ADDITIONAL REQUIREMENTS DEEMED NECESSARY BY THE QUONSET STATE AIRPORT, THE FAA OR RING WILL BE COMPLIED WITH BY THE CONTRACTOR AT NO COST TO THE OWNER.
- ALL CONTRACTOR VEHICLES, INCLUDING HAULING VEHICLES, CONSTRUCTION EQUIPMENT (ROLLERS, BACK HOES, SCRAPERS, ETC.) THAT ARE AUTHORIZED TO OPERATE ON THE AIRPORT WITHIN THE DESIGNATED LIMITS OF CONSTRUCTION OR HAUL ROUTES AS DEFINED HEREIN, SHALL DISPLAY A 3'X3' OR LARGER ORANGE AND WHITE CHECKERBOARD FLAG IN FULL VIEW ABOVE THE VEHICLE. EACH CHECKERBOARD COLOR SHALL BE ONE-FOOT (1') SQUARE. OPERATIONS DURING PERIODS OF DARKNESS OR LIMITED VISIBILITY SHALL REQUIRE THE CONTRACTOR'S VEHICLES TO BE EQUIPPED WITH ROTATING OR FLASHING AMBER LIGHTS. VEHICLES MAKING ONLY OCCASIONAL VISITS TO THE JOB SITE ARE EXEMPT FROM THE IDENTIFICATION REQUIREMENTS CONTAINED ABOVE PROVIDED THAT A PROPERLY IDENTIFIED VEHICLE ESCORTS THEM INTO, THROUGH, AND OUT OF THE AIRPORT SECURED AREA. THESE AND OTHER VEHICLES NEEDING INTERMITTENT IDENTIFICATION MAY BE MARKED WITH MAGNETICALLY ATTACHED PLACARDS CONTAINING THE NAME OF THE CONTRACTOR WITH A MINIMUM OF THREE-INCH HIGH LETTERS THAT ARE COMMERCIALLY AVAILABLE.
- 7. ALL VEHICLES AND EQUIPMENT SHALL BE KEPT WITHIN THE WORK AREAS ESTABLISHED FOR EACH WORK SHIFT UNLESS TRAVELING TO OR FROM THE SITE. ALL VEHICLES AND EQUIPMENT SHALL BE PARKED IN STAGING AREAS AS APPROVED BY THE ENGINEER AT ALL TIMES WHEN NOT BEING ACTIVELY USED ON THE PROJECT WORK, UNLESS OTHERWISE APPROVED IN WRITING BY THE ENGINEER.
- 8. ALL WORK AREAS SHALL BE SECURED AT THE END OF EACH WORKDAY.
- 9. CONTRACTOR PROCEDURES FOR OPERATING VEHICLES AT QUONSET STATE AIRPORT ARE AS FOLLOWS:
 - A. THE PROCEDURES APPLY TO ALL PERSONNEL WHO OPERATE VEHICLES AT OQU. THE PROCEDURES MUST BE REVIEWED AND UNDERSTOOD PRIOR TO BEGINNING VEHICLE OPERATIONS.
- VEHICLES OPERATING WITHIN SECURITY FENCING ARE LIMITED TO THOSE DISPLAYING PERMANENT COMPANY LOGOS AND MUST BE ON OFFICIAL COMPANY BUSINESS.
- NO PRIVATE VEHICLES MAY BE OPERATED ON AIRPORT PROPERTY WITHOUT PRIOR ARRANGEMENTS WITH AIRPORT
- 10. DURING TIMES OF OPERATIONS, A GATE GUARD (INCIDENTAL TO PROJECT) PROVIDED BY THE CONTRACTOR SHALL BE PLACED AT THE CONTRACTOR ACCESS GATE. THE GUARD SHALL CHECK FOR ENTRY UNDER THE SPECIAL PROVISIONS AND THE LATEST FAA AND TSA SAFETY REGULATIONS. PROPER TRAINING AND COORDINATION WITH AIRPORT OPERATIONS WILL BE REQUIRED.
- 11. CONTRACTOR SHALL PROVIDE TRAINED FLAGMEN TO COORDINATE AND CONTROL CONSTRUCTION TRAFFIC WHEN OPERATING ADJACENT TO THE RUNWAY SAFETY AREA, THE AIR NATIONAL GUARD APRON, OR WITHIN LOCALIZER CRITICAL AREA. FLAGMEN SHALL BE ABLE TO SPEAK CLEAR ENGLISH AND BE EQUIPPED WITH CELL PHONES AND RADIOS ON GROUND CONTROL FREQUENCY UNICOM 134.5.
- 12. CONSTRUCTION EQUIPMENT SHALL NOT PENETRATE THE HEIGHT RESTRICTIONS FOR THE FAR PART 77 SURFACES.
- 13. ALL VEHICLES SHALL BE PARKED AND SERVICED IN THE DESIGNATED STAGING AND EMPLOYEE PARKING AREAS SHOWN ON THE PLANS. THE CONTRACTOR IS RESPONSIBLE FOR TRANSPORTING THEIR EMPLOYEES TO AND FROM THESE AREAS TO THE JOBSITE.
- 14. THE CONTRACTOR WILL BE REQUIRED TO COORDINATE THEIR WORK SO AS TO SATISFY CLEARANCE REQUIREMENTS FOR ARRIVAL AND DEPARTURE OF SCHEDULED AIRCRAFT, AND IN COMPLIANCE WITH FAA ADVISORY CIRCULAR 150/5370-2G OR LATEST VERSION IN AFFECT DURING THE PROJECT, CONCERNING OPERATIONAL SAFETY ON AIRPORTS DURING CONSTRUCTION ACTIVITY.
- 15. THE CONTRACTOR SHALL ACQUAINT THEIR SUPERVISORS AND EMPLOYEES WITH THE AIRPORT AND OPERATIONS THAT ARE INHERENT TO QUONSET STATE AIRPORT AND SHALL CONDUCT THEIR CONSTRUCTION ACTIVITIES TO CONFORM TO ALL ROUTINE AND EMERGENCY AIR TRAFFIC REQUIREMENTS AND GUIDELINES FOR SAFETY SPECIFIED HEREIN. THE CONTRACTOR SHALL BE RESPONSIBLE FOR PROVIDING ALL SAFETY DEVICES AS REQUIRED FOR THE PROTECTION OF THEIR




QUONSET STATE AIRPORT 150 AIRPORT STREET NORTH KINGSTOWN, RI 02852 PHONE: (401) 691-2000

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KIMLEY-HORN AND ASSOCIATES, IN 404 WYMAN STREET SUITE 385 WALTHAM, MA 02451 PHONE: (781) 328-0676


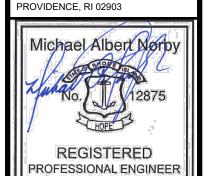
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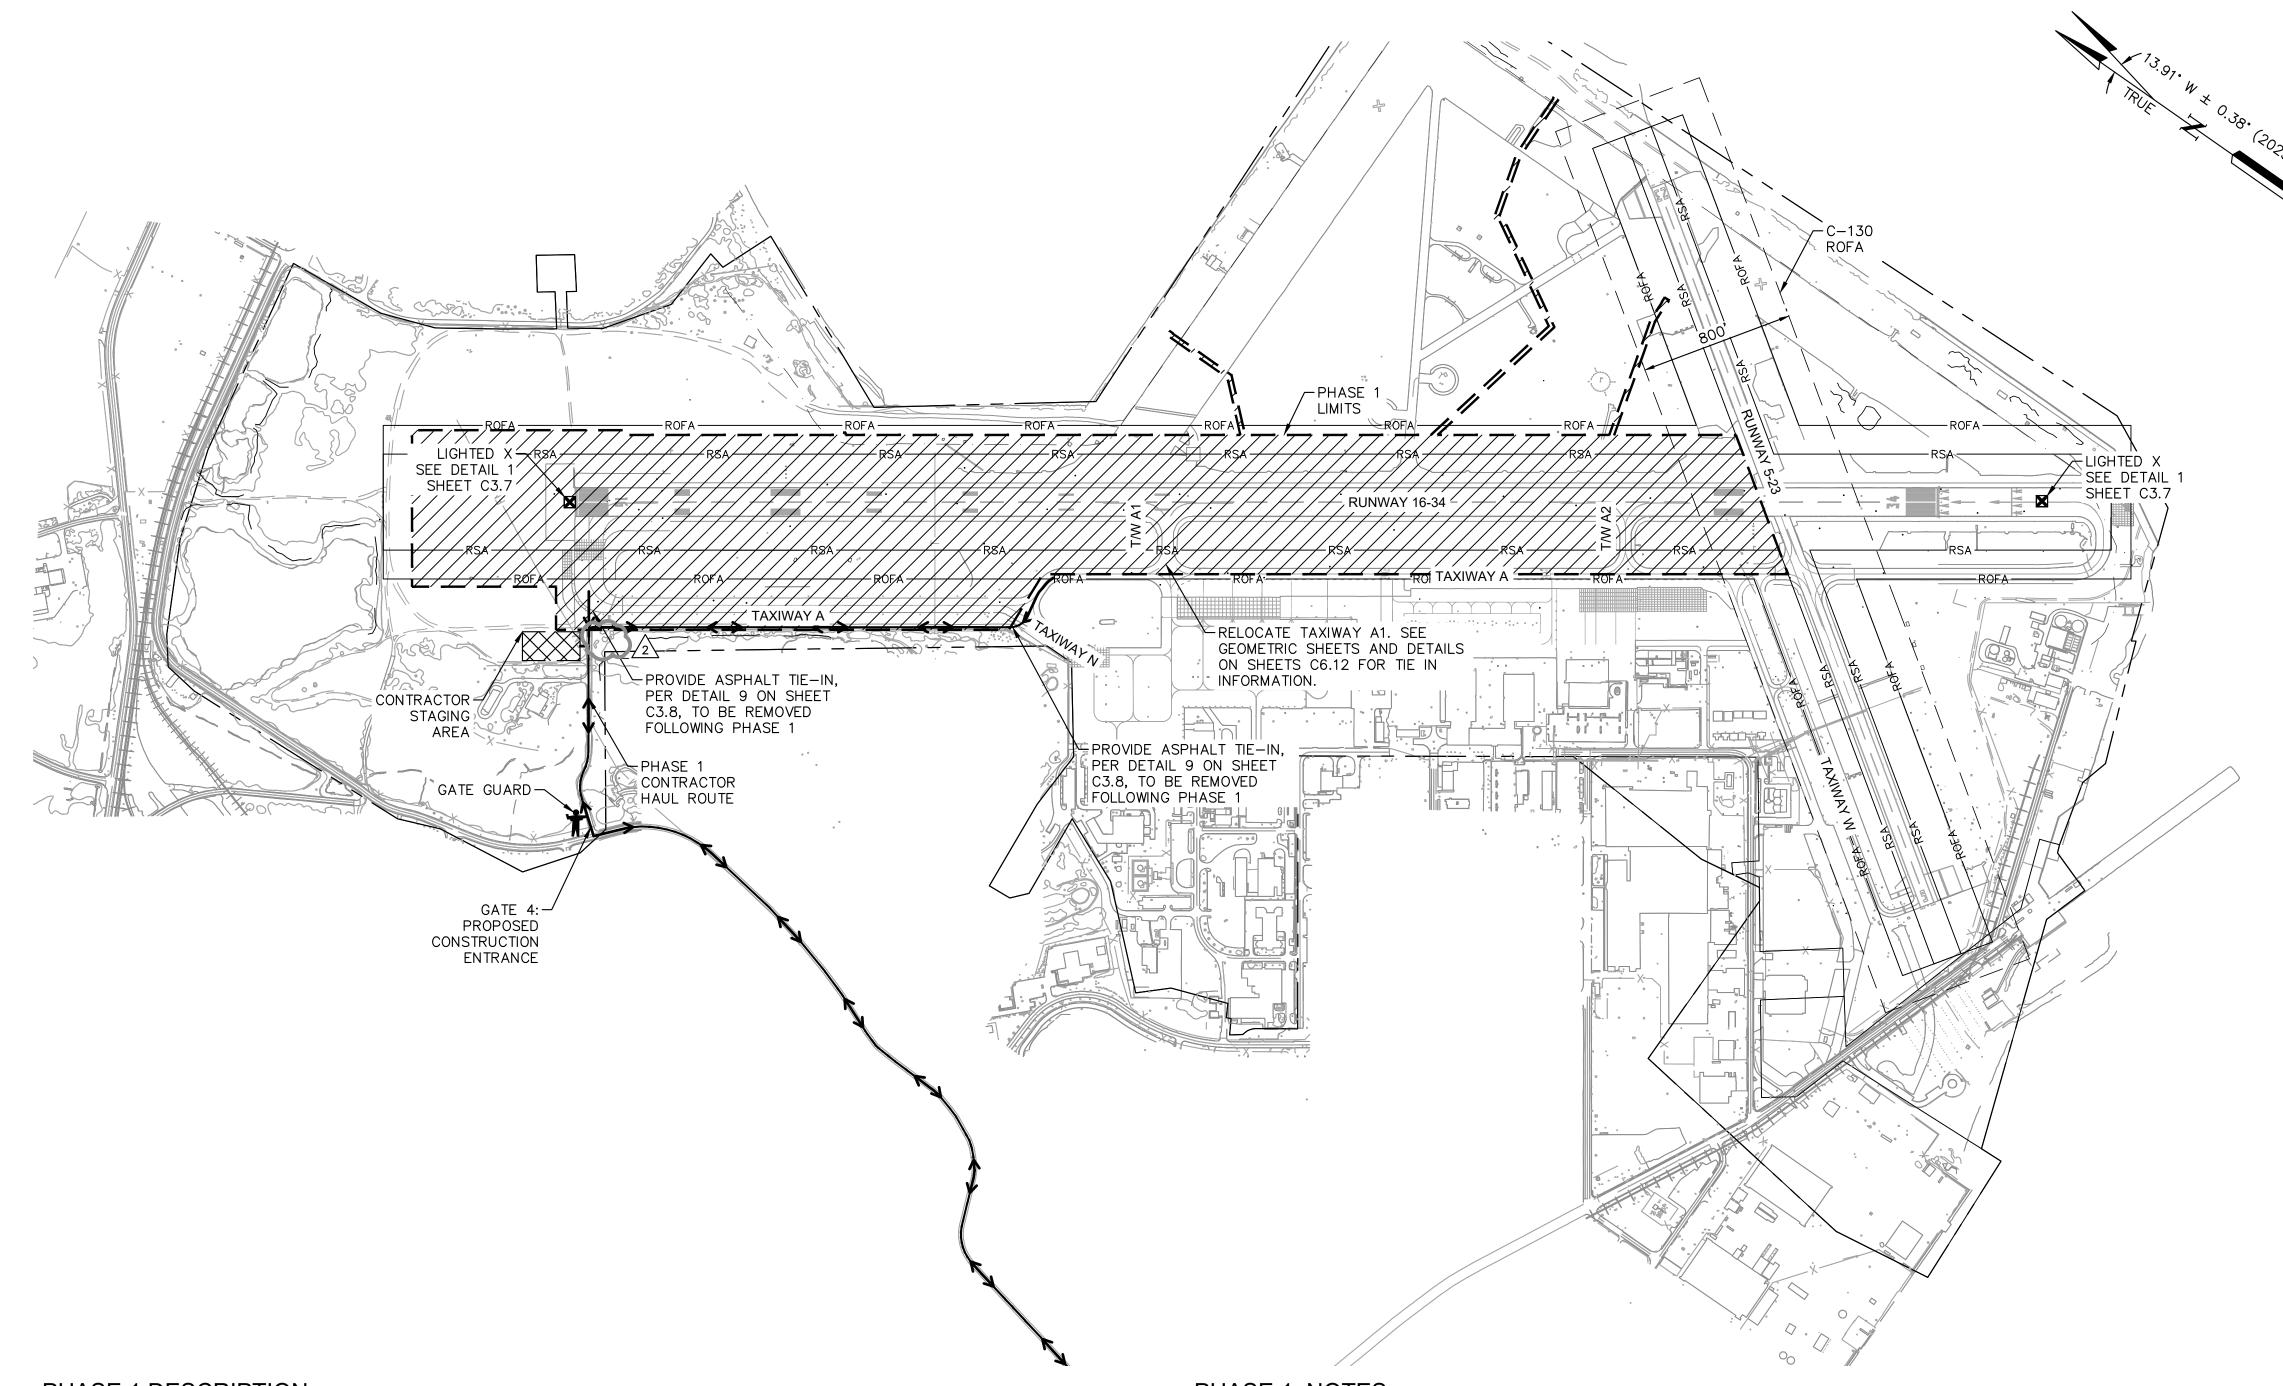
CONSTRUCTION SAFETY NOTES AND MISC. DETAIL

SHEET NO.

SHEET TITLE

C1.8 8 OF 297





PHASE 1 DESCRIPTION

CONTRACT DURATION: 243 CALENDAR DAYS

IT IS ASSUMED THAT THE MAJORITY OF WORK IN THIS PHASE WILL BE COMPLETED DURING THE DAY WITH FOLLOWING EXCEPTIONS. NOTAMS WILL BE REQUIRED FOR ALL WORK DURING THIS PHASE. DETAILED LOOK-AHEAD SCHEDULES WILL HELP TO ISSUE NOTAMS AT CORRECT TIME.

- 1. WORK WILL BE COMPLETED WITHIN THE INFIELD AREAS BETWEEN RUNWAY 16-34 AND TAXIWAY A (ADJACENT TO EXISTING APRON). THE WORK WITHIN THIS AREA WILL INCLUDE BUT NOT BE LIMITED TO GRADING, DRAINAGE, INSTALLATION OF CULVERTS, AND POSSIBLE ELECTRICAL CONNECTIONS. SOME WORK WITHIN THIS AREA WILL BE WITHIN THE TAXIWAY OBJECT FREE AREA (TOFA) AND TAXIWAY SAFETY AREA (TSA) OF TAXIWAY A. WORK WITHIN THESE TWO AREAS WILL REQUIRE A CLOSURE OR NO OPERATIONAL MOVEMENTS DURING SOME OF THESE DURATIONS. THE WORK WITHIN THESE AREAS CAN BE COMPLETED AT NIGHT OR COORDINATED (BY RPR AND RIAC) DURING NO-FLY DAYS. ANY OPEN TRENCH, NOT BACKFILLED, WILL HAVE TO BE BRIDGED WITH A METAL PLATE IF NOT COMPLETED WHEN THE TAXIWAY IS CLOSED.
- 2. RUNWAY 5-23 SAFETY AREA (RSA) RUNWAY 5-23 IS CLASSIFIED AS A B-II RUNWAY (RSA IS 75 FEET ON EITHER SIDE OF RUNWAY CENTERLINE). HOWEVER, WHEN THE RHODE ISLAND NATIONAL GUARD (RING) IS USING THEIR C-130s ON THIS RUNWAY, THE RSA CHANGES TO ACCOMMODATE A C-IV RUNWAY (RSA IS 250 FEET ON EITHER SIDE OF RUNWAY CENTERLINE). DURING THE INSTALLATION OF

THE TEMPORARY RUNWAY TRANSITION (10' FOR VEHICLES ONLY), WORK WILL BE COMPLETED WITHIN THE C-IV RSA OF RUNWAY 5-23. COORDINATION WILL BE REQUIRED TO EITHER WORK AT NIGHT OR DURING HOURS RING IS NOT FLYING.

3. BOTH RUNWAYS 5-23 AND 16-34 WILL BE CLOSED FOR 1 NIGHT (8 HOURS) TO REMOVE PAVEMENT MARKINGS ASSOCIATED WITH RUNWAY 16-34 AND WITHIN THE WIDENED MODIFIED ROFA (FOR A C-IV RUNWAY) FOR RUNWAY 5-23. RUNWAY 5-23 CAN BE RE-OPENED ONCE THIS HAS BEEN COMPLETED. THE REMAINING PAVEMENT MARKINGS ON THE RUNWAY 34 END ASSOCIATED WITH RUNWAY 16-34 WILL NEED TO BE REMOVED AT THE BEGINNING OF PHASE 1.

PHASE 1 NOTES

- 1. RUNWAY 5-23 WILL BE OPENED AND RUNWAY 16-34 WILL BE CLOSED FOR THE DURATION OF THIS PHASE.
- 2. AT THE COMPLETION OF PHASE 1, AND PRIOR TO COMMENCEMENT OF PHASE 2, THE CONTRACTOR SHALL INSTALL PAVEMENT MARKINGS FOR A SHORTENED RUNWAY 16-34 PER SHEETS C13.1 - C13.6. THE RUNWAY WILL BE SHORTENED THROUGH THE WINTER CLOSURE AND THE COMPLETION OF PHASE 2.
- 3. THIS PHASE WILL INCLUDE INSTALLATION OF TEMPORARY RUNWAY 34 PAPI AND TEMPORARY ELEVATED THRESHOLD LIGHTS TO BE KEPT OPERATIONAL THROUGHOUT THE DURATION OF WINTER SHUTDOWN AND THE COMPLETION OF PHASE 2. CONTINUED COORDINATION WITH FAA WILL BE REQUIRED TO PERFORM THE NECESSARY FLIGHT CHECKS.
- 4. RECONSTRUCTION SHALL INCLUDE TAXIWAY A1 IN ITS NEW LOCATION UP TO PARALLEL TAXIWAY A TO THE LIMITS SHOWN ON C6.12., AND REMOVAL OF EXISTING TAXIWAY A1 BETWEEN TAXIWAY A AND RUNWAY 16-34. IT WILL ALSO INCLUDE RECONSTRUCTION OF TAXIWAY A2 TO THE LIMITS SHOWN ON C6.13. BOTH TAXIWAY CONNECTORS WILL BE CONSTRUCTED TO TIE IN TO EXISTING PARALLEL TAXIWAY A. BOTH TAXIWAYS WILL BE RECONSTRUCTED AT THE NEW TAXIWAY A OFFSET IN LATER PHASES. TAXIWAY A1 WILL TIE INTO EXISTING PARALLEL TAXIWAY A, WHILE TAXIWAY A2 WILL TIE INTO EXISTING TAXIWAY A2 AT THE LOCATIONS SHOWN ON SHEETS C6.12, AND C6.13, RESPECTIVELY.

- 5. CONTRACTOR MUST ALLOW FOR ARFF ACCESS THROUGH THE SITE IN CASE OF EMERGENCY.
- 6. ONCE THE CONTRACTOR HAS COMPLETED THE FINAL PUNCH LIST ITEMS AND THIS PHASE HAS BEEN COMPLETED AND ACCEPTED, A SEPARATE NTP WILL BE ISSUED FOR PHASE 2 TO BEGIN IN APRIL OF 2025.
- 7. WORK WITHIN PHASE 1 WILL INCLUDE PORTIONS OF RUNWAY 5-23 RUNWAY OBJECT FREE AREA (ROFA) FOR BOTH CIVILIAN AND MILITARY OPERATIONS. WORK IN THESE AREAS WILL REQUIRE PROPER AND TIMELY COORDINATION WITH AIRPORT OPERATIONS AND THE NATIONAL GUARD. COORDINATION SHOULD BE A WEEKLY PART OF THE LOOK-AHEAD SCHEDULE AND ITEMS SUCH AS THIS SHALL BE MENTIONED.
- 8. CONTRACTOR SHALL INSTALL TEMPORARY LED LIGHT FIXTURES WITHIN THIS PHASE.

ADDENDUM NO. 2 03/07/2023

LEGEND PHASE 1 LIMITS PHASE 2 LIMITS CONTRACTOR STAGING AREA ▲ ▲ ▲ LOW PROFILE BARRICADES (LINKED) DETAIL 2 SHEET C3.7 ● ● LOW PROFILE BARRICADES (UNLINKED) DETAIL 4 SHEET C3.7 FLAGGER (PROVIDED BY THE CONTRACTOR) TAXIWAY CLOSURE X (PROVIDED BY THE CONTRACTOR) DETAIL 3 SHEET C3.7 GATE GUARD (PROVIDED BY THE CONTRACTOR) PORTABLE LIGHTED RUNWAY CLOSURE MARKER (PROVIDED BY THE CONTRACTOR) DETAIL 1 SHEET C3.7 **←** HAUL ROUTE

GENERAL NOTES

■ PHASE LIMITS

'-■-■- Orange Safety Fence

DETAIL 5 SHEET C3.8

-xxxx- PAVEMENT MARKING OBLITERATION

REFER TO SHEET C3.0 FOR GENERAL PHASING NOTES.

QUONSET STATE AIRPORT 150 AIRPORT STREET NORTH KINGSTOWN, RI 02852 PHONE: (401) 691-2000

Kimley»Horn

State Airport

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Michael Albert Nor

REGISTERED PROFESSIONAL ENGINEER CIVIL

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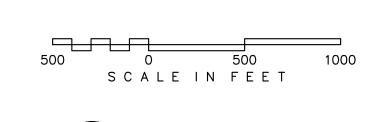
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03/07/2023

CONSTRUCTION SAFETY AND PHASING PLAN PHASE 1 BID SCHEDULE 3

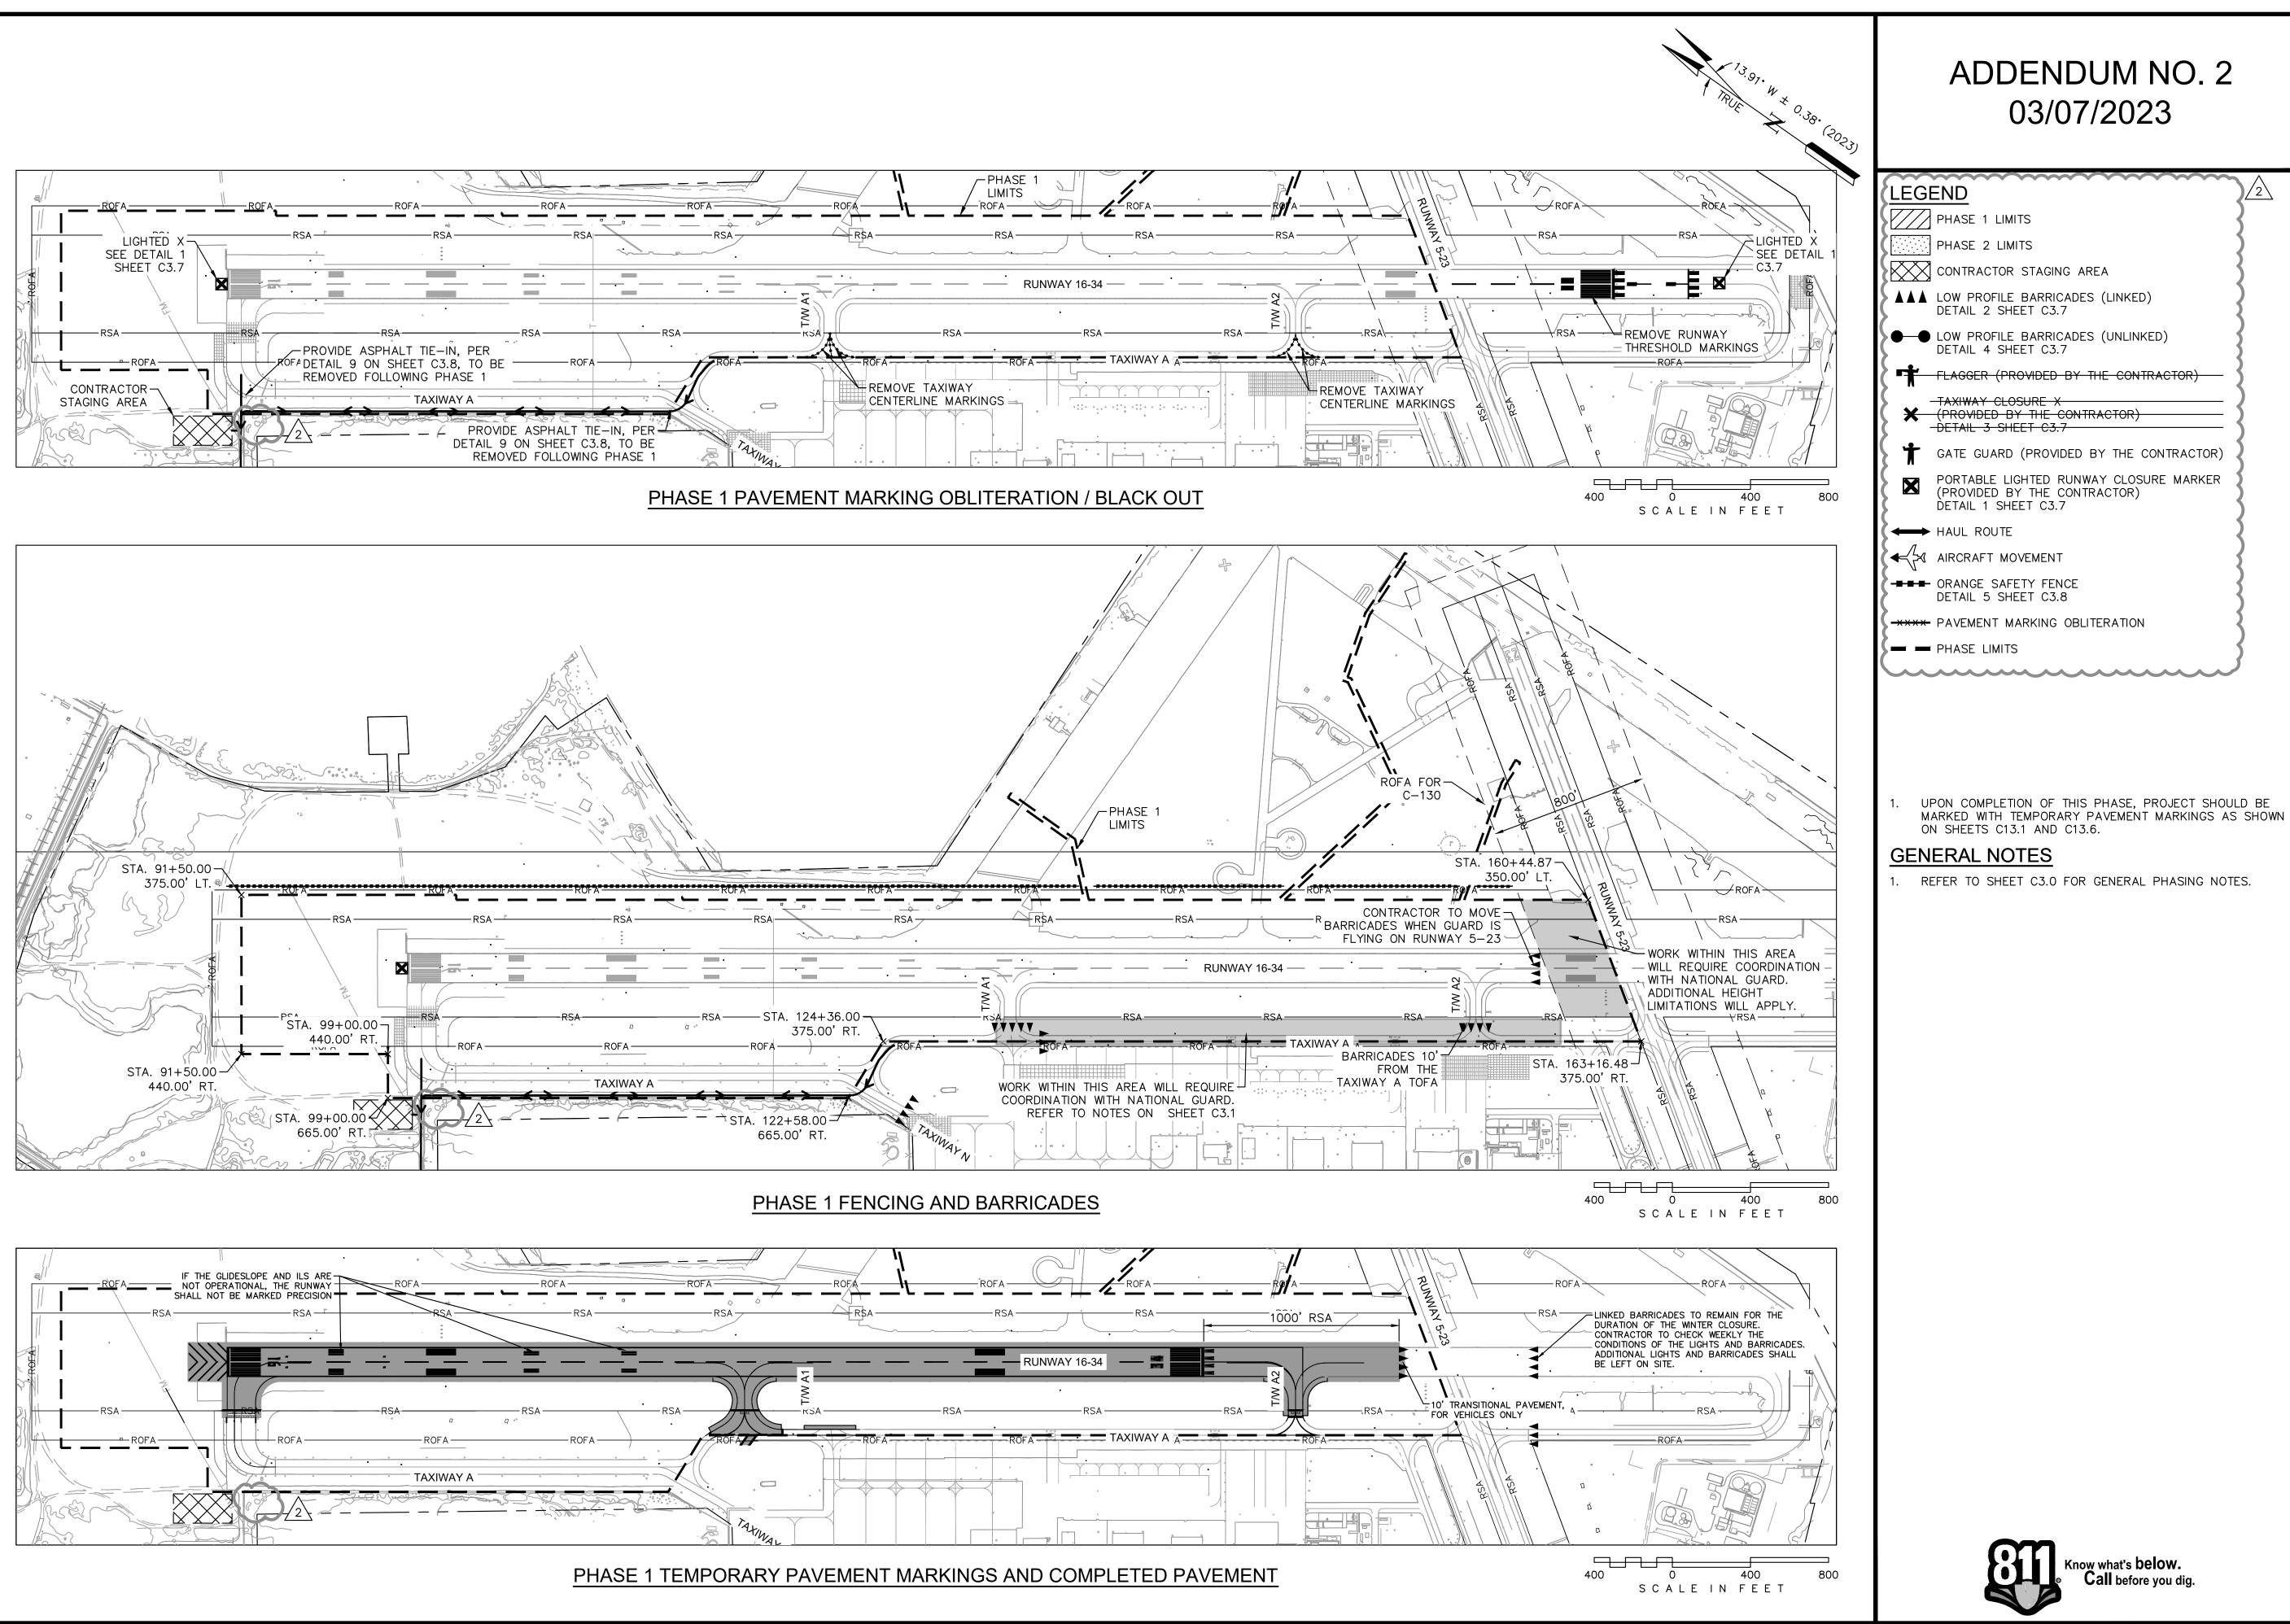
SHEET NO.

C3.1 17 OF 297



Know what's **below**.

Call before you dig.



LEGEND PHASE 1 LIMITS PHASE 2 LIMITS CONTRACTOR STAGING AREA ▲ ▲ ▲ LOW PROFILE BARRICADES (LINKED) DETAIL 2 SHEET C3.7 ▶ ● LOW PROFILE BARRICADES (UNLINKED) DETAIL 4 SHEET C3.7 FLAGGER (PROVIDED BY THE CONTRACTOR) (PROVIDED BY THE CONTRACTOR) - DETAIL 3 SHEET C3.7 - GATE GUARD (PROVIDED BY THE CONTRACTOR) PORTABLE LIGHTED RUNWAY CLOSURE MARKER (PROVIDED BY THE CONTRACTOR) DETAIL 1 SHEET C3.7

UPON COMPLETION OF THIS PHASE, PROJECT SHOULD BE

Know what's **below.**Call before you dig.

GENERAL NOTES

REFER TO SHEET C3.0 FOR GENERAL PHASING NOTES.

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N, RHODE ISLAND
ECONSTRUCT QUONSET & RHODE ISLAND A NORTH KINGST RUNWAY 16-34

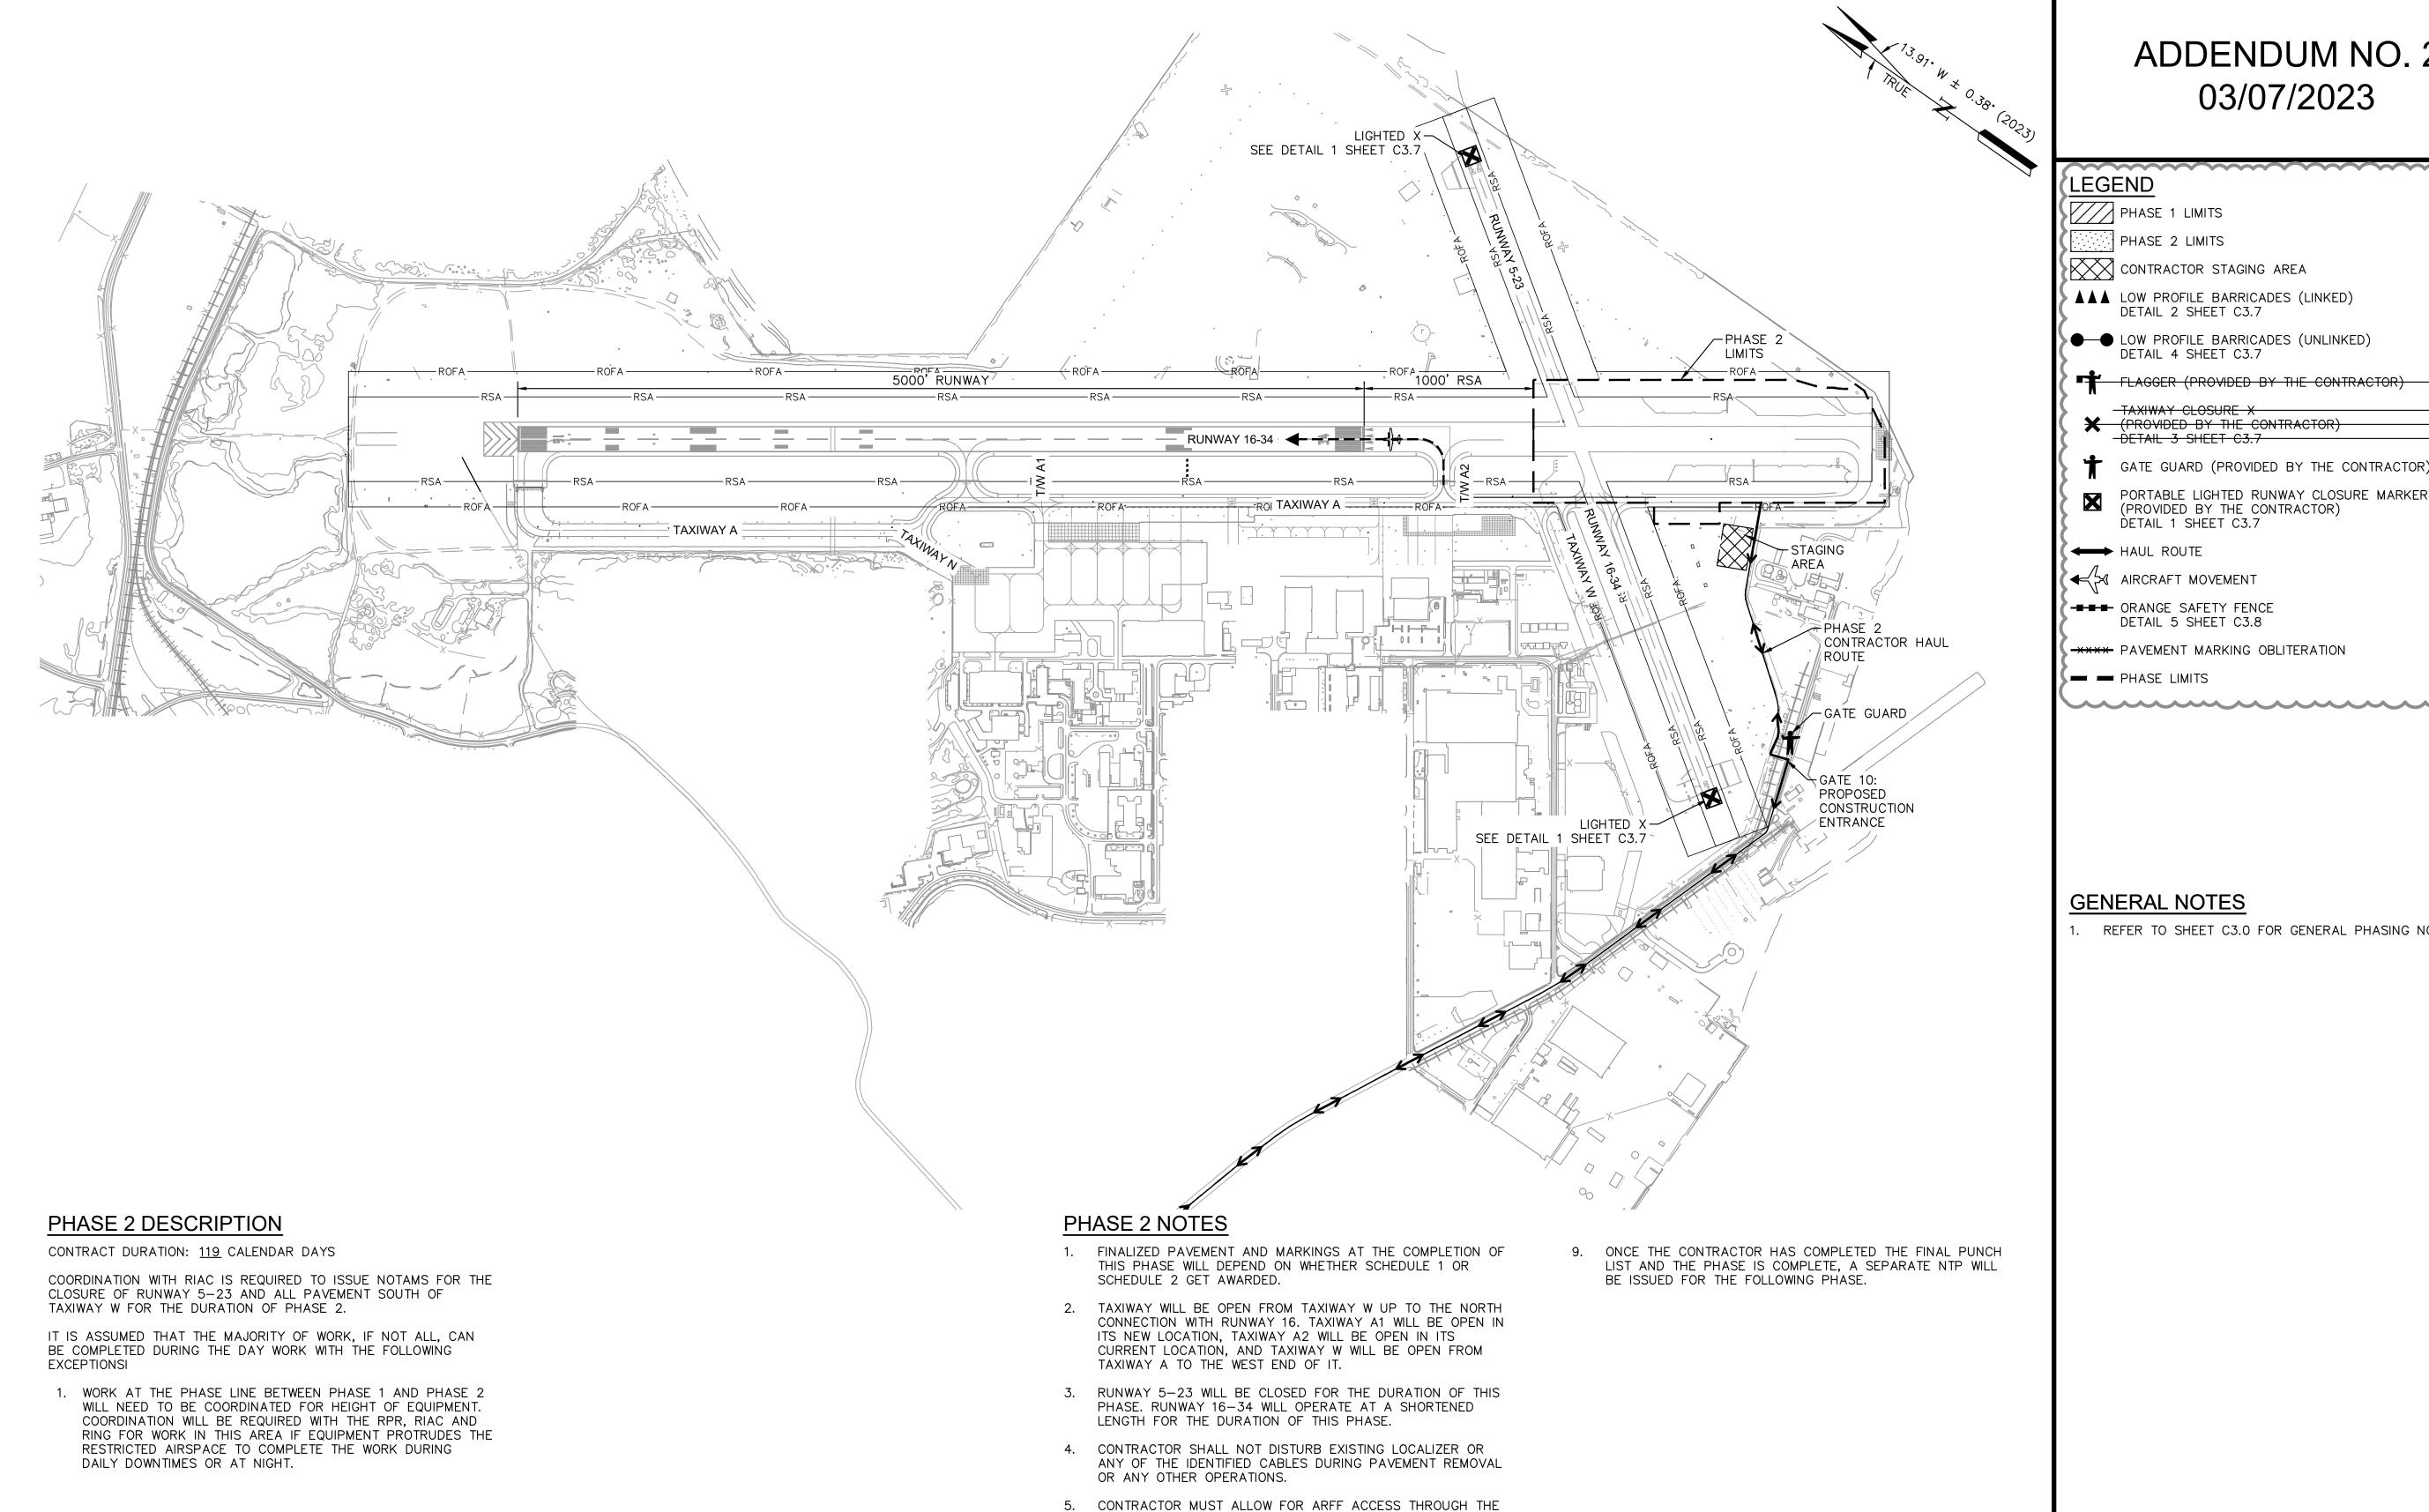
DESIGNED BY DRAWN BY **CHECKED BY** PROJECT NO. 112214003 FILE NO. PH01-11221400 AIP NO.0-00-0000-000-0000 SHEET TITLE CONSTRUCTION

03/07/2023

SAFETY AND PHASING PLAN PHASE 1 BID SCHEDULE 3

SHEET NO.

C3.2 18 OF 297



SITE IN CASE OF EMERGENCY.

RUNWAY 16-36 MARKINGS.

SCHEDULE.

6. DEPENDING ON THE AWARD OF SCHEDULE 1 OR SCHEDULE 2,

OF THE PHASE. PLEASE SEE ELECTRICAL SHEETS FOR

CHANGES AND MODIFICATIONS DEPENDING ON AWARDED

7. AIRPORT MAINTENANCE FUNCTIONS, SUCH AS SNOW REMOVAL.

RUNWAY 5-23 SHALL OPERATE AT THEIR FULL LENGTHS.

REFER TO SHEET C13.0 THROUGH ##### FOR PERMANENT

8. AT THE COMPLETION OF THE PHASE, RUNWAY 16-34 AND

THE LIGHTING IN THIS PHASE WILL CHANGE UPON COMPLETION

ADDENDUM NO. 2 03/07/2023

LEGEND PHASE 1 LIMITS ∵ PHASE 2 LIMITS CONTRACTOR STAGING AREA LOW PROFILE BARRICADES (LINKED)
DETAIL 2 SHEET C3.7 ▶ ● LOW PROFILE BARRICADES (UNLINKED) DETAIL 4 SHEET C3.7 FLAGGER (PROVIDED BY THE CONTRACTOR) (PROVIDED BY THE CONTRACTOR)

-DETAIL 3 SHEET C3.7

GATE GUARD (PROVIDED BY THE CONTRACTOR)

PORTABLE LIGHTED RUNWAY CLOSURE MARKER (PROVIDED BY THE CONTRACTOR)

DETAIL 1 SHEET C3.7 ← HAUL ROUTE

← S AIRCRAFT MOVEMENT -== ORANGE SAFETY FENCE DETAIL 5 SHEET C3.8

-xxx- PAVEMENT MARKING OBLITERATION

PHASE LIMITS

GENERAL NOTES

REFER TO SHEET C3.0 FOR GENERAL PHASING NOTES.

QUONSET 8
RHODE ISLAND A
NORTH KINGS1
JNWAY 16-34

DIVAVIII
CHECKED BY
PROJECT NO. 1122
FILE NO. PH02-1122
AIP NO.0-00-0000-000
SHEET TITLE
CONSTRUCTI

CONSTRUCTION SAFETY AND PHASING PLAN

PHASE 2 BID SCHEDULE 3

SHEET NO.

Know what's below. Call before you dig.

<u>5</u>00

SCALE IN FEET

Kimley»Horn © 2023 KIMLEY-HORN AND ASSOCIATES, INC 404 WYMAN STREET SUITE 385

State Airport

QUONSET STATE AIRPORT 150 AIRPORT STREET NORTH KINGSTOWN, RI 02852

PHONE: (401) 691-2000

WALTHAM, MA 02451 PHONE: (781) 328-0676

VANASSE HANGEN BRUSTLIN, INC. 1 CEDAR STREET SUITE 400

PROVIDENCE, RI 02903 Michael Albert Norb


REGISTERED PROFESSIONAL ENGINEER CIVIL

Distance		(3/07	/2023	3	
СКБ	MAN					
DATE	03/07/23 MAN					
DESCRIPTION	ADDENDUM NO. 2					
ВУ	MSB					
REV BY	2					

E AIRPORT
CORPORATIC
HODE ISLAND

03/07/2023 **DESIGNED BY** MAN DRAWN BY MAN 214003 214003 0-0000

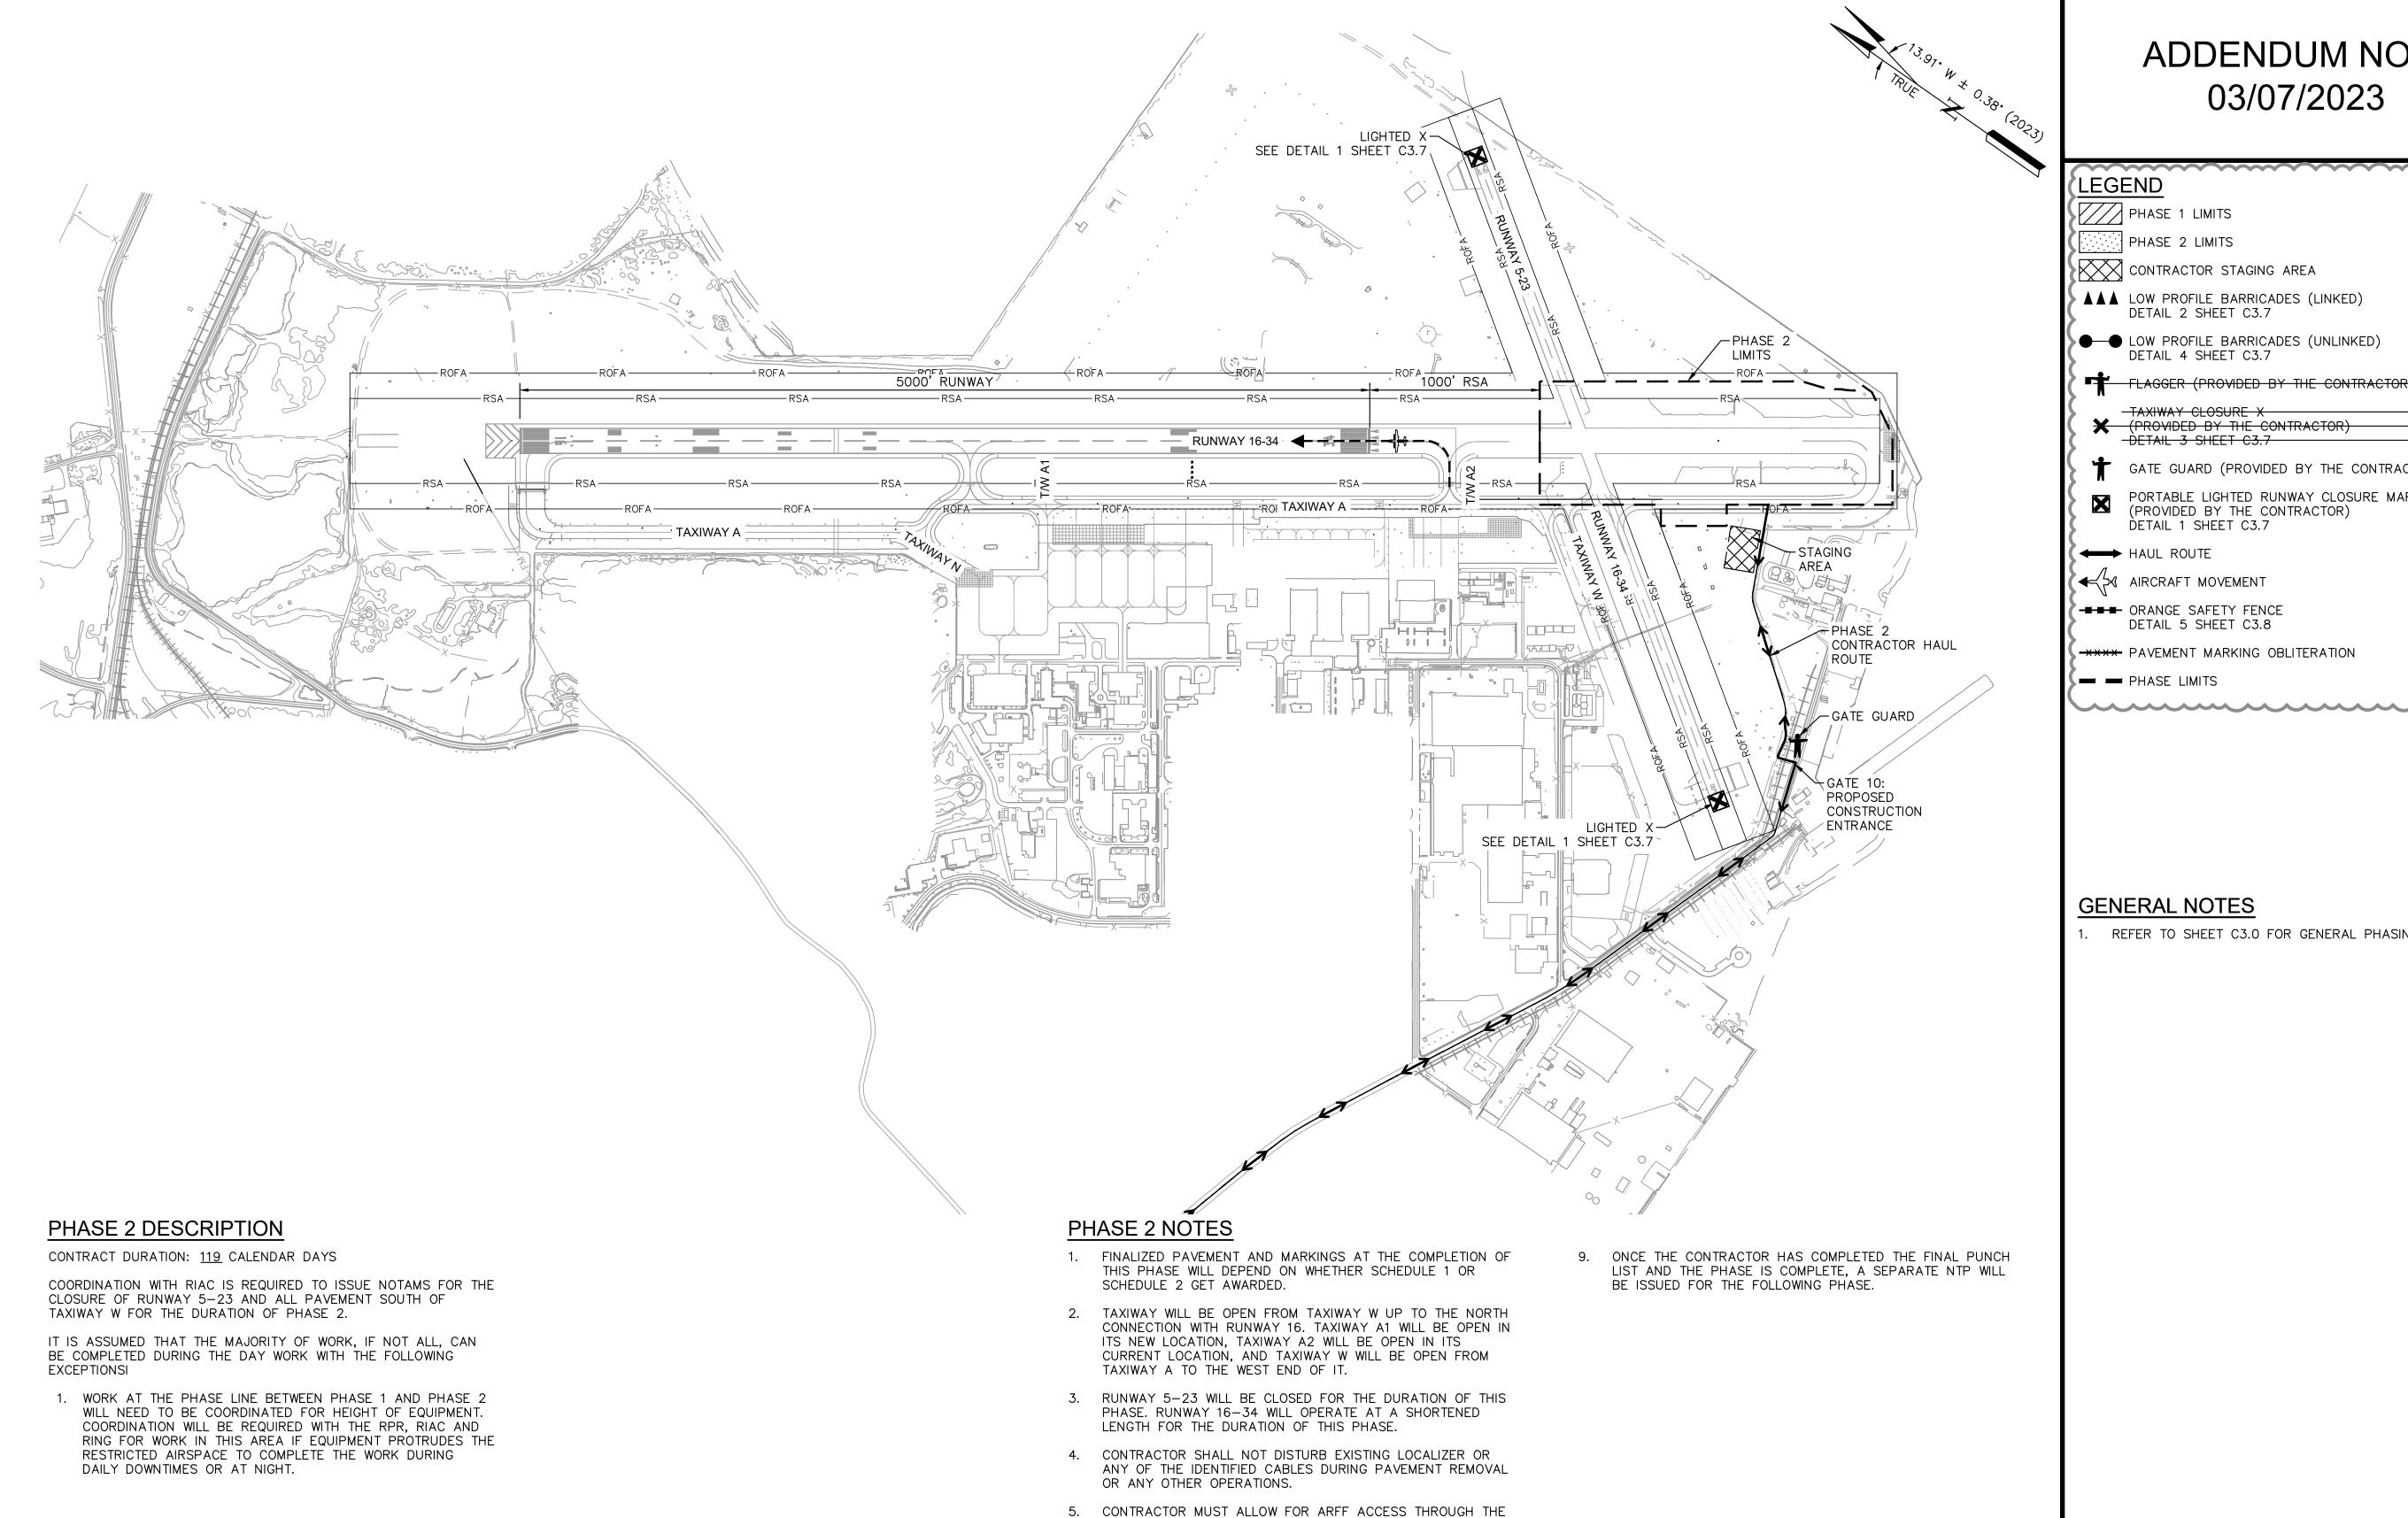20 OF 297



SITE IN CASE OF EMERGENCY.

RUNWAY 16-36 MARKINGS.

SCHEDULE.

6. DEPENDING ON THE AWARD OF SCHEDULE 1 OR SCHEDULE 2,

OF THE PHASE. PLEASE SEE ELECTRICAL SHEETS FOR

CHANGES AND MODIFICATIONS DEPENDING ON AWARDED

7. AIRPORT MAINTENANCE FUNCTIONS, SUCH AS SNOW REMOVAL.

RUNWAY 5-23 SHALL OPERATE AT THEIR FULL LENGTHS.

REFER TO SHEET C13.0 THROUGH ##### FOR PERMANENT

8. AT THE COMPLETION OF THE PHASE, RUNWAY 16-34 AND

THE LIGHTING IN THIS PHASE WILL CHANGE UPON COMPLETION

ADDENDUM NO. 2 03/07/2023

LEGEND PHASE 1 LIMITS ∵ PHASE 2 LIMITS CONTRACTOR STAGING AREA LOW PROFILE BARRICADES (LINKED)
DETAIL 2 SHEET C3.7 LOW PROFILE BARRICADES (UNLINKED)
DETAIL 4 SHEET C3.7 FLAGGER (PROVIDED BY THE CONTRACTOR) (PROVIDED BY THE CONTRACTOR)

-DETAIL 3 SHEET C3.7

GATE GUARD (PROVIDED BY THE CONTRACTOR)

PORTABLE LIGHTED RUNWAY CLOSURE MARKER (PROVIDED BY THE CONTRACTOR) DETAIL 1 SHEET C3.7

← HAUL ROUTE

← S AIRCRAFT MOVEMENT

-== ORANGE SAFETY FENCE DETAIL 5 SHEET C3.8

-xxx- PAVEMENT MARKING OBLITERATION

PHASE LIMITS

GENERAL NOTES

REFER TO SHEET C3.0 FOR GENERAL PHASING NOTES.

<u>5</u>00

Know what's below.

Call before you dig.

SCALE IN FEET

E AIRPORT
CORPORATIC
HODE ISLAND QUONSET 8
RHODE ISLAND A
NORTH KINGS1
JNWAY 16-34

State Airport

Kimley»Horn

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VANASSE HANGEN BRUSTLIN, INC.

Michael Albert Norb

REGISTERED PROFESSIONAL ENGINEER CIVIL

QUONSET STATE AIRPORT 150 AIRPORT STREET NORTH KINGSTOWN, RI 02852

PHONE: (401) 691-2000

404 WYMAN STREET

1 CEDAR STREET SUITE 400

PROVIDENCE, RI 02903

SUITE 385 WALTHAM, MA 02451 PHONE: (781) 328-0676

DRAWN BY MSB
CHECKED BY MAN
PROJECT NO. 112214003
FILE NO. PH02-112214003
AIP NO.0-00-0000-000-0000
SHEET TITLE
OHEET THEE

DESIGNED BY

03/07/2023

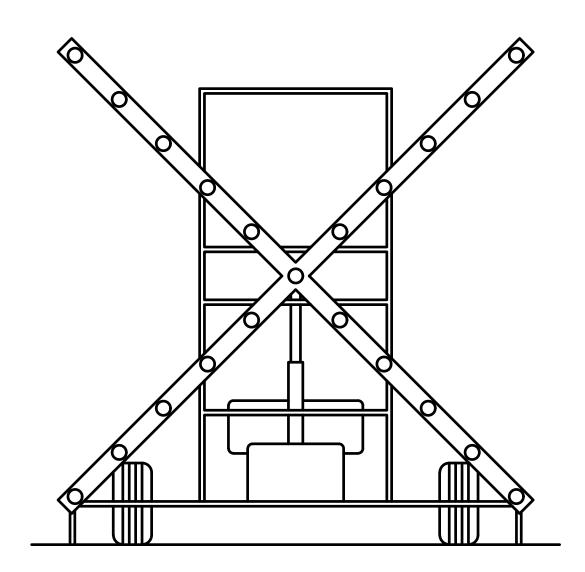
MAN

CONSTRUCTION

SAFETY AND PHASING PLAN PHASE 2 BID SCHEDULE 3

SHEET NO.

20 OF 297




PORTABLE LIGHTED RUNWAY CLOSURE MARKER (LIGHTED 'X')

*CONTRACTOR PROVIDED, CONTRACTOR MAINTAINED

PORTABLE LIGHTED RUNWAY CLOSURE MARKERS (LIGHTED X) SHALL MEET ALL OF THE FOLLOWING CONDITIONS:

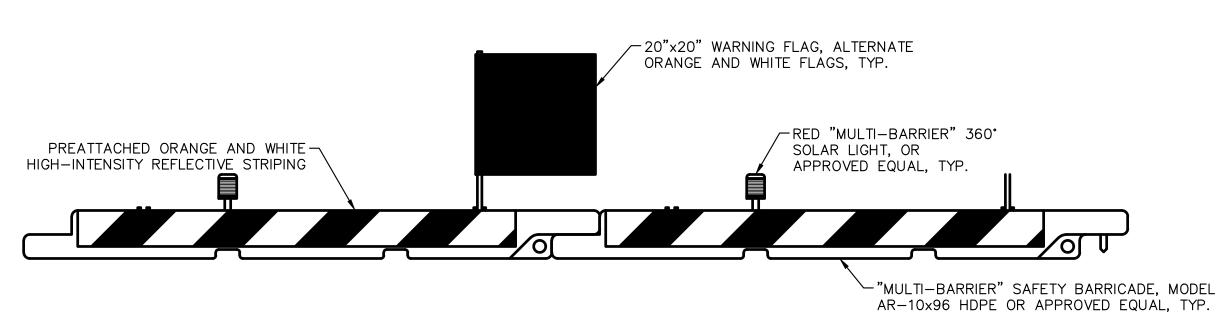
- 1. WILL BE PROVIDED BY THE CONTRACTOR. CONTRACTOR SHALL BE RESPONSIBLE FOR MAINTAINING THIS EQUIPMENT THROUGHOUT THE DURATION OF THE PROJECT. CONTRACTOR SHALL NOTIFY THE AIRPORT IMMEDIATELY IF ANY DISRUPTION TO THE LIGHTED RUNWAY CLOSURE MARKERS IS NOTICED DURING WORK HOURS.
- 2. THE CONTRACTOR SHALL POSITION LIGHTED X'S AT RUNWAY ENDS FOR CLOSURES ON THE RUNWAY NUMERALS AND REMOVE X'S TO THE STAGING AREAS WHEN NOT IN USE. FUEL OIL, REPLACEMENT BULBS AND ALL MAINTENANCE SHALL BE PROVIDED BY THE CONTRACTOR.




TYPE 1 - LOW PROFILE BARRICADE (LINKED)

LOW PROFILE BARRICADES SHALL MEET ALL OF THE FOLLOWING CONDITIONS:

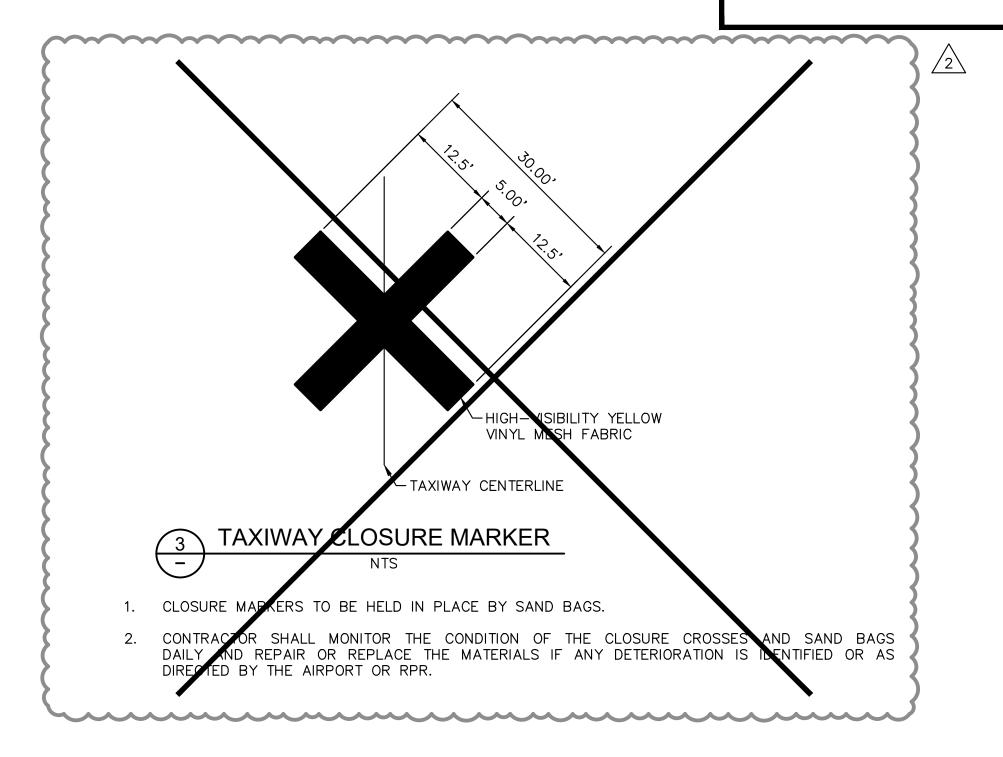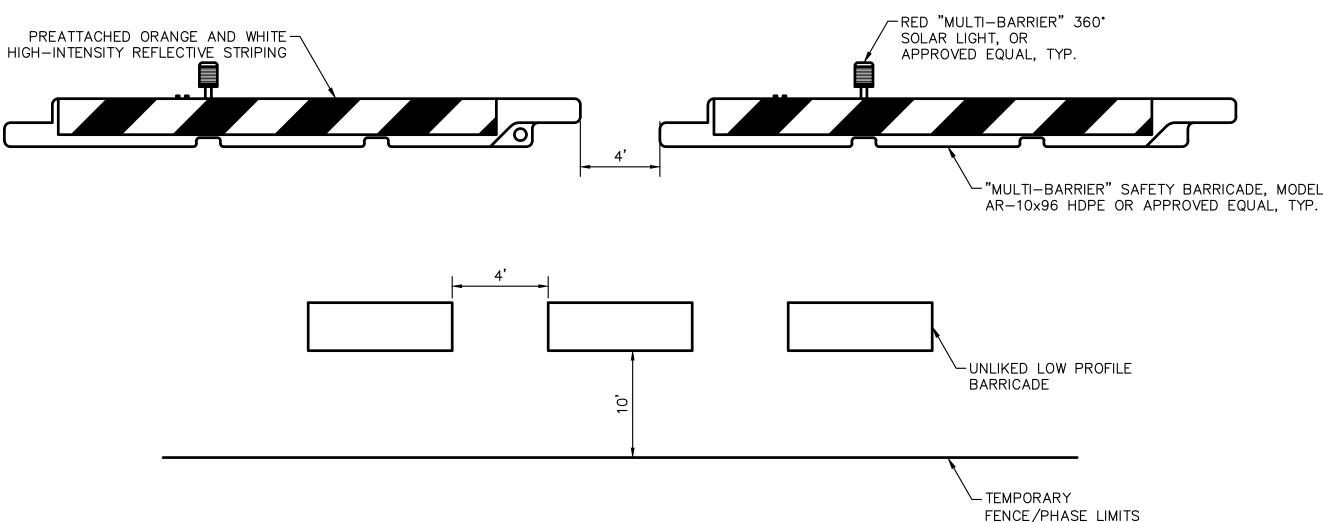- 1. THE CONTRACTOR SHALL BE RESPONSIBLE FOR HAVING ENOUGH BARRICADES ON SITE FOR EACH PHASE AS THEY PROGRESS. IT IS THE CONTRACTOR'S RESPONSIBILITY TO RELOCATE ALL BARRICADES BETWEEN PHASES.
- 2. THE CONTRACTOR SHALL PROVIDE AND MAINTAIN LOW PROFILE BARRICADES, LIGHTS AND FLAGS FOR RUNWAY/TAXIWAY CLOSURES AS INDICATED ON THE CONSTRUCTION PHASING PLANS. THE CONTRACTOR SHALL BE RESPONSIBLE FOR MAINTAINING PROPER POSITIONING OF LOW PROFILE BARRICADES THROUGHOUT THE DURATION OF THE PROJECT AND SHALL REMOVE THE LOW PROFILE BARRICADES UPON COMPLETION.
- 3. LOW PROFILE BARRICADES LOCATED OUTSIDE OF ACTIVE RUNWAY SAFETY AND TAXIWAY OBJECT FREE AREAS, USED SOLELY TO CONTROL CONTRACTOR VEHICLE ROUTING MAY BE A TRAFFIC STYLE CONE OR BARRICADE AS APPROVED BY AIRPORT OPERATIONS AND THE ENGINEER.
- 4. LOW PROFILE BARRICADES SHALL BE CONNECTED.





TYPE 1 - LOW PROFILE BARRICADE (UNLINKED) NTS

LOW PROFILE BARRICADES SHALL MEET ALL OF THE FOLLOWING CONDITIONS:

- 1. THE CONTRACTOR SHALL BE RESPONSIBLE FOR HAVING ENOUGH BARRICADES ON SITE FOR EACH PHASE AS THEY PROGRESS. IT IS THE CONTRACTOR'S RESPONSIBILITY TO RELOCATE ALL BARRICADES BETWEEN PHASES.
- 2. THE CONTRACTOR SHALL PROVIDE AND MAINTAIN LOW PROFILE BARRICADES, LIGHTS AND FLAGS FOR RUNWAY/TAXIWAY CLOSURES AS INDICATED ON THE CONSTRUCTION PHASING PLANS. THE CONTRACTOR SHALL BE RESPONSIBLE FOR MAINTAINING PROPER POSITIONING OF LOW PROFILE BARRICADES THROUGHOUT THE DURATION OF THE PROJECT AND SHALL REMOVE THE LOW PROFILE BARRICADES UPON COMPLETION.
- 3. LOW PROFILE BARRICADES LOCATED OUTSIDE OF ACTIVE RUNWAY SAFETY AND TAXIWAY OBJECT FREE AREAS, USED SOLELY TO CONTROL CONTRACTOR VEHICLE ROUTING MAY BE A TRAFFIC STYLE CONE OR BARRICADE AS APPROVED BY AIRPORT OPERATIONS AND THE ENGINEER.
- 4. LOW PROFILE BARRICADES SHALL BE DISCONNECTED.

Quonset State Airport

State Airpor

QUONSET STATE AIRPORT

150 AIRPORT STREET

NORTH KINGSTOWN, RI 02852

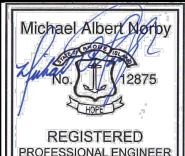
PHONE: (401) 691-2000

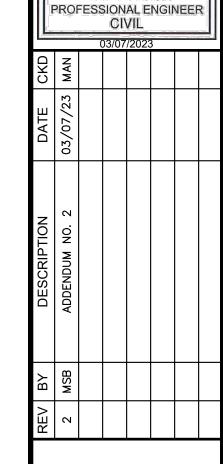
Kimley » Hor

KIMLEY-HORN AND ASSOCIATES, IN 404 WYMAN STREET SUITE 385 WALTHAM, MA 02451 PHONE: (781) 328-0676



PROVIDENCE, RI 02903





QUONSET STATE AIRPORT
RHODE ISLAND AIRPORT CORPORATION
NORTH KINGSTOWN, RHODE ISLAND
RUNWAY 16-34 RECONSTRUCTIO

DATE	03/07/2023
DESIGNED BY	MAN
DRAWN BY	MSB
CHECKED BY	MAN
PROJECT NO.	112214003

FILE NO. CZ-112214003

AIP NO. 0-00-0000-0000-0000

SHEET TITLE

CONSTRUCTION
SAFETY AND
PHASING DETAILS

23 OF 297

SHEET NO.

S35°03'04.80"E RUNWAY 16-34 STA. 126+49.00 = - Ç RUNWAY 16-34 TAXIWAY A1 STA. 20+00.00 ←PC STA. 127+67.50 83.00' RT. ∠PC STA. 125+30.50 83.00' RT. STA. 124+86.50 -_STA. 128+11.50 75.00' RT. — 75.00'RT. STA. 124+86.50 — STA. 128+11.50 83.00' RT. 19+00 + – 83.00'RT. PC STA. 124+86.50 -−PC STA. 128+11.50 100.00' RT. 100.00' RT. Ç TAXIWAY A1 ←PCC STA. 126+86.52 197.61'RT. PCC STA. 125+86.47 197.64'RT. ·18+00[·] ─PCC STA. 127+11.53 197.64'RT. PCC STA. 126+11.48-197.61' RT. -PT STA. 128+36.50 320.00' RT. PT STA. 125+24.10 ─ PT STA. 128+36.50 · 17+00 + 303.20' RT. 345.00' RT. _STA. 128+86.50 ∕-STA. 129+54.00 STA. 126+63.87 ∕−STA. 132+18.00 325.00' RT. 325.00' RT. 375.00' RT. - 325.00' RT. ——— STA. 124+65.05 → ÷STA. 126+79.69 STA. 128+44.50 -PT STA. 125+36.62 337.36' RT. 345.00' RT. 367.00' RT. 324.83' RT. STA. 124+77.57 - ←STA. 127+09.49 STA. 129+54.00 -STA. 132+18.00 359.00' RT. . 367.00' RT. 345.00' RT. 345.00' RT. STA. 124+69.57 363.63' RT. STA. 124+69.57 — STA. 128+36.50 STA. 128+44.50 STA. 124+77.57 375.00' RT. 375.00' RT. 367.00' RT. 367.00' RT. _STA. 127+13.53 ₌ 375.00' RT. STA. 126+27.08-∽STA. 126+76.74 425.00' RT. 425.00' RT. STA. 126+37.01-∽STA. 126+66.81 425.00' RT. 425.00' RT.

ADDENDUM NO. 2

03/07/2023

LEGEND

1 FULL-DEPTH CEMENT CONCRETE PAVEMENT SECTION

FULL-DEPTH ASPHALT MIX PAVEMENT SECTION ASPHALT MIX PAVEMENT TRANSITION PER DETAIL 9, SHEET C11.3

4 ASPHALT MIX PAVEMENT TRANSITION (VARIABLE DEPTH)

5 FULL-DEPTH ASPHALT MIX PAVEMENT SECTION PER OPTION A OR CEMENT CONCRETE PAVEMENT SECTION PER OPTION B

6 TRANSITION SLAB PER DETAIL 10, SHEET C11.3 (7) EXISTING TRANSITION SLAB PER DETAIL 1, SHEET C6.10

ASPHALT MIX SHOULDER OR ACCESS ROAD PAVEMENT SECTION

(9) UNPAVED ACCESS ROAD OR SHOULDER SECTION

(10)

SURVEY CONTROL MONUMENT PER DETAIL 1, SHEET

GENERAL NOTES

- REFER TO PROJECT LAYOUT PLANS, SHEETS C1.11 THROUGH C1.13.
- REFER TO HORIZONTAL AND VERTICAL CONTROL PLAN, SHEET C1.14.
- REFER TO TYPICAL SECTIONS (SERIES C5) FOR PAVEMENT STRUCTURAL SECTIONS.
- 4. STATION AND OFFSET INFORMATION REFERENCES RUNWAY 16-34 CENTERLINE.

	CUR\	/E TABLE	
CURVE	LENGTH	RADIUS	DELTA
C56	149.00'	125.00'	68° 17' 47.49"
C57	154.72'	100.00'	88° 38' 50.33"
C58	149.00'	125.00'	68° 17' 47.49"
C59	154.72'	100.00'	88° 38' 50.33"
C60	154.33'	150.00'	58° 56' 54.26"
C61	128.14'	125.00'	58° 44′ 13.25″
C62	233.01'	150.00'	89° 00' 05.47"
C63	193.71'	125.00'	88° 47' 24.46"







State Airport QUONSET STATE AIRPORT 150 AIRPORT STREET NORTH KINGSTOWN, RI 02852


Kimley Horn

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PHONE: (401) 691-2000



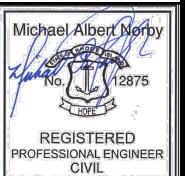SUITE 400 PROVIDENCE, RI 02903



		(03/07	/2023	3	
CKD	MAN					
DATE	03/07/23 MAN					
DESCRIPTION	ADDENDUM NO. 2					
ВУ	MPB					
REV BY	2					

QUONSET S' RHODE ISLAND AIF NORTH KINGSTC RUNWAY 16-34 F

DATE	03/07/2023
DESIGNED BY	MPB
DRAWN BY	ACR
CHECKED BY	MAN
PROJECT NO.	112214003
	112211002

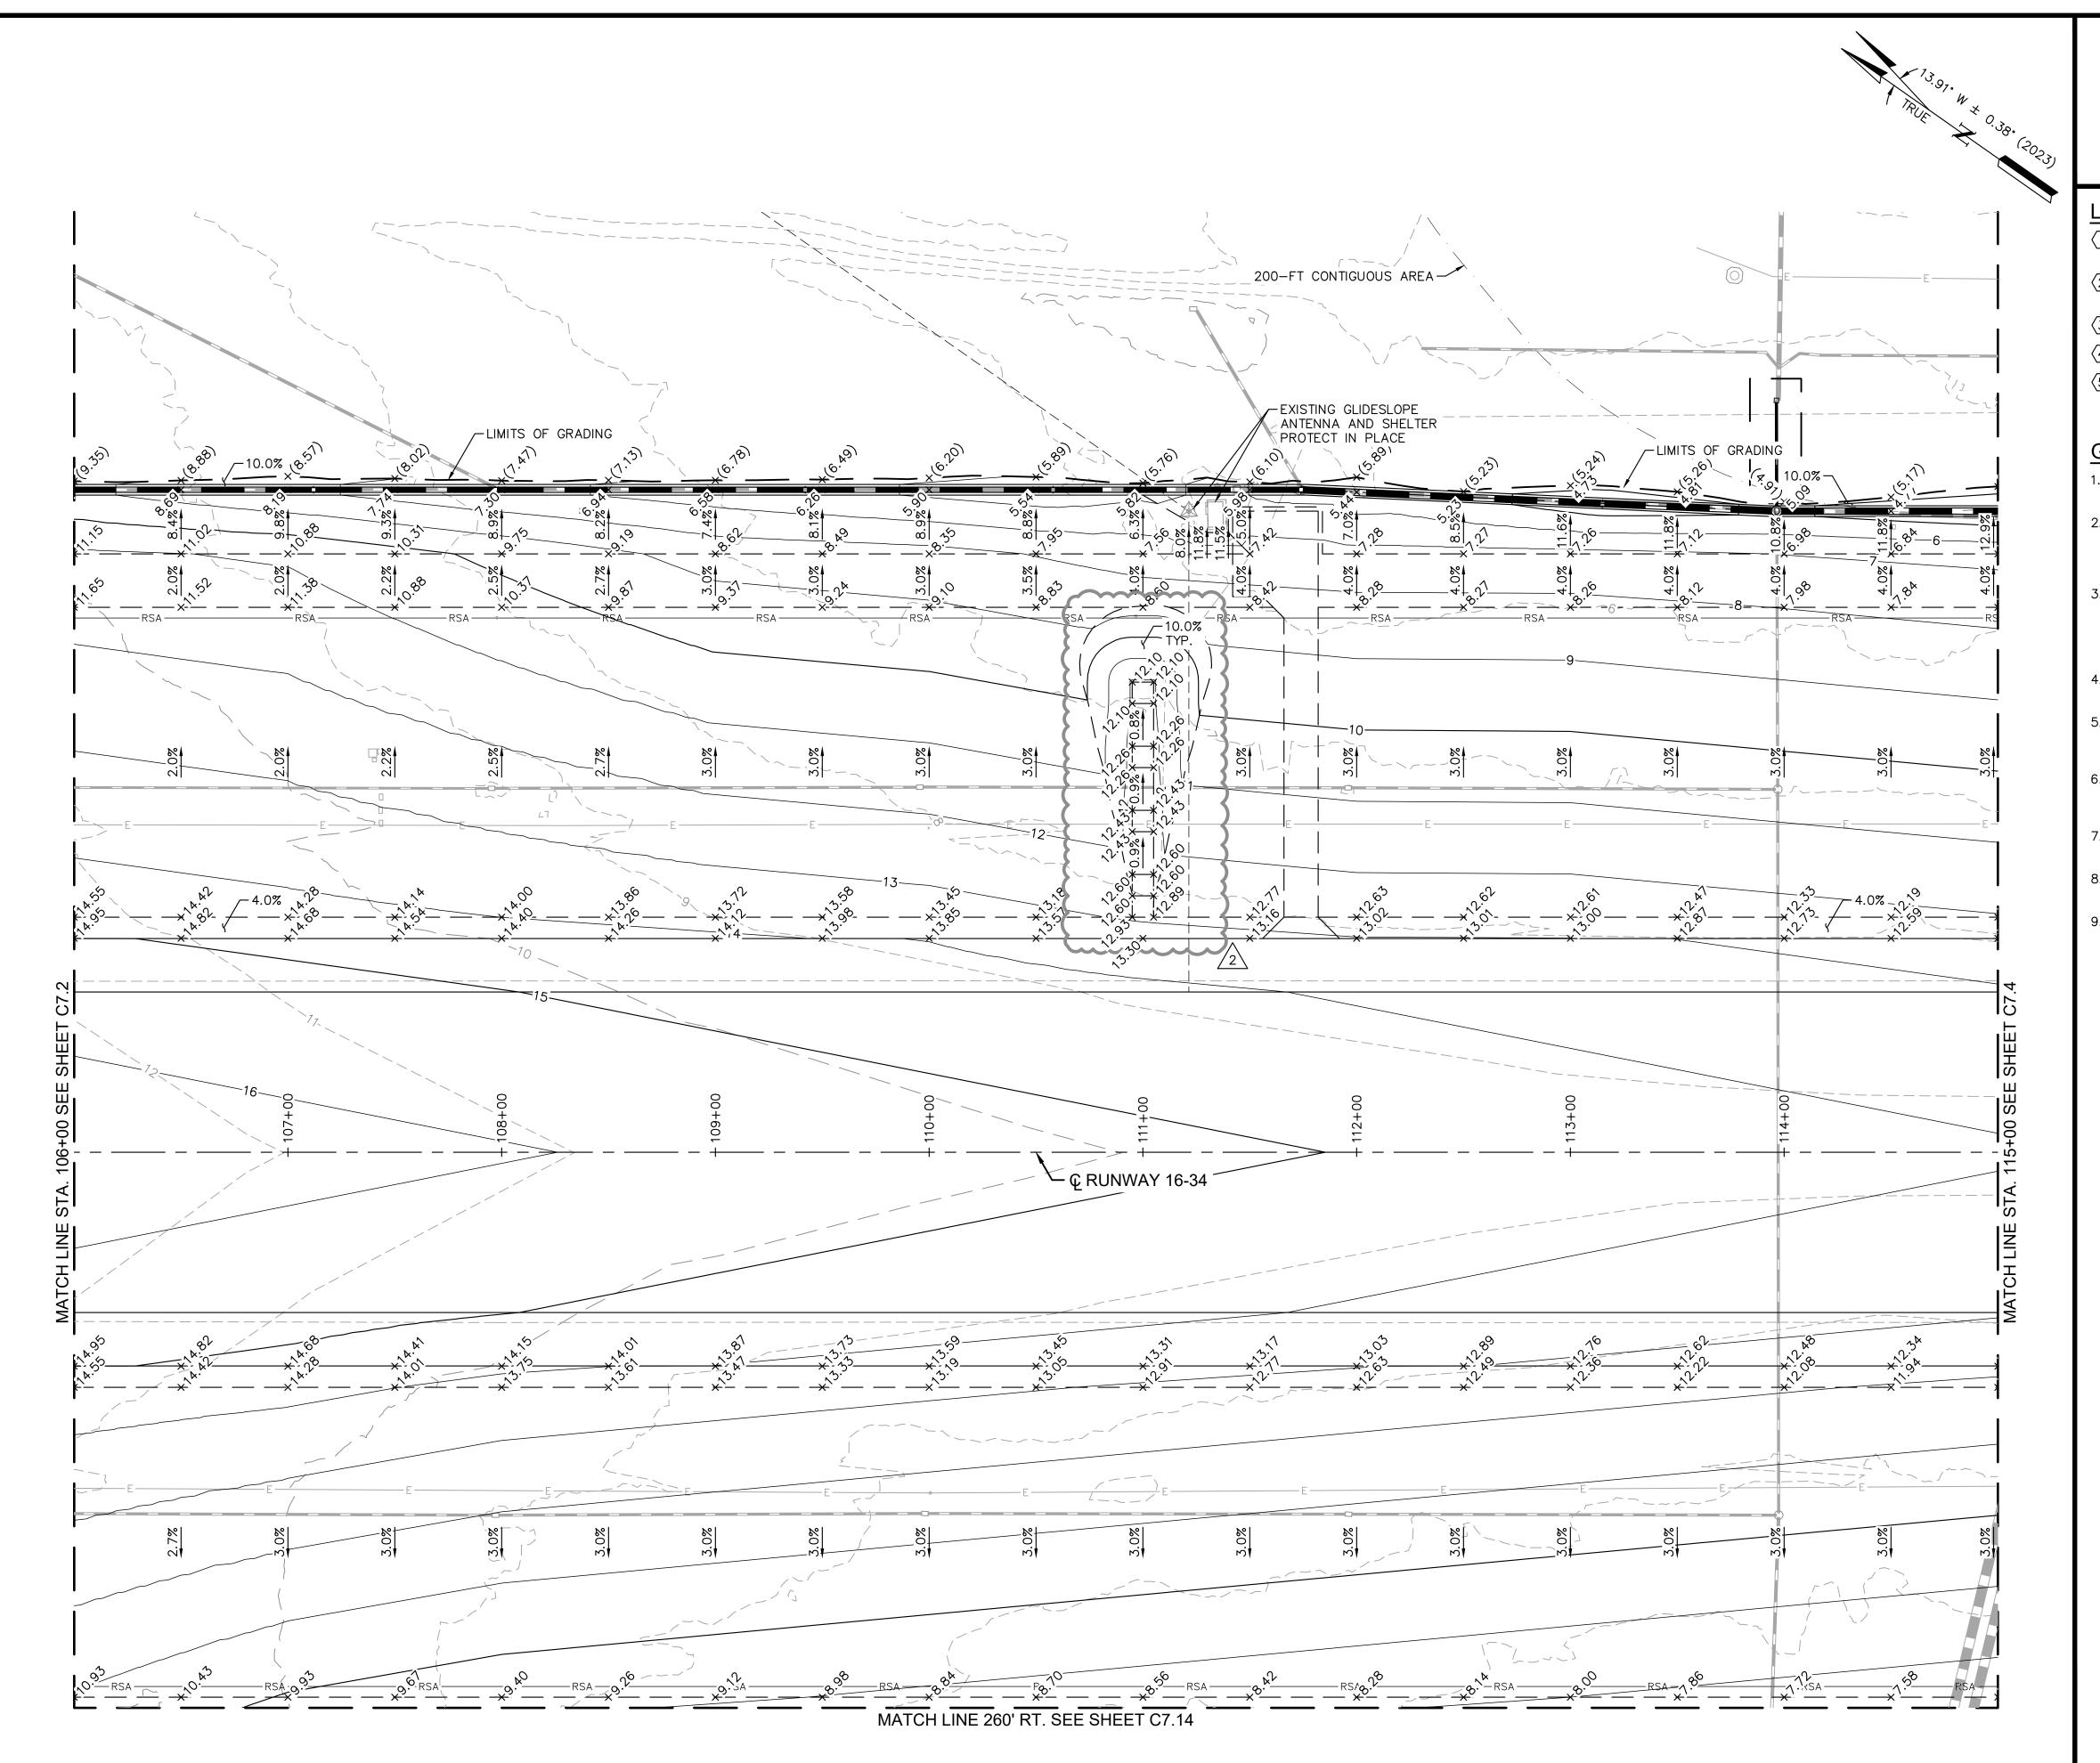
FILE NO. GL03-112214003 AIP NO. 0-00-0000-000-0000

SHEET TITLE **GEOMETRIC**

LAYOUT PLAN BID SCHEDULES 1 AND 2 STA. 124+00 TO STA. 133+00

SHEET NO. C6.12

70 OF 297



03/07/2023

LEGEND

- (1)
 SURVEY CONTROL MONUMENT PER DETAIL 1, SHEET

- (5) PROPOSED UTILITY SLEEVE (TWENTY-INCH (20") STAINLESS STEEL, CAPPED AT BOTH ENDS)
- REFER TO PROJECT LAYOUT PLANS, SHEETS C1.11 THROUGH C1.13.
- THE LIMITS OF SCHEDULE 3 ARE SHOWN HEREIN, HOWEVER, SCHEDULE 3 IS NOT PART OF THIS CONTRACT. REFER TO SCHEDULE 1 AND SCHEDULE 2 PLANS AS
- THE CONTRACTOR SHALL VERIFY AND MATCH EXISTING ELEVATIONS WHERE APPLICABLE AND NOTIFY THE ENGINEER IMMEDIATELY OF ANY DISCREPANCIES BETWEEN THE ELEVATIONS SHOWN HEREON AND THOSE FOUND IN THE FIELD.
- SHOWN AS SUPPLEMENTAL INFORMATION ONLY.
- EXPOSED SUBGRADE AND BASE MATERIAL SHALL BE KEPT MOIST, COMPACTED AND TREATED WITH A DUST PALLIATIVE STABILIZER TO MINIMIZE FOD FROM JET BLAST.
- DRAINAGE DETAILS.
- LIGHTING AND SIGNAGE SYSTEMS (NOT SHOWN).
- 16-34 CENTERLINE.

0 40 SCALE IN FEET

Know what's below.
Call before you dig.

ADDENDUM NO. 2

- (2) PROPOSED STORM DRAIN SYSTEM, REFER TO STORM DRAIN PLANS (SERIES C8)
- $\langle 3 \rangle$ ADJUST EXISTING STRUCTURE TO GRADE
- 4 PROTECTION EXISTING FACILITY IN PLACE

GENERAL NOTES

- DIRECTED.
- SPOT ELEVATIONS SHOWN ON FIFTY-FOOT (50') STATIONS ALONG RUNWAY 16-34 CENTERLINE.
- DESIGN CONTOURS REPRESENT FINISHED GRADE: CONTOURS, GRADES AND SLOPES ARE APPROXIMATE AND
- REFER TO STORM DRAIN PLANS (SERIES C8) FOR
- REFER TO ELECTRICAL PLANS (SERIES E) FOR AIRFIELD
- STATION AND OFFSET INFORMATION REFERENCES RUNWAY




150 AIRPORT STREET NORTH KINGSTOWN. RI 02852 PHONE: (401) 691-2000

Kimley » Horn

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		()3/07	/2023	3	
CKD	MAN					
DATE	03/07/23 MAN					
DESCRIPTION	ADDENDUM NO. 2					
ВУ	MPB					
REV BY	2					

03/07/2023 FILE NO. GD01-11221400

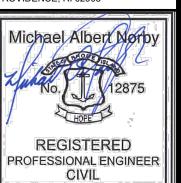
GRADING AND DRAINAGE PLAN

AIP NO. 0-00-0000-000-000

RUNWAY 16-34 BID SCHEDULE 3 STA. 106+00 TO STA. 115+00

SHEET NO.

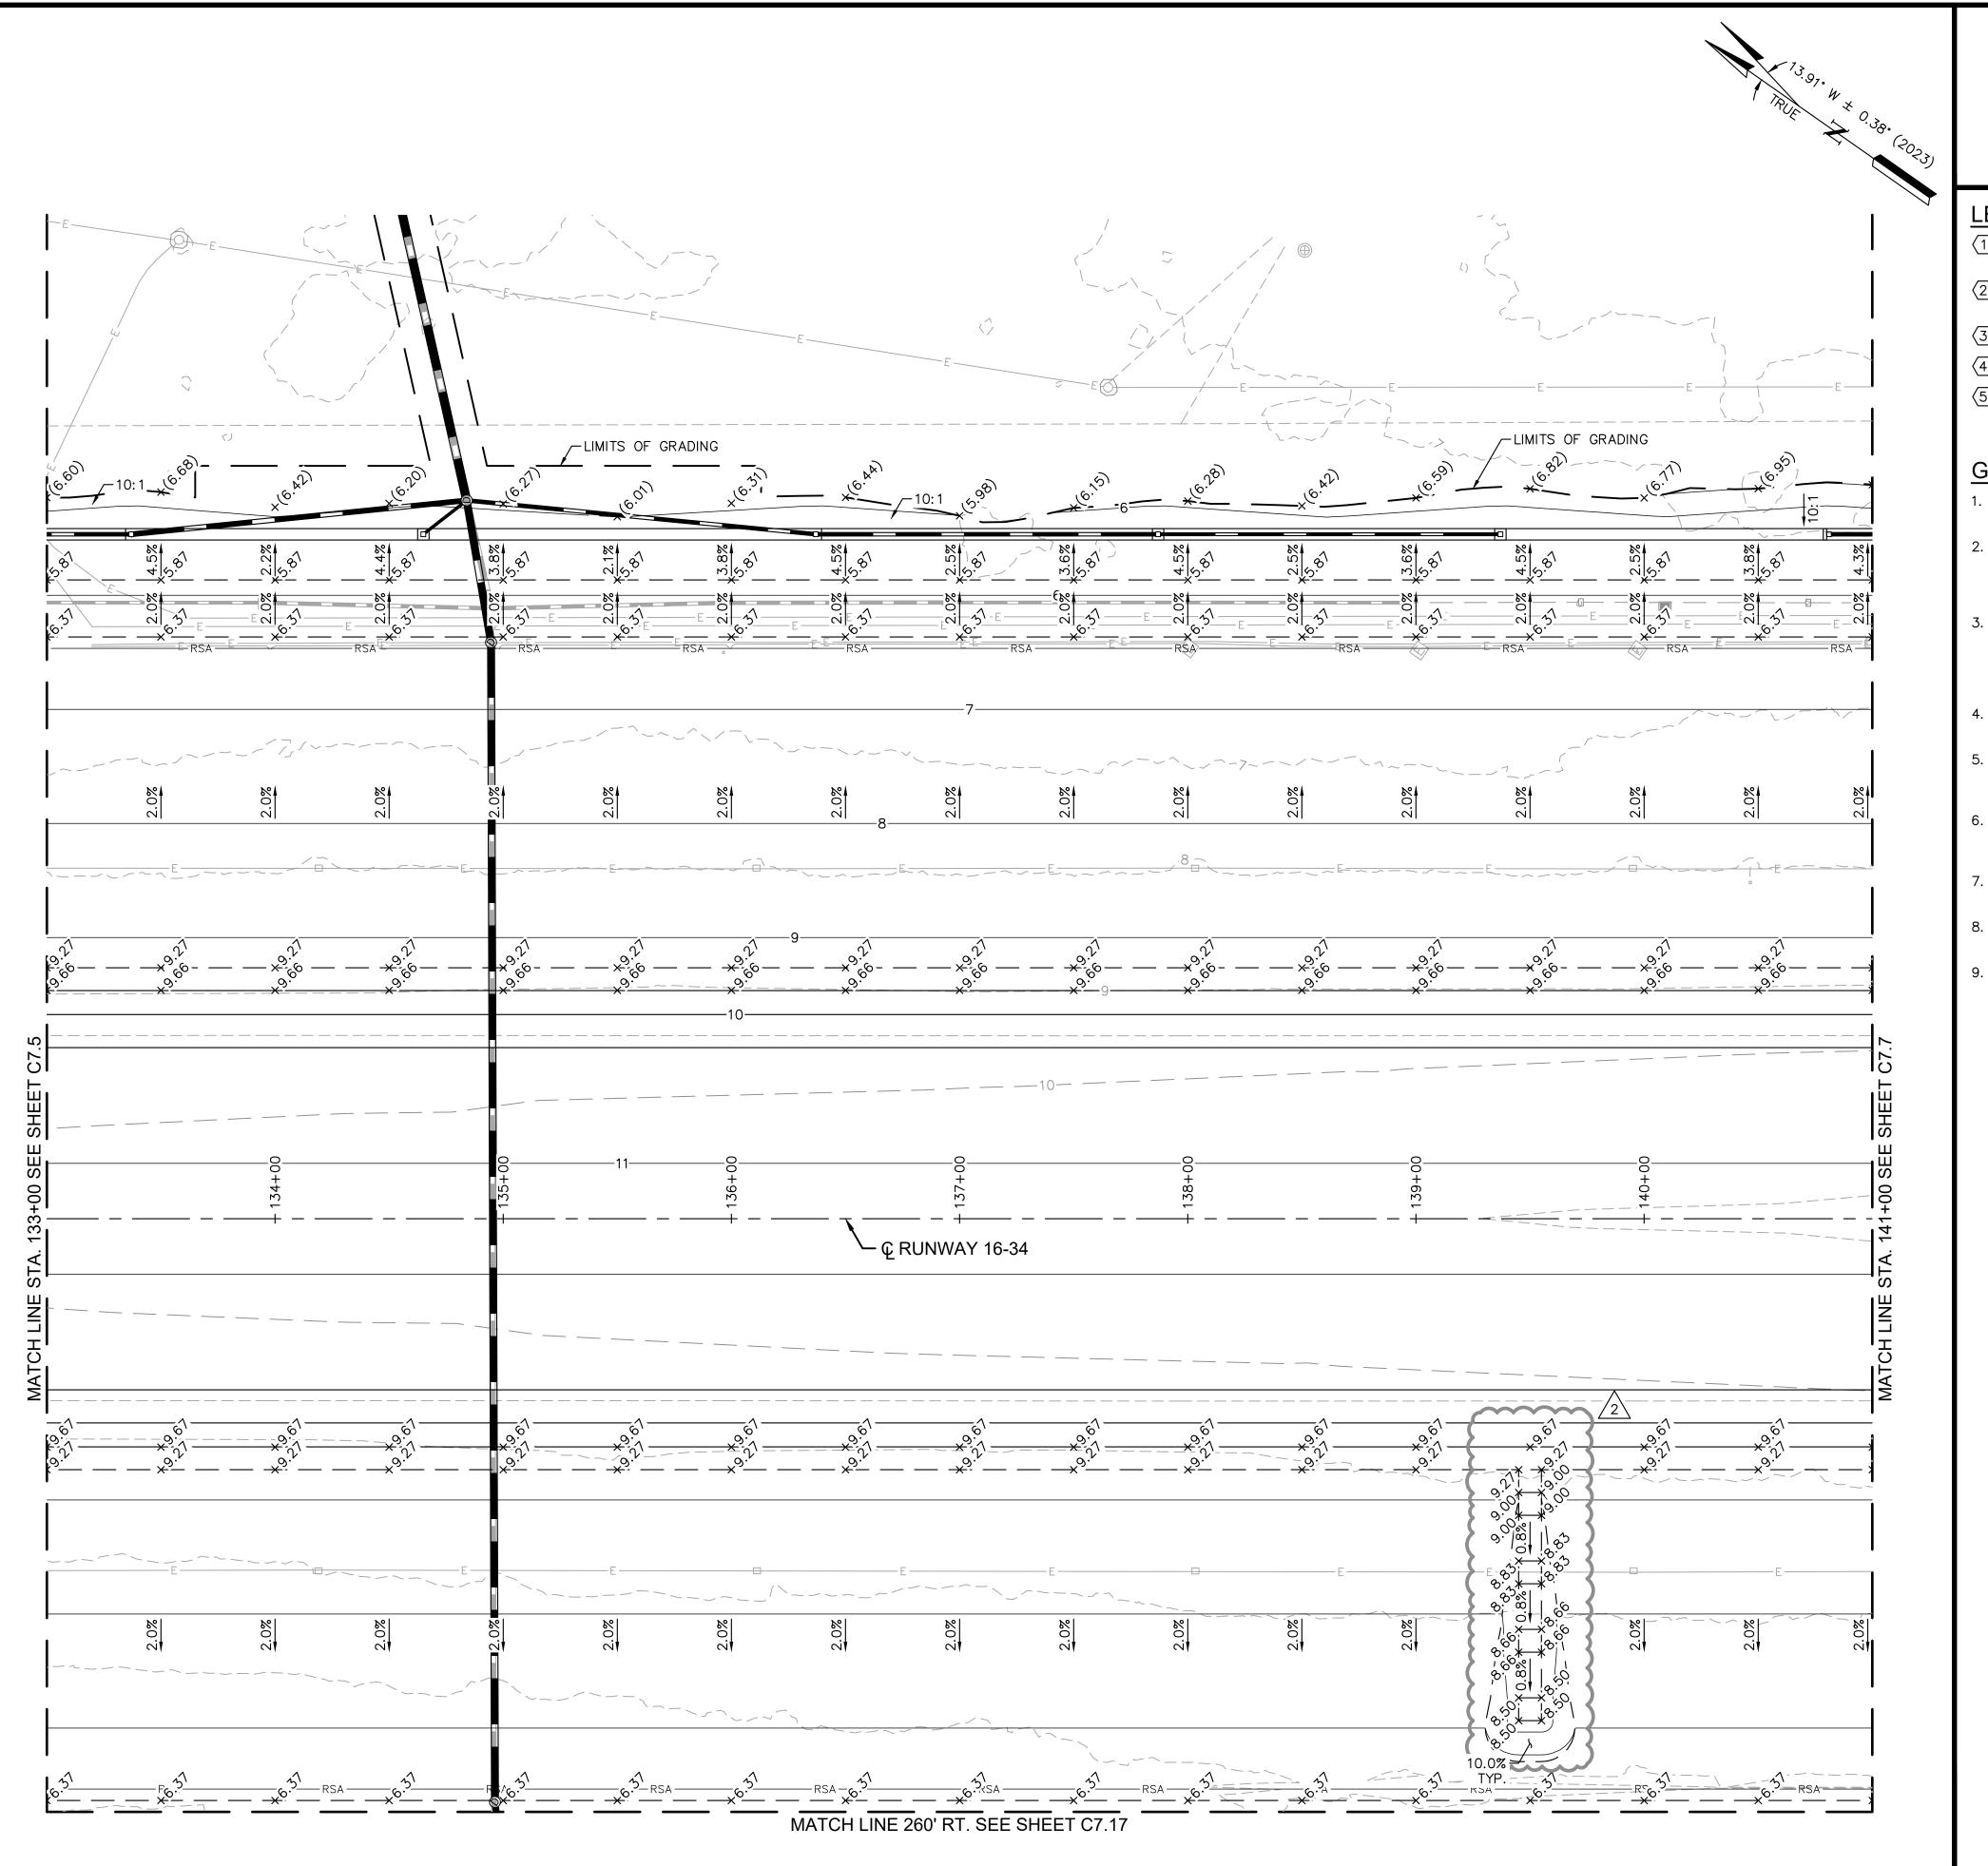C7.3 77 OF 297



LEGEND

- $\langle 2 \rangle$ PROPOSED STORM DRAIN SYSTEM, REFER TO STORM DRAIN PLANS (SERIES C8)
- 4 PROTECTION EXISTING FACILITY IN PLACE

- REFER TO PROJECT LAYOUT PLANS, SHEETS C1.11 THROUGH C1.13.
- THE LIMITS OF SCHEDULE 3 ARE SHOWN HEREIN, HOWEVER, SCHEDULE 3 IS NOT PART OF THIS CONTRACT. REFER TO SCHEDULE 1 AND SCHEDULE 2 PLANS AS DIRECTED.
- THE CONTRACTOR SHALL VERIFY AND MATCH EXISTING ELEVATIONS WHERE APPLICABLE AND NOTIFY THE ENGINEER IMMEDIATELY OF ANY DISCREPANCIES BETWEEN THE ELEVATIONS SHOWN HEREON AND THOSE FOUND IN
- SPOT ELEVATIONS SHOWN ON FIFTY-FOOT (50') STATIONS ALONG RUNWAY 16-34 CENTERLINE.
- CONTOURS, GRADES AND SLOPES ARE APPROXIMATE AND SHOWN AS SUPPLEMENTAL INFORMATION ONLY.
- MOIST, COMPACTED AND TREATED WITH A DUST PALLIATIVE STABILIZER TO MINIMIZE FOD FROM JET BLAST.
- DRAINAGE DETAILS.
- REFER TO ELECTRICAL PLANS (SERIES E) FOR AIRFIELD LIGHTING AND SIGNAGE SYSTEMS (NOT SHOWN).
- 16-34 CENTERLINE.

O 40 SCALE IN FEET

Know what's below.
Call before you dig.

- (1)

 SURVEY CONTROL MONUMENT PER DETAIL 1, SHEET
- $\langle 3 \rangle$ ADJUST EXISTING STRUCTURE TO GRADE
- 5 PROPOSED UTILITY SLEEVE (TWENTY-INCH (20") STAINLESS STEEL, CAPPED AT BOTH ENDS)

GENERAL NOTES

- DESIGN CONTOURS REPRESENT FINISHED GRADE:
- EXPOSED SUBGRADE AND BASE MATERIAL SHALL BE KEPT
- REFER TO STORM DRAIN PLANS (SERIES C8) FOR
- STATION AND OFFSET INFORMATION REFERENCES RUNWAY



QUONSET STATE AIRPORT 150 AIRPORT STREET NORTH KINGSTOWN. RI 02852 PHONE: (401) 691-2000


Kimley»Horn


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PHONE: (781) 328-0676







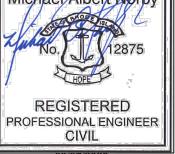

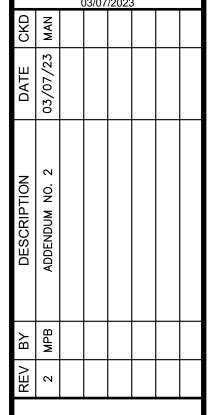03/07/2023 FILE NO. GD01-11221400


GRADING AND DRAINAGE PLAN

AIP NO. 0-00-0000-000-000

RUNWAY 16-34 BID SCHEDULE 3 STA. 133+00 TO STA. 141+00

SHEET NO.

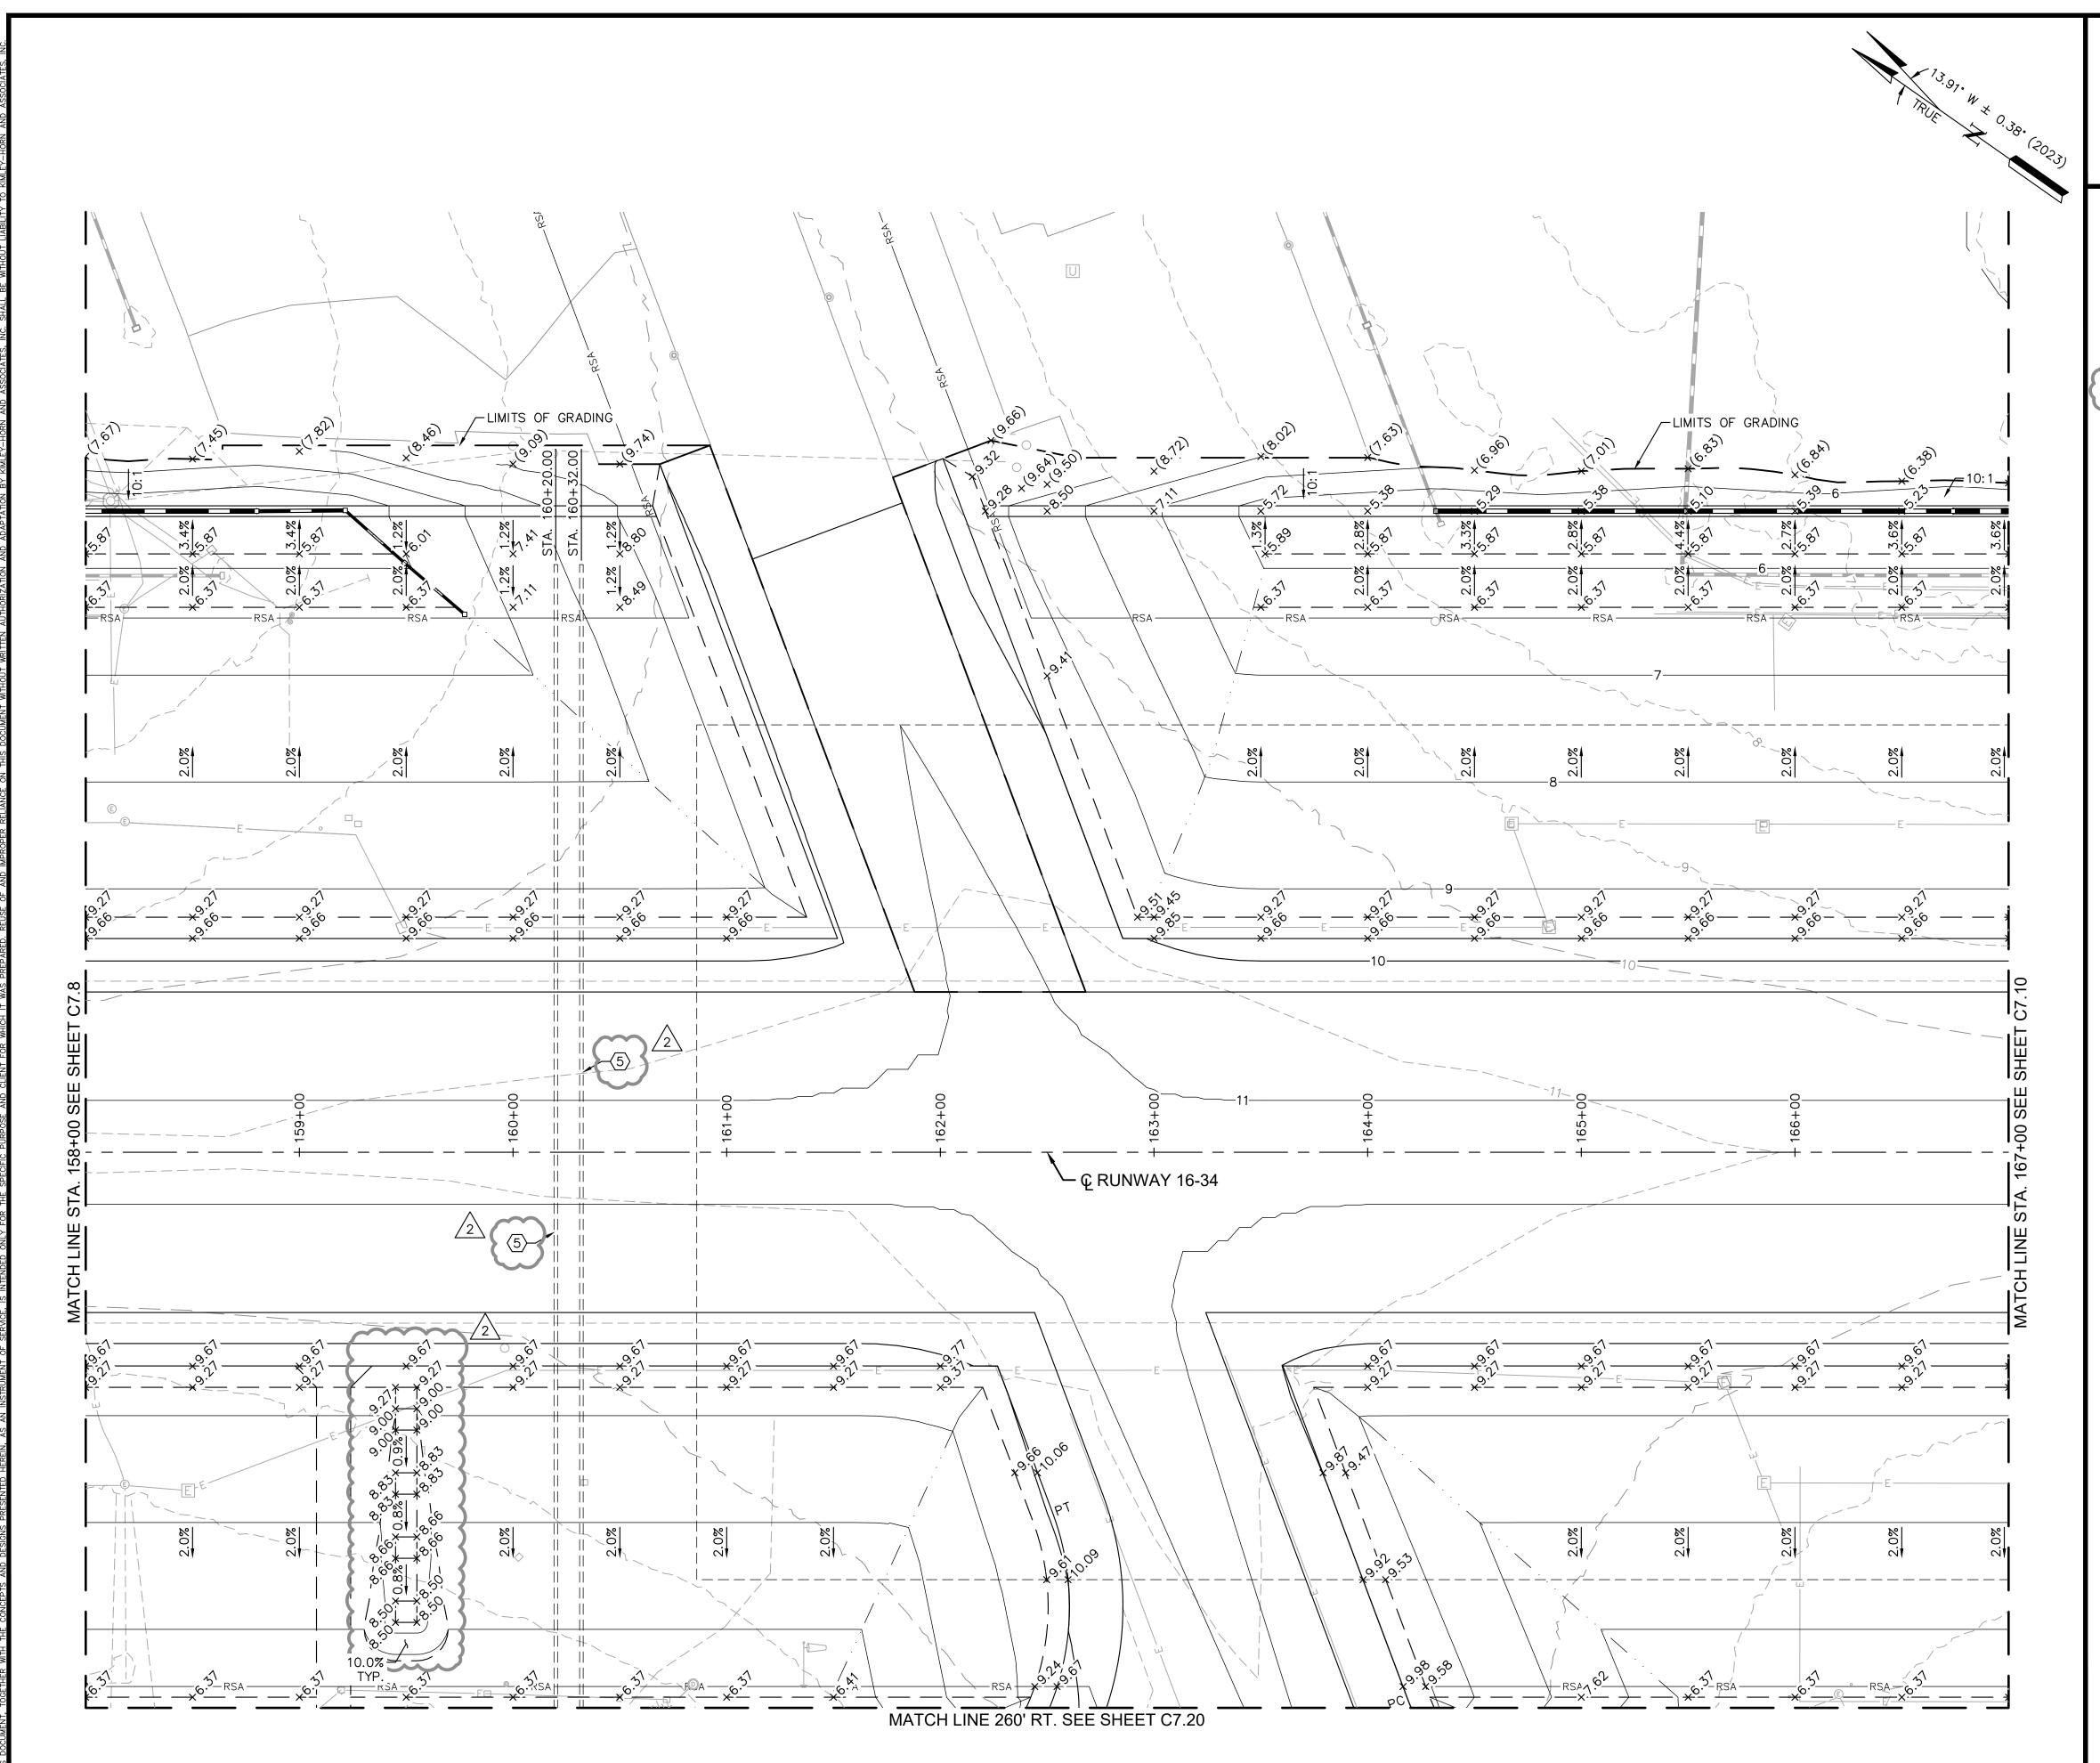C7.6 80 OF 297



03/07/2023

LEGEND

- (1) SURVEY CONTROL MONUMENT PER DETAIL 1, SHEET
- $\langle 2 \rangle$ PROPOSED STORM DRAIN SYSTEM, REFER TO STORM DRAIN PLANS (SERIES C8)
- $\langle 3 \rangle$ ADJUST EXISTING STRUCTURE TO GRADE
- 4 PROTECTION EXISTING FACILITY IN PLACE
- $\langle 5 \rangle$ PROPOSED UTILITY SLEEVE (TWENTY-INCH (20") STAINLESS STEEL, CAPPED AT BOTH ENDS)

GENERAL NOTES

- REFER TO PROJECT LAYOUT PLANS, SHEETS C1.11 THROUGH C1.13.
- THE LIMITS OF SCHEDULE 3 ARE SHOWN HEREIN, HOWEVER, SCHEDULE 3 IS NOT PART OF THIS CONTRACT. REFER TO SCHEDULE 1 AND SCHEDULE 2 PLANS AS DIRECTED.
- THE CONTRACTOR SHALL VERIFY AND MATCH EXISTING ELEVATIONS WHERE APPLICABLE AND NOTIFY THE ENGINEER IMMEDIATELY OF ANY DISCREPANCIES BETWEEN THE ELEVATIONS SHOWN HEREON AND THOSE FOUND IN
- SPOT ELEVATIONS SHOWN ON FIFTY-FOOT (50') STATIONS ALONG RUNWAY 16-34 CENTERLINE.
- DESIGN CONTOURS REPRESENT FINISHED GRADE: CONTOURS, GRADES AND SLOPES ARE APPROXIMATE AND SHOWN AS SUPPLEMENTAL INFORMATION ONLY.
- EXPOSED SUBGRADE AND BASE MATERIAL SHALL BE KEPT MOIST, COMPACTED AND TREATED WITH A DUST PALLIATIVE STABILIZER TO MINIMIZE FOD FROM JET BLAST.
- REFER TO STORM DRAIN PLANS (SERIES C8) FOR DRAINAGE DETAILS.
- REFER TO ELECTRICAL PLANS (SERIES E) FOR AIRFIELD LIGHTING AND SIGNAGE SYSTEMS (NOT SHOWN).
- STATION AND OFFSET INFORMATION REFERENCES RUNWAY 16-34 CENTERLINE.

O 40 SCALE IN FEET

Know what's below.
Call before you dig.

ADDENDUM NO. 2



QUONSET STATE AIRPORT 150 AIRPORT STREET


Kimley»Horn


State Airport

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VANASSE HANGEN BRUSTLIN, INC. 1 CEDAR STREET

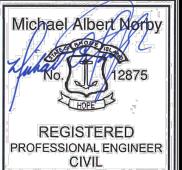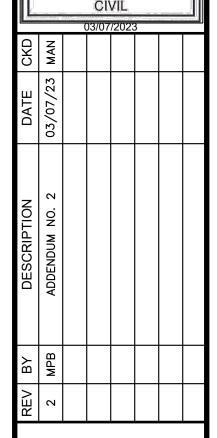SUITE 400 PROVIDENCE, RI 02903





DRAWN BY	AM
CHECKED BY	MA
PROJECT NO.	11221400
FILE NO. GD01-	-11221400
AIP NO. 0-00-000	0-000-000
SHEET TITLE	
GRADING	AND
DDVINACE	

DESIGNED BY


03/07/2023

DRAINAGE PLAN

RUNWAY 16-34 BID SCHEDULE 3 STA. 158+00 TO STA. 167+00

SHEET NO.

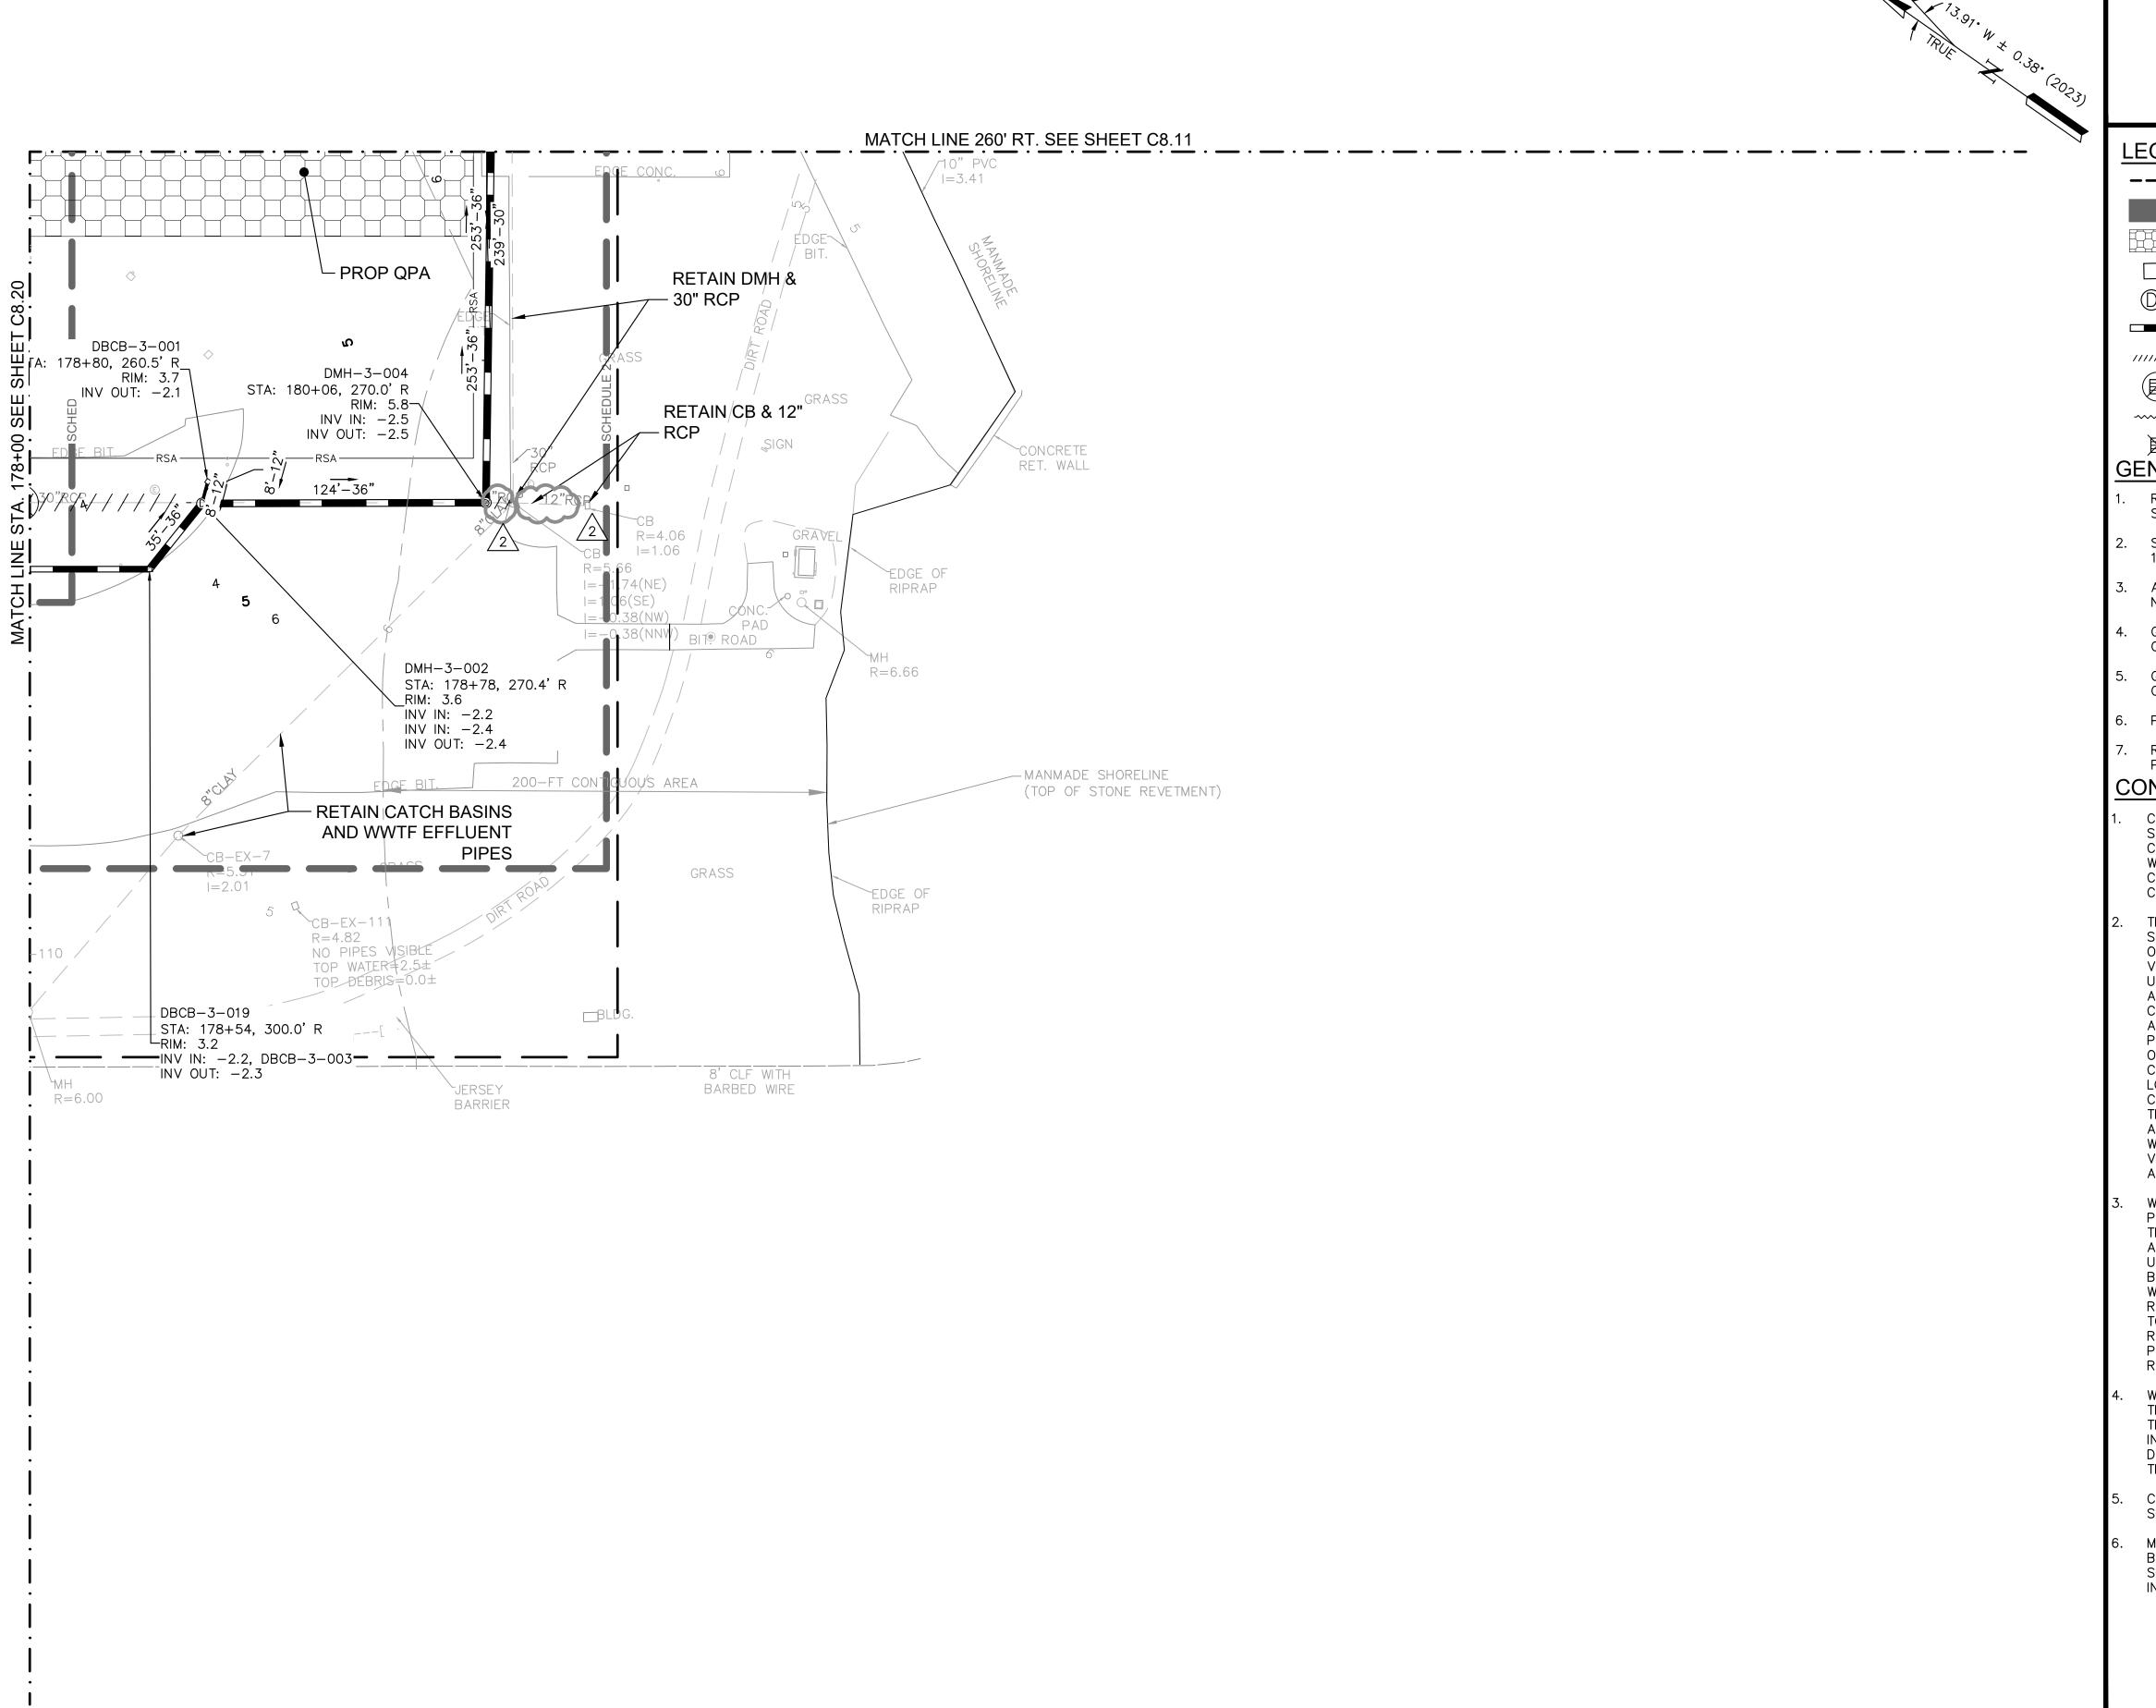C7.9 83 OF 297



LEGEND

--- LIMIT OF WORK

PROPOSED PAVEMENT LIMITS

QUALIFYING PERVIOUS AREA (QPA)

STORM DRAIN INLET (CB/DBCB/DI/DDI)

(D) DRAIN MANHOLE

DRAIN PIPE

////// DRAINAGE PIPE ABANDONED

(☑) DRAINAGE STRUCTURE ABANDONED

----- DRAINAGE PIPE REMOVED

DRAINAGE STRUCTURE REMOVED **GENERAL NOTES**

- REFER TO HORIZONTAL AND VERTICAL CONTROL PLAN, SHEET C1.14.
- STATION AND OFFSET INFORMATION REFERENCES RUNWAY 16-34 CENTERLINE.
- ALL PIPES SHALL BE CLASS V RCP UNLESS OTHERWISE
- GRADING PROVIDED BY KIMLEY HORN IN CAD FILE OFG-112214003.dwg.
- GRADING SHOWN FOR REFERENCE ONLY. REFER TO SHEETS C7.0 THROUGH C7.22 FOR ADDITIONAL DETAIL.
- PIPE BEDDING PER DETAIL ON SHEET C8.30.
- REFER TO SHEETS C4.0 THROUGH C4.22 DEMOLITION PLANS FOR DEMOLITION OF EXISTING DRAINAGE.

CONTRACTOR NOTES

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0 40 40 SCALE IN FEET



QUONSET STATE AIRPORT 150 AIRPORT STREET NORTH KINGSTOWN, RI 02852 PHONE: (401) 691-2000

Kimley»Horn

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KIMLEY-HORN AND ASSOCIATES, IN 404 WYMAN STREET SUITE 385 WALTHAM, MA 02451 PHONE: (781) 328-0676

VANASSE HANGEN BRUSTLIN, INC.

1 CEDAR STREET SUITE 400 PROVIDENCE, RI 02903

6517 (DA

REGISTERED

PROFESSIONAL ENGINEER 03/07/2023

E AIRPORT CORPORATIO HODE ISLAND NSTRUCT F STATE AIRPORT C STOWN, RH RECOI QUONSET RHODE ISLAND A NORTH KINGS JNWAY 16-34

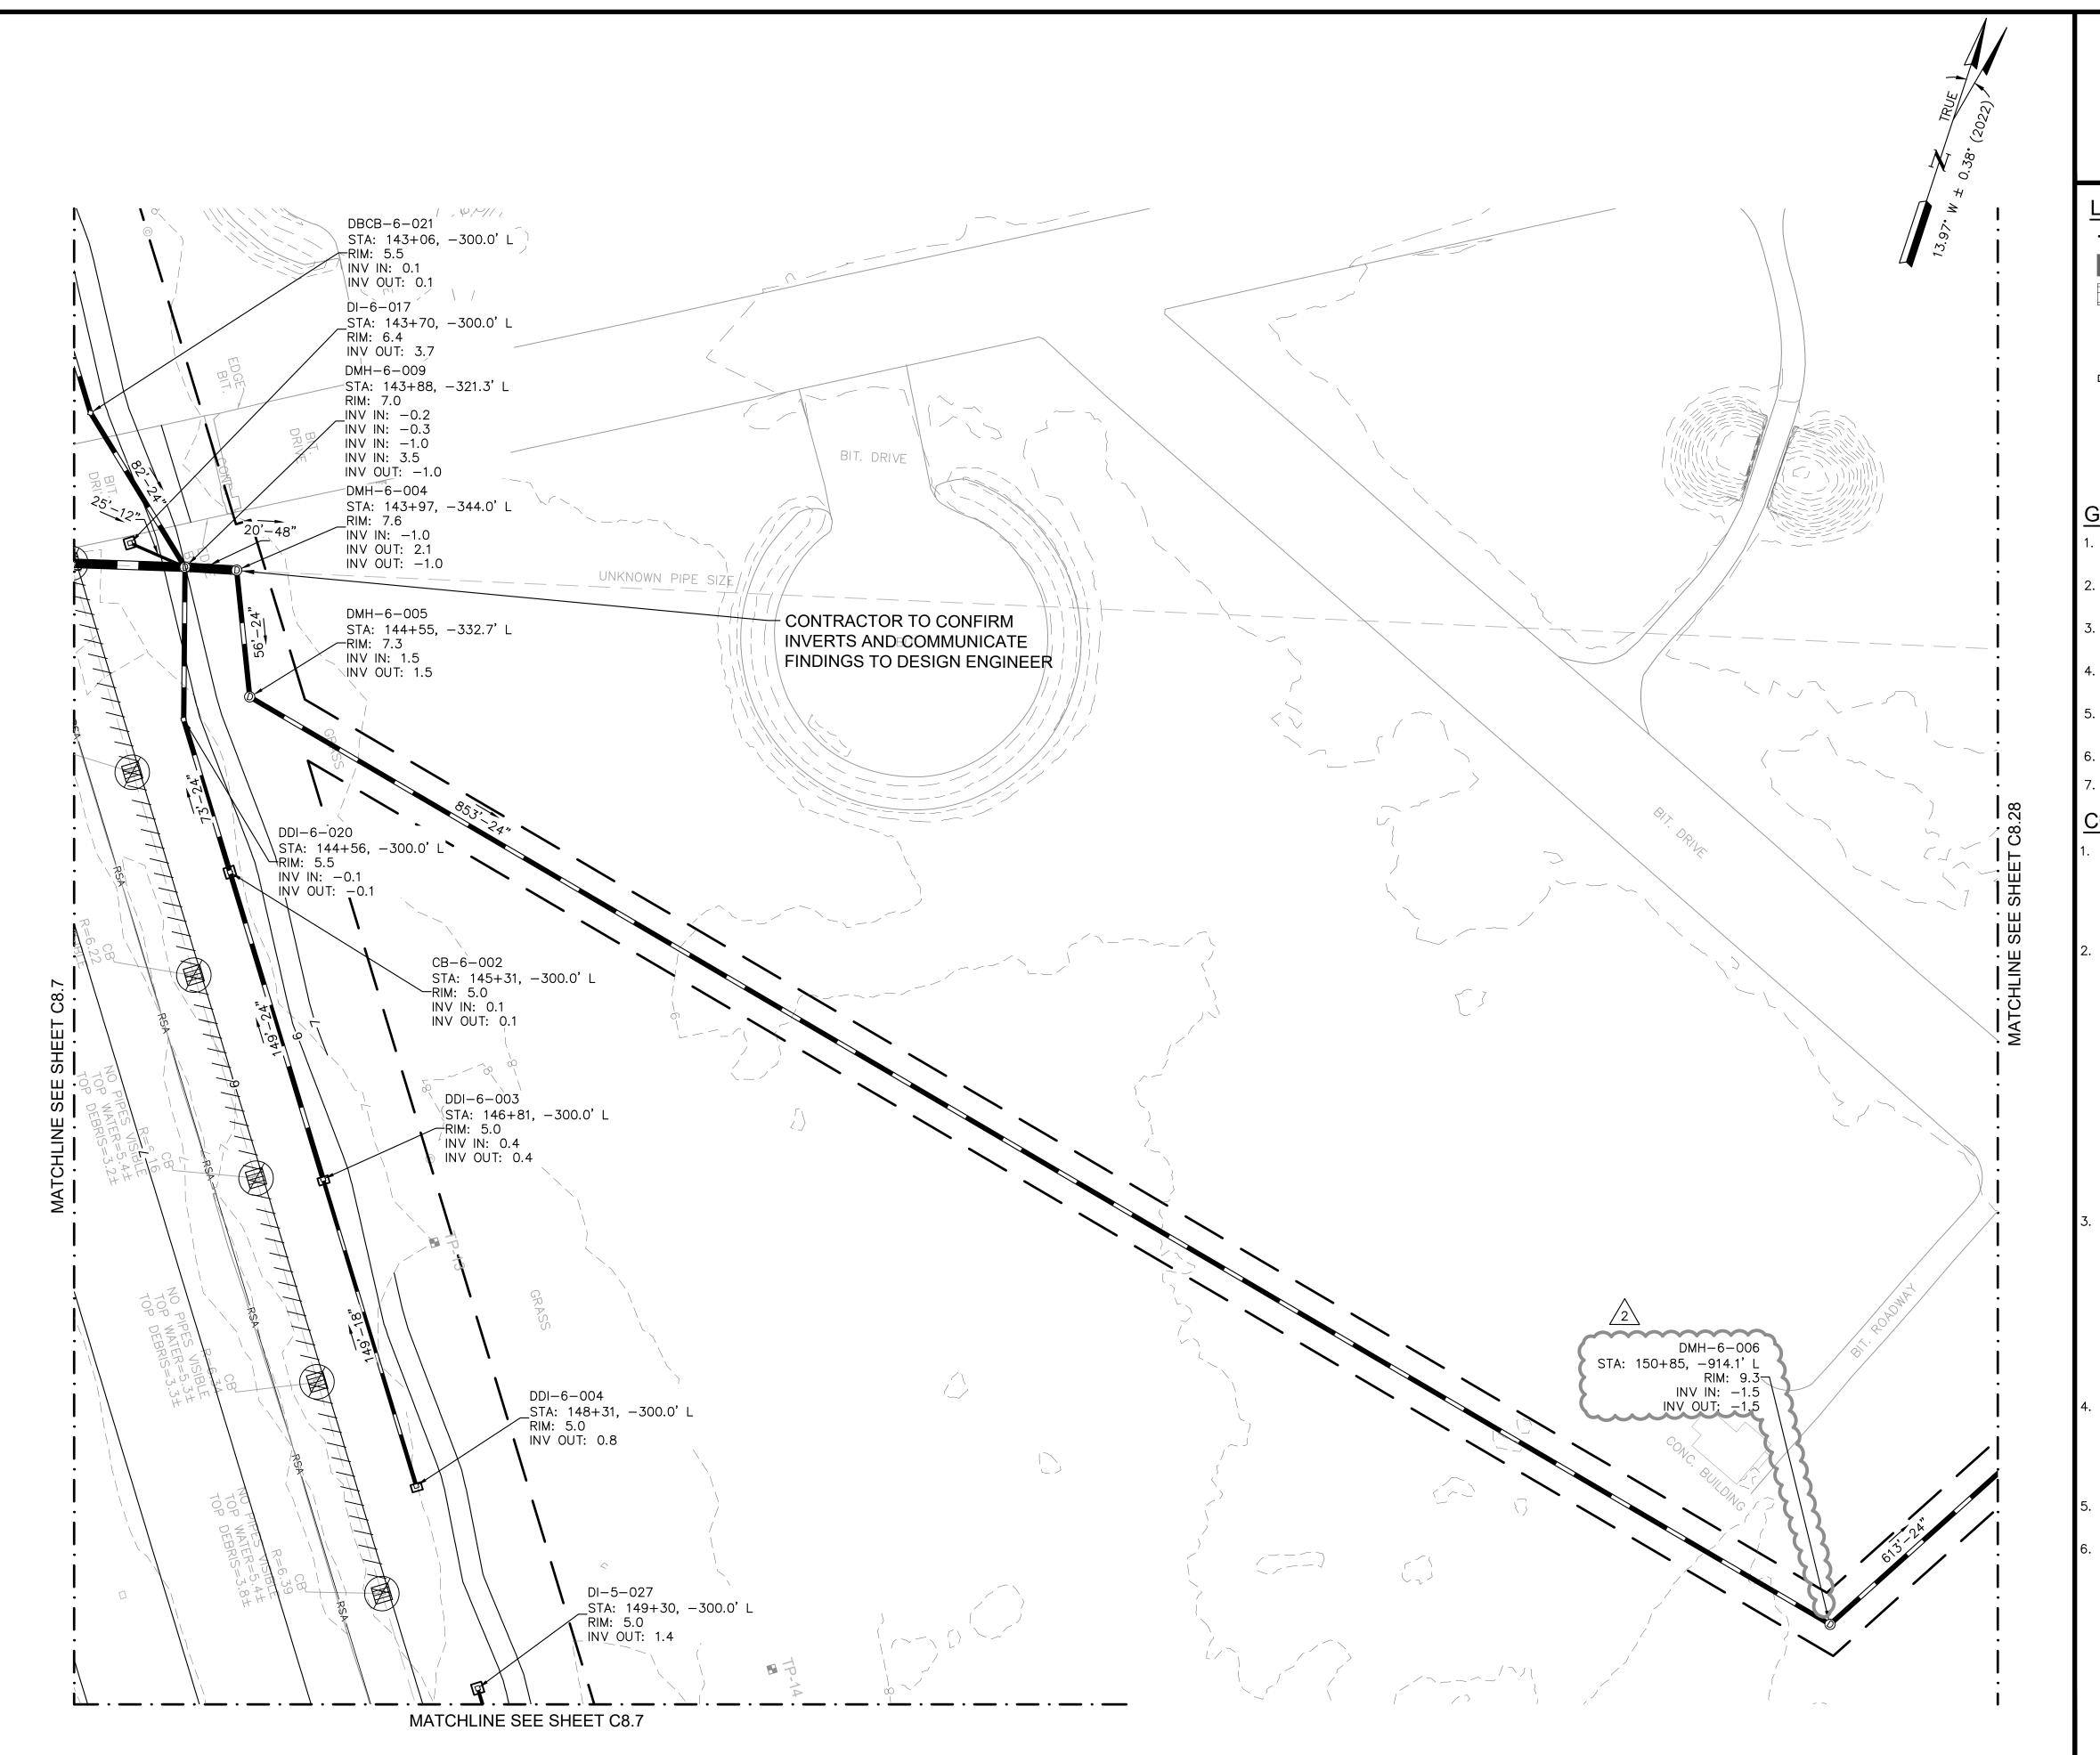
DATE 03/07/2023 DESIGNED BY DRAWN BY CHECKED BY PROJECT NO. 112214003 FILE NO. DR01-112214003 AIP NO. 0-00-0000-000-0000 SHEET TITLE

STORM DRAIN PLAN BID SCHEDULE 3

STA. 178+00 TO

STA. 187+00 SHEET NO.

C8.21 118 OF 297



LEGEND

--- LIMIT OF WORK

PROPOSED PAVEMENT LIMITS

QUALIFYING PERVIOUS AREA (QPA)

STORM DRAIN INLET (CB/DBCB/DI/DDI)

(D) DRAIN MANHOLE

DRAIN PIPE

////// DRAINAGE PIPE ABANDONED

(☑) DRAINAGE STRUCTURE ABANDONED

VIVIO DRAINAGE PIPE REMOVED

DRAINAGE STRUCTURE REMOVED GENERAL NOTES

REFER TO HORIZONTAL AND VERTICAL CONTROL PLAN, SHEET C1.14.

STATION AND OFFSET INFORMATION REFERENCES RUNWAY

- 16-34 CENTERLINE.
- ALL PIPES SHALL BE CLASS V RCP UNLESS OTHERWISE
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----40 SCALE IN FEET



QUONSET STATE AIRPORT NORTH KINGSTOWN, RI 02852

PHONE: (401) 691-2000

Kimley»Horn

KIMLEY-HORN AND ASSOCIATES, IN 404 WYMAN STREET SUITE 385 WALTHAM, MA 02451 PHONE: (781) 328-0676

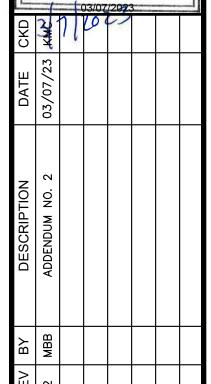
VANASSE HANGEN BRUSTLIN, INC

PROVIDENCE, RI 02903

1 CEDAR STREET SUITE 400

(R)

PROFESSIONAL ENGINEER



E AIRPORT CORPORATIO HODE ISLAND NSTRUCT STATE AIRPORT (STOWN, RH QUONSET RHODE ISLAND A NORTH KINGST RUNWAY 16-34

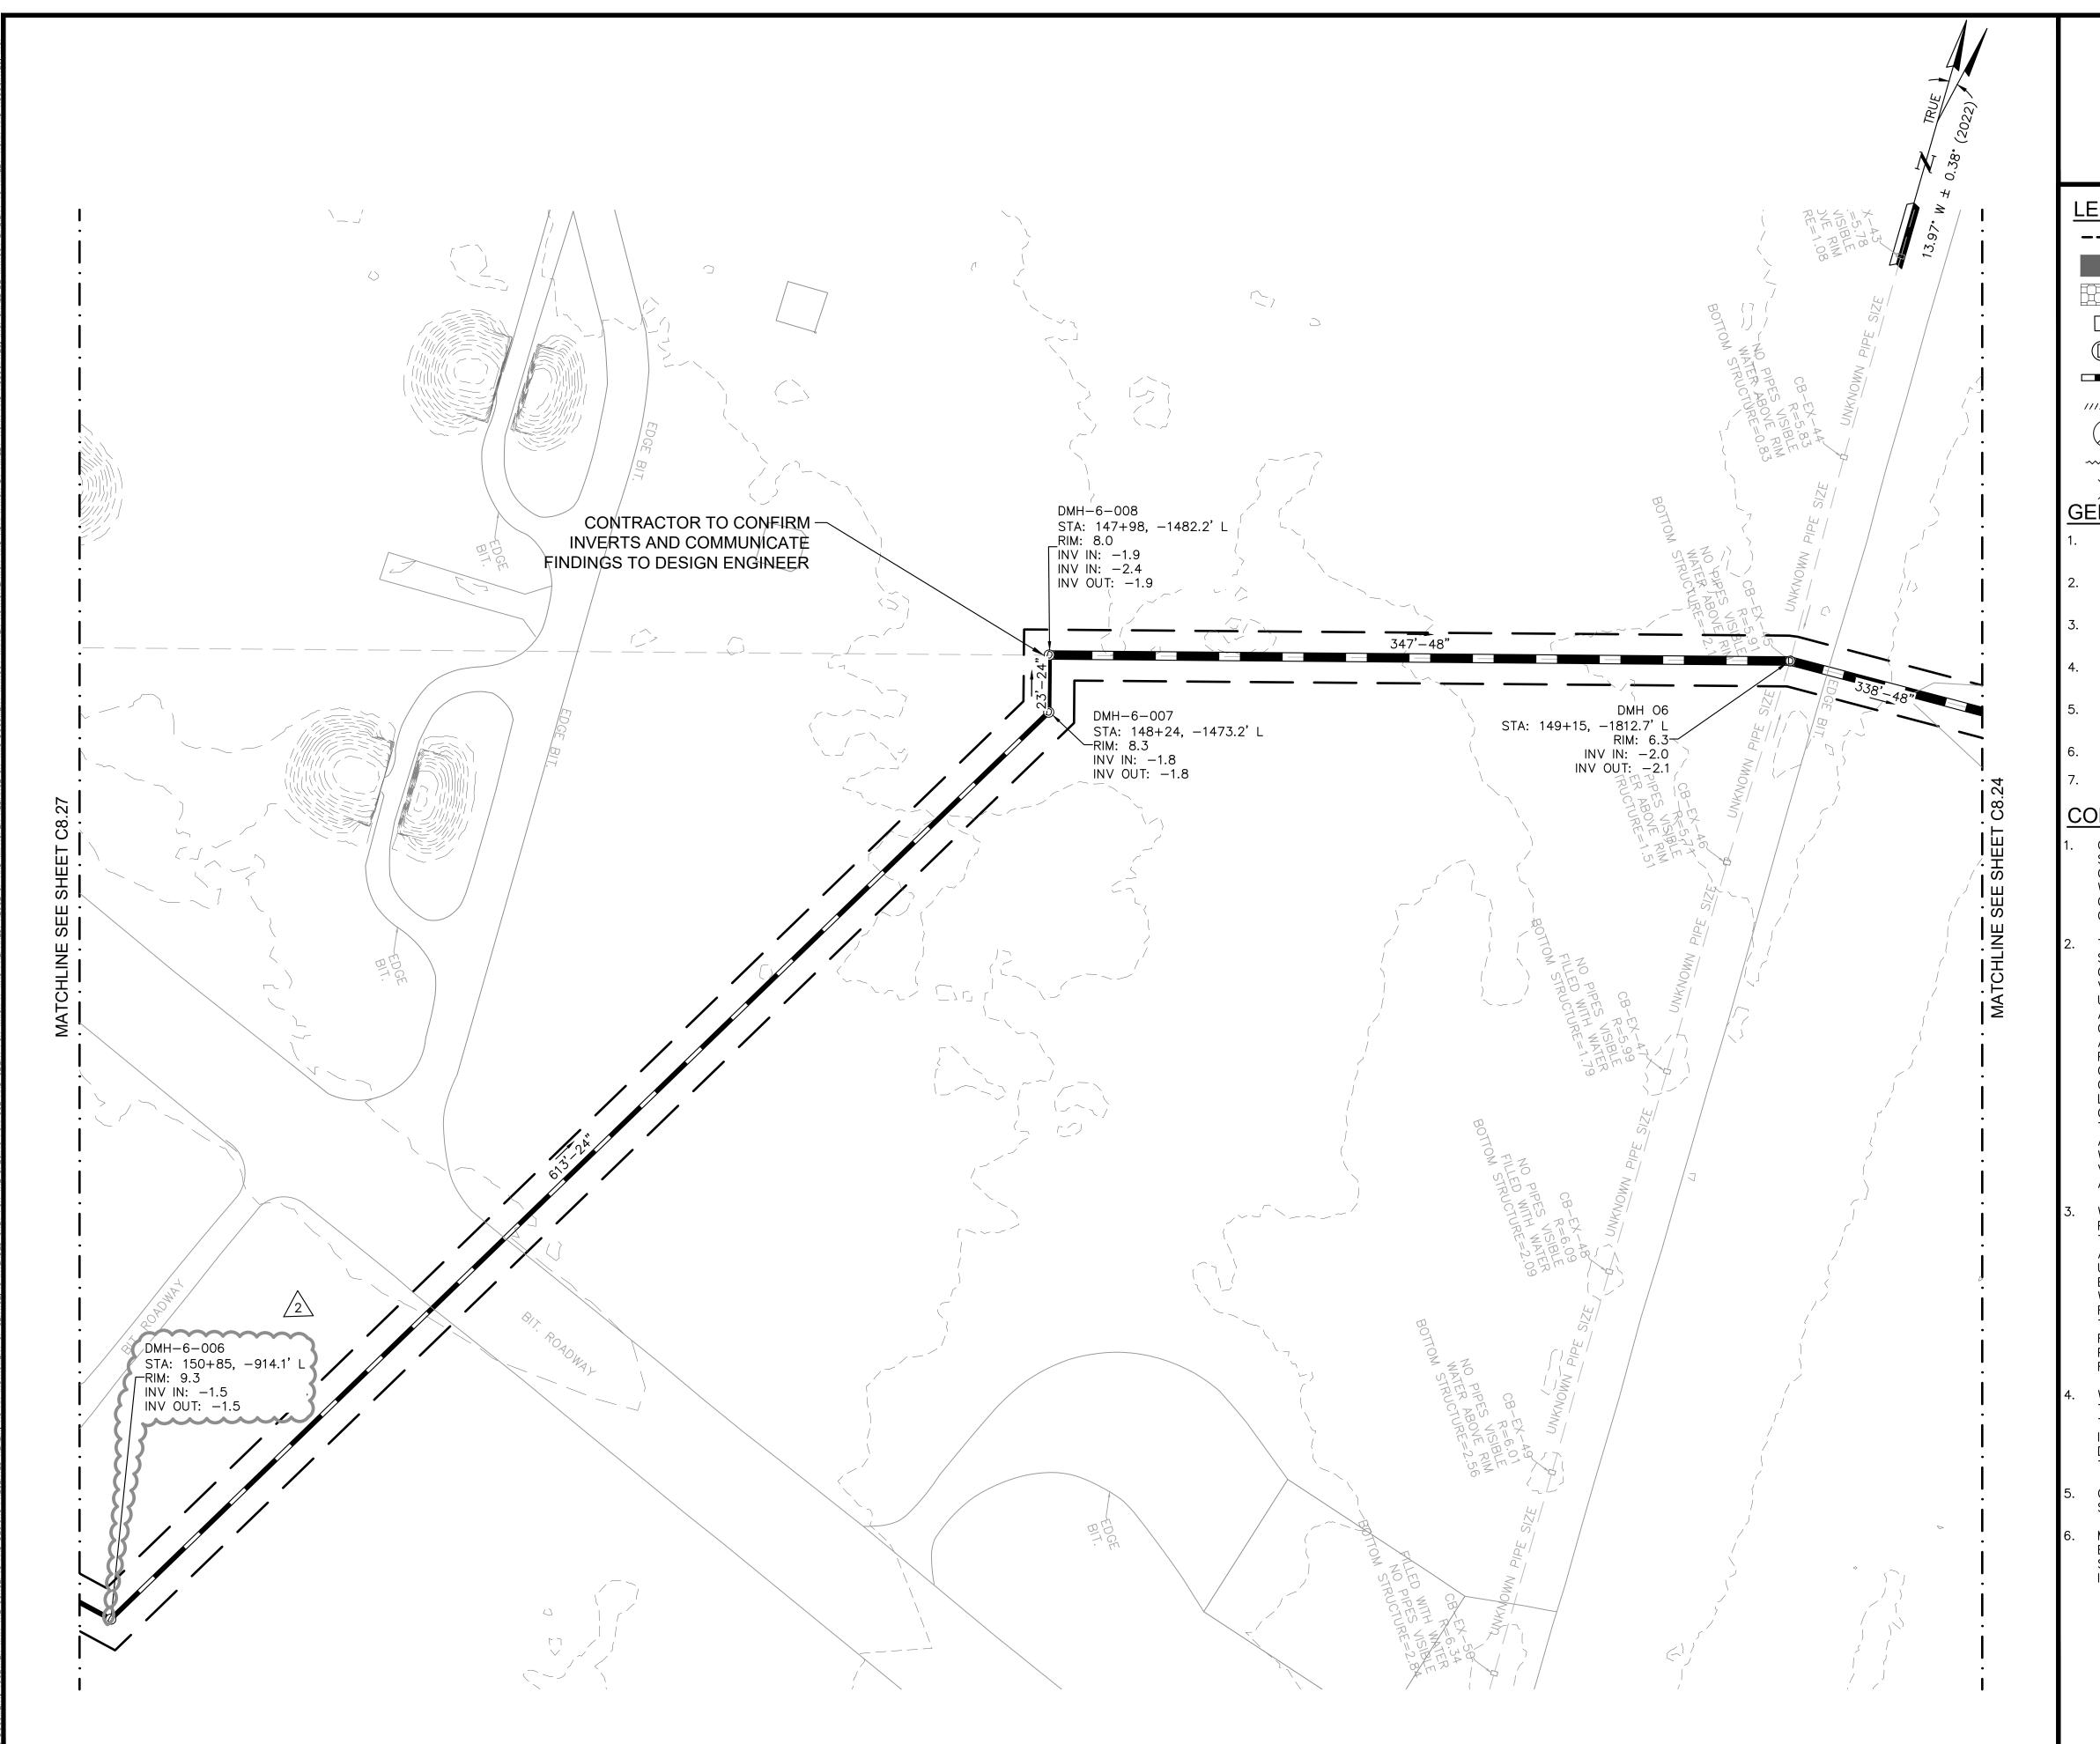
DATE 03/07/2023 **DESIGNED BY** DRAWN BY CHECKED BY PROJECT NO. 112214003 FILE NO. DR01-112214003 AIP NO. 0-00-0000-000-0000

STORM DRAIN BID SCHEDULE 3

SHEET NO. C8.27

SHEET TITLE

124 OF 297



LEGEND

--- LIMIT OF WORK

PROPOSED PAVEMENT LIMITS

QUALIFYING PERVIOUS AREA (QPA)

STORM DRAIN INLET (CB/DBCB/DI/DDI)

(D) DRAIN MANHOLE

DRAIN PIPE

////// DRAINAGE PIPE ABANDONED

(

DRAINAGE STRUCTURE ABANDONED

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40 SCALE IN FEET



QUONSET STATE AIRPORT NORTH KINGSTOWN, RI 02852

PHONE: (401) 691-2000

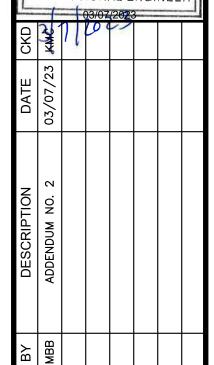
Kimley»Horn

KIMLEY-HORN AND ASSOCIATES, IN 404 WYMAN STREET SUITE 385 WALTHAM, MA 02451 PHONE: (781) 328-0676

VANASSE HANGEN BRUSTLIN, INC.

1 CEDAR STREET SUITE 400 PROVIDENCE, RI 02903

REGISTERED ROFESSIONAL ENGINEER



FE AIRPORT
ST CORPORATIO
RHODE ISLAND
SONSTRUCT STATE AIRPORT C STOWN, RH QUONSET & RHODE ISLAND A NORTH KINGST RUNWAY 16-34

03/07/2023 DATE **DESIGNED BY** DRAWN BY PROJECT NO. 112214003 FILE NO. DR01-112214003 AIP NO. 0-00-0000-000-0000

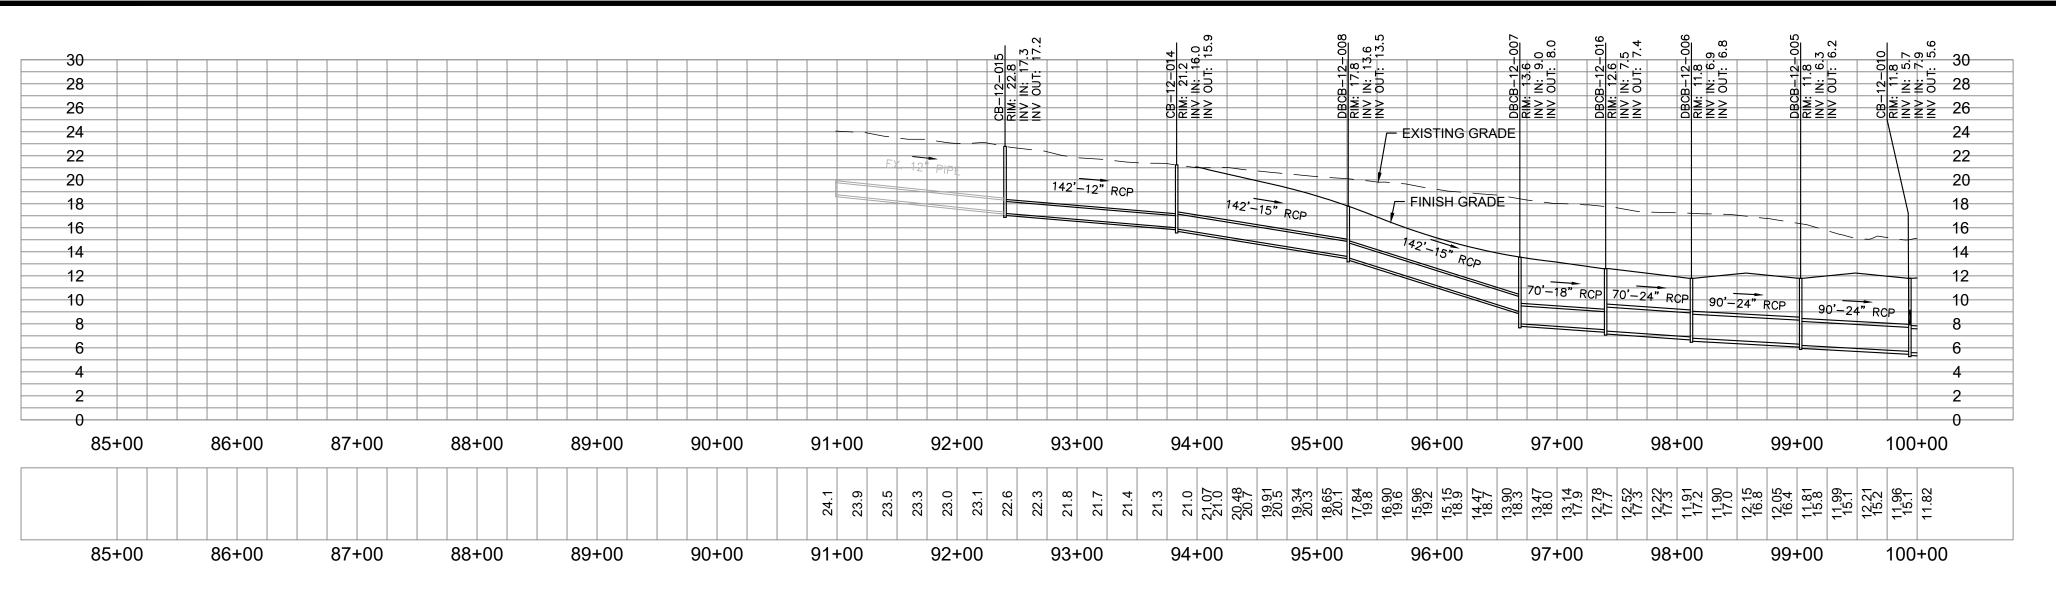
STORM DRAIN PLAN

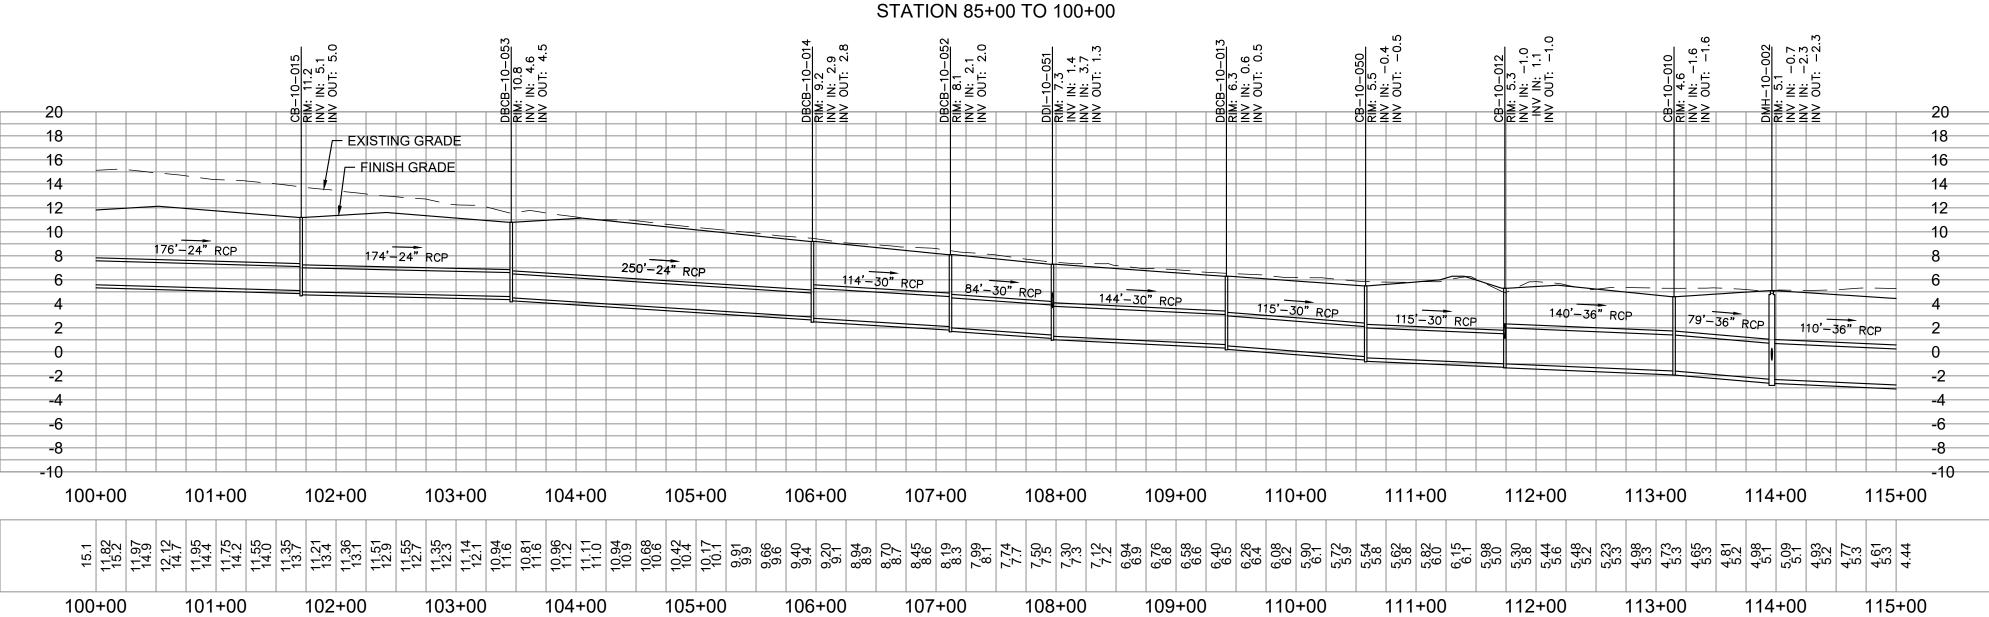
BID SCHEDULE 3

SHEET NO.


SHEET TITLE

125 OF 297





STATION 100+00 TO 115+00

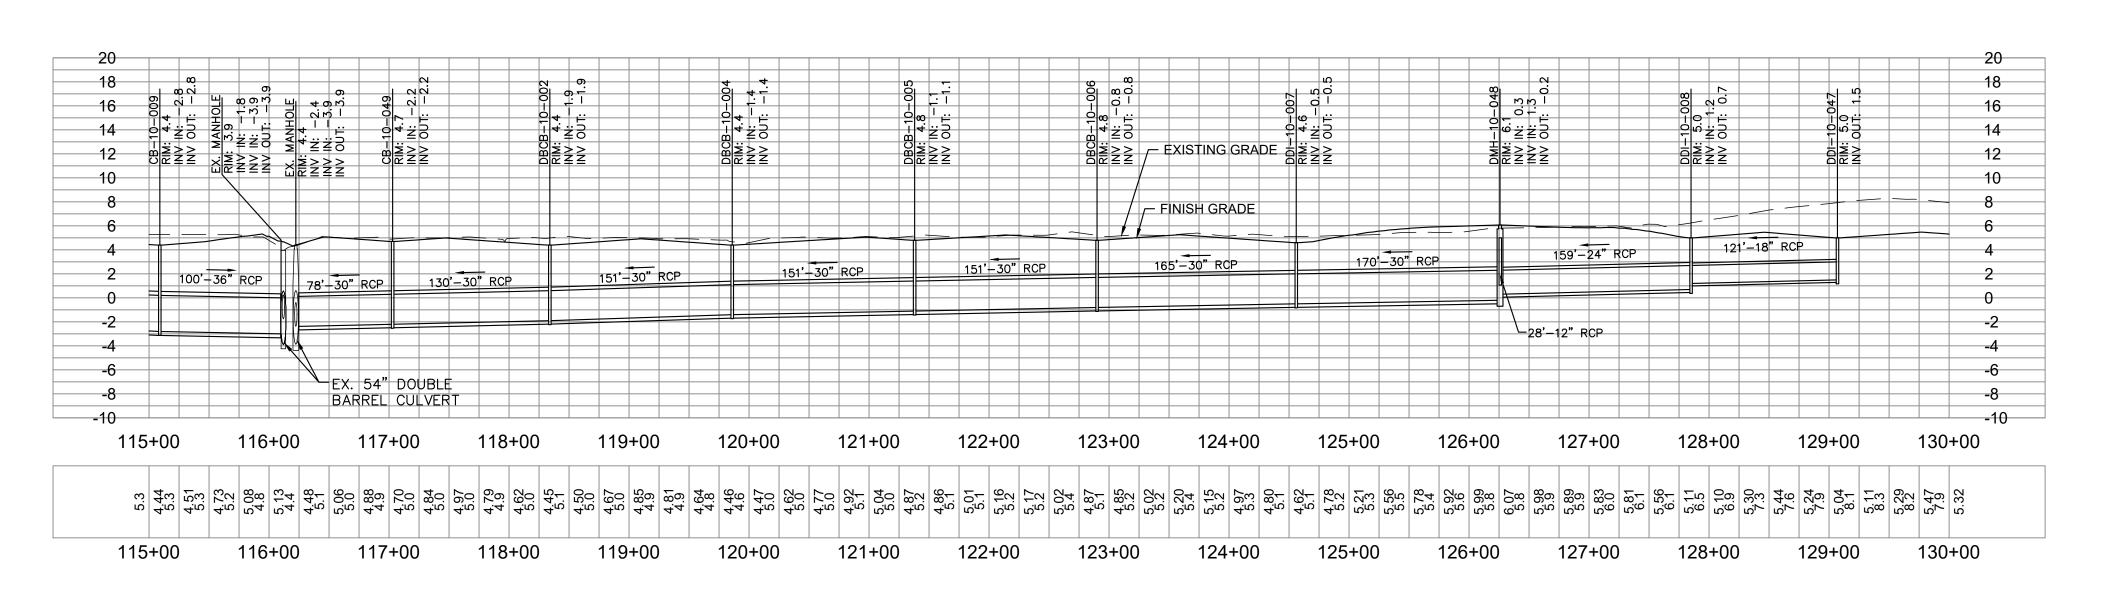

STATION 115+00 TO 130+00

ADDENDUM NO. 2 03/07/2023

QUONSET STATE AIRPORT 150 AIRPORT STREET NORTH KINGSTOWN, RI 02852 PHONE: (401) 691-2000

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VANASSE HANGEN BRUSTLIN, INC. 1 CEDAR STREET SUITE 400

PROVIDENCE, RI 02903

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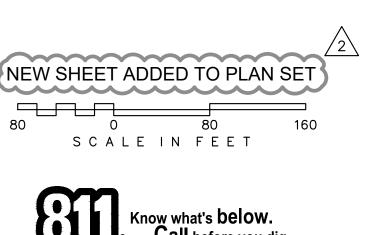
PROFESSIONAL ENGINEER

QUONSET STATE AIRPORT RHODE ISLAND AIRPORT CORPORATION NORTH KINGSTOWN, RHODE ISLAND RUNWAY 16-34 RECONSTRUC

NEW SHEET ADDED TO PLAN SET O 80 SCALE IN FEET 160 Know what's below.

Call before you dig.

S C A




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DESIGNED BY DRAWN BY


STORM DRAIN **PROFILE**

03/07/2023

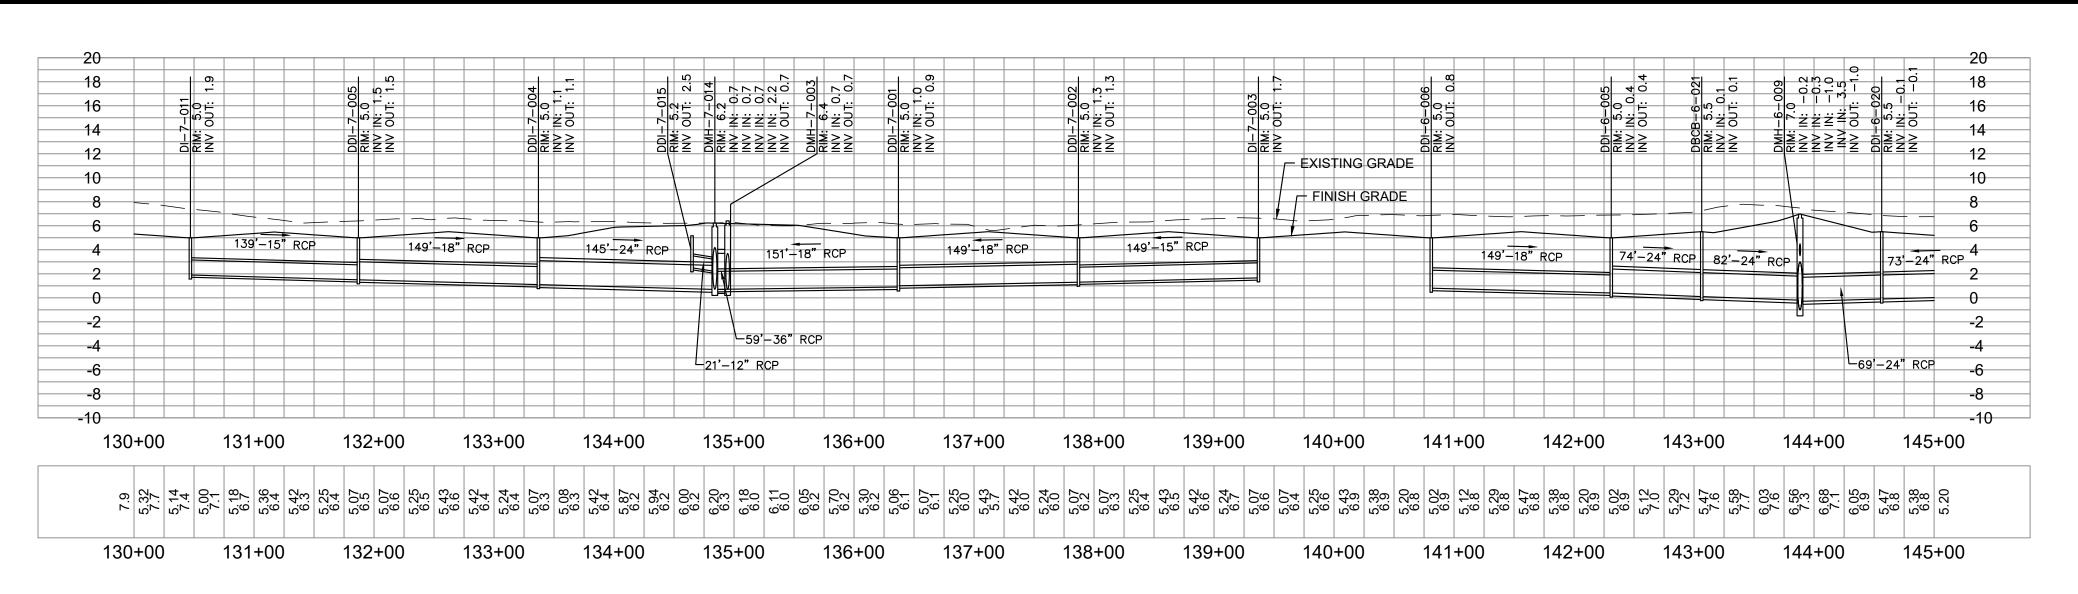
SHEET NO. C8.33 130 OF 297



STATION 130+00 TO 145+00

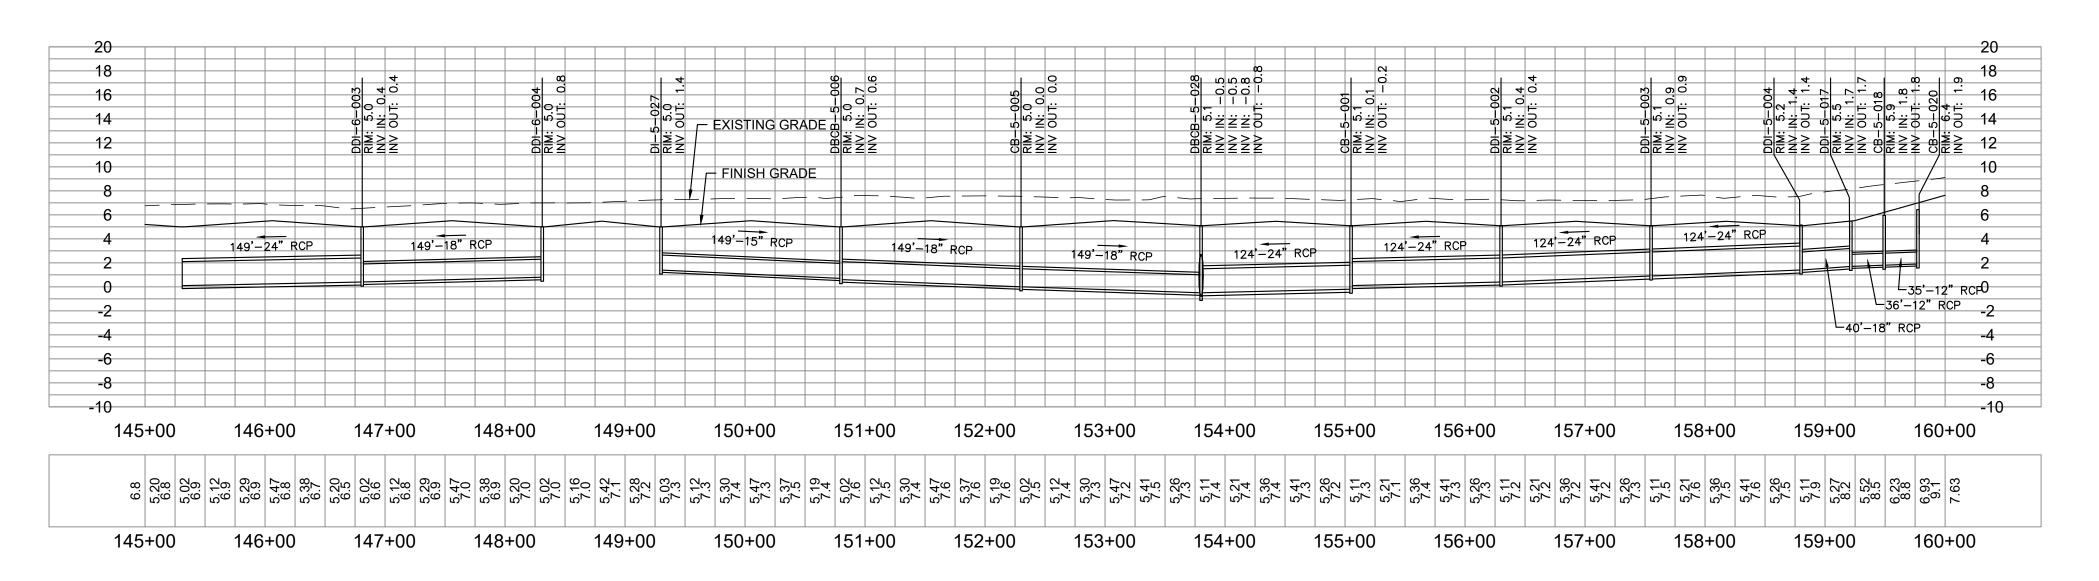

STATION 145+00 TO 160+00

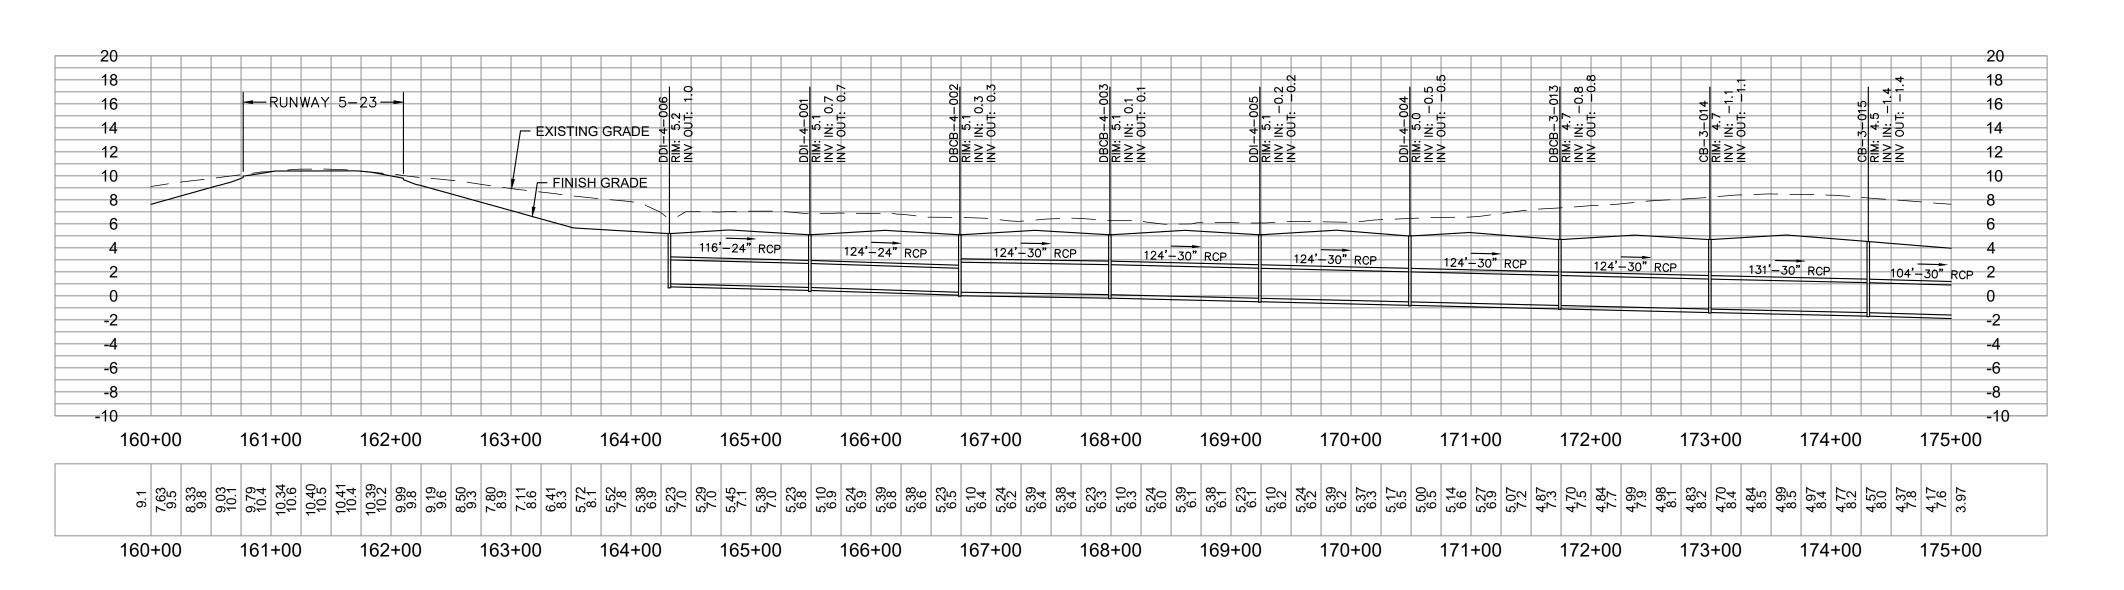

STATION 160+00 TO 175+00

ADDENDUM NO. 2 03/07/2023

QUONSET STATE AIRPORT 150 AIRPORT STREET NORTH KINGSTOWN, RI 02852 PHONE: (401) 691-2000

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KIMLEY-HORN AND ASSOCIATES, INC 404 WYMAN STREET SUITE 385 WALTHAM, MA 02451 PHONE: (781) 328-0676

VANASSE HANGEN BRUSTLIN, INC. 1 CEDAR STREET SUITE 400

PROVIDENCE, RI 02903 (DA

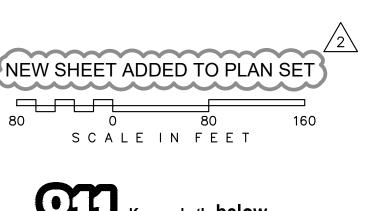
REGISTERED

PROFESSIONAL ENGINEER

STATE AIRPORT
AIRPORT CORPORATIO
TOWN, RHODE ISLAND
RECONSTRUCT QUONSET S' RHODE ISLAND AIF NORTH KINGSTO RUNWAY 16-34 F

O 80 SCALE IN FEET 160 Know what's below.

Call before you dig.



S C A

FILE NO. DR02-112214003 AIP NO. 0-00-0000-000-0000 SHEET TITLE STORM DRAIN

PROJECT NO. 112214003

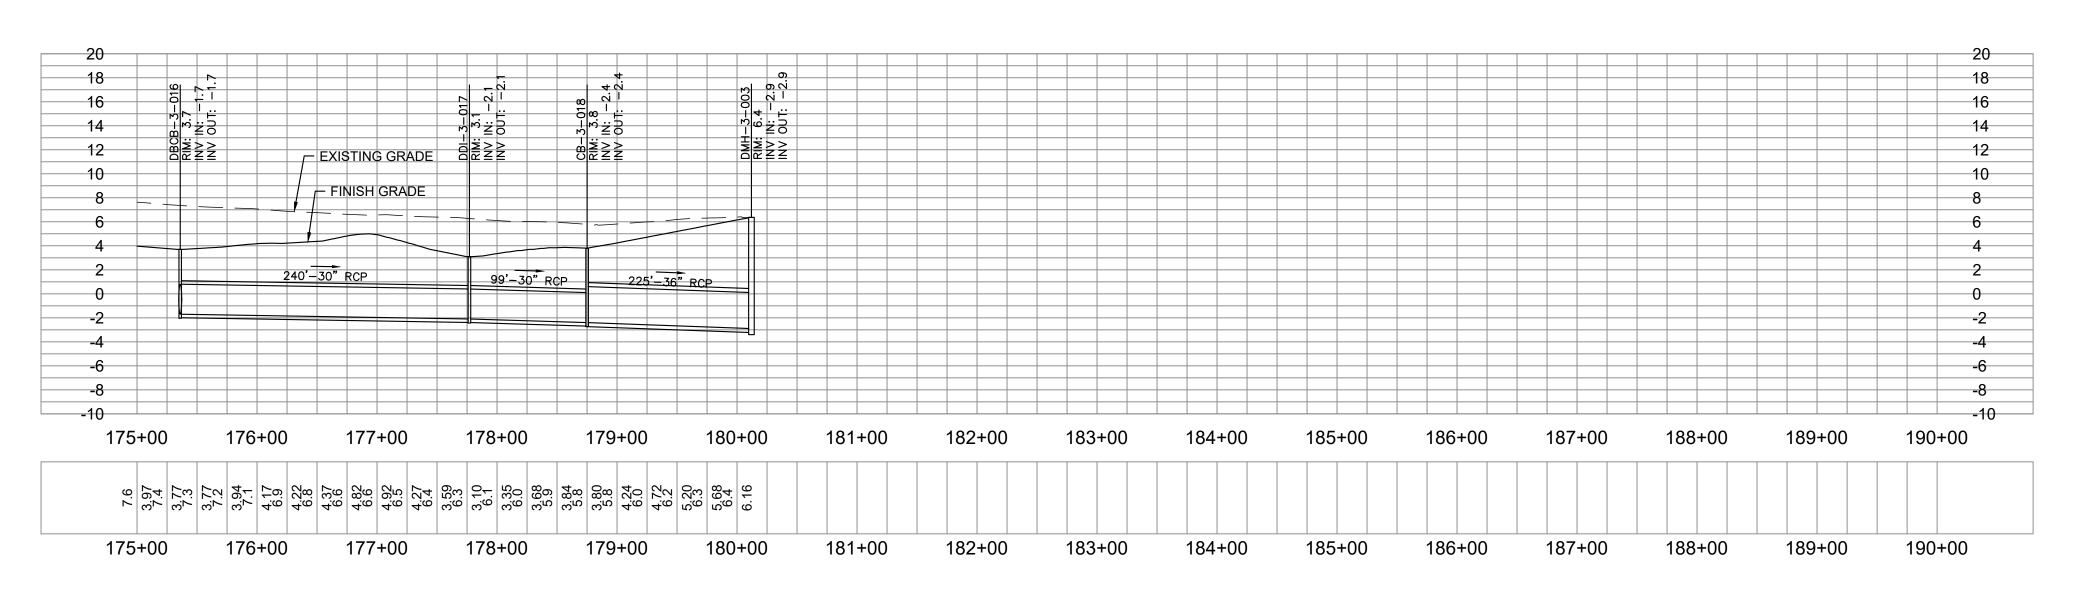
DESIGNED BY DRAWN BY

03/07/2023

SHEET NO. C8.34

PROFILE

131 OF 297



STATION 175+00 TO 190+00

ADDENDUM NO. 2 03/07/2023

QUONSET STATE AIRPORT 150 AIRPORT STREET NORTH KINGSTOWN, RI 02852 PHONE: (401) 691-2000

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VANASSE HANGEN BRUSTLIN, INC.
1 CEDAR STREET
SUITE 400

RENEE CODE

REGISTERED PROFESSIONAL ENGINEER

93/07/2023

93/07/2023

EV BY DESCRIPTION DAT

RPL ADDENDUM NO. 2 03/07,

QUONSET STATE AIRPORT
RHODE ISLAND AIRPORT CORPORATION
NORTH KINGSTOWN, RHODE ISLAND
RUNWAY 16-34 RECONSTRUCTIC

DESIGNED BY RPL
DRAWN BY MBE
CHECKED BY RLC
PROJECT NO. 112214003
FILE NO. DR02-112214003
AIP NO.0-00-0000-0000-0000
SHEET TITLE


03/07/2023

STORM DRAIN PROFILE


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132 OF 297


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STATION 85+00 TO 100+00

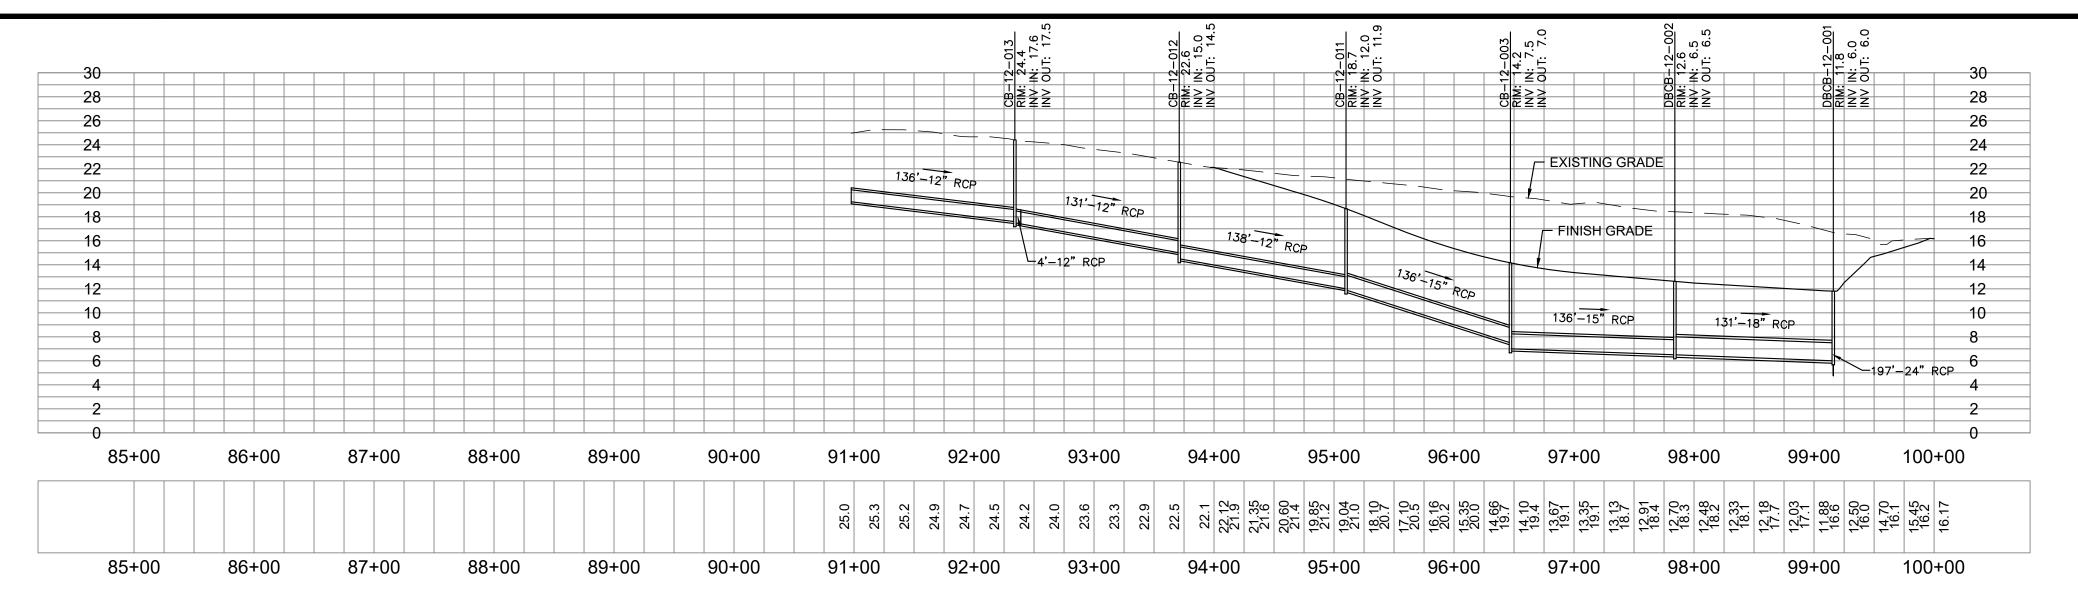

STATION 100+00 TO 115+00

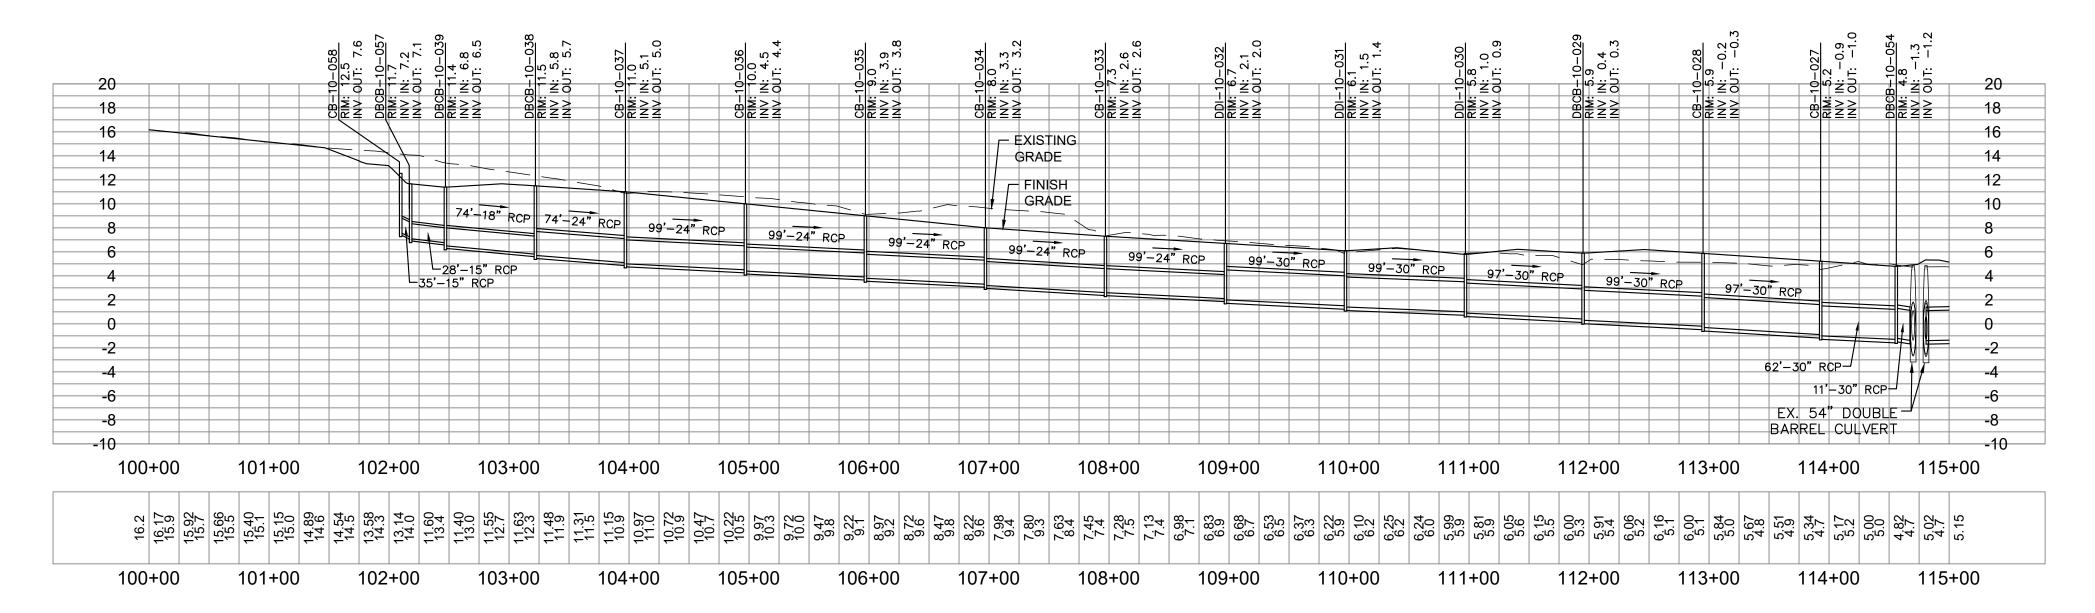

STATION 115+00 TO 130+00

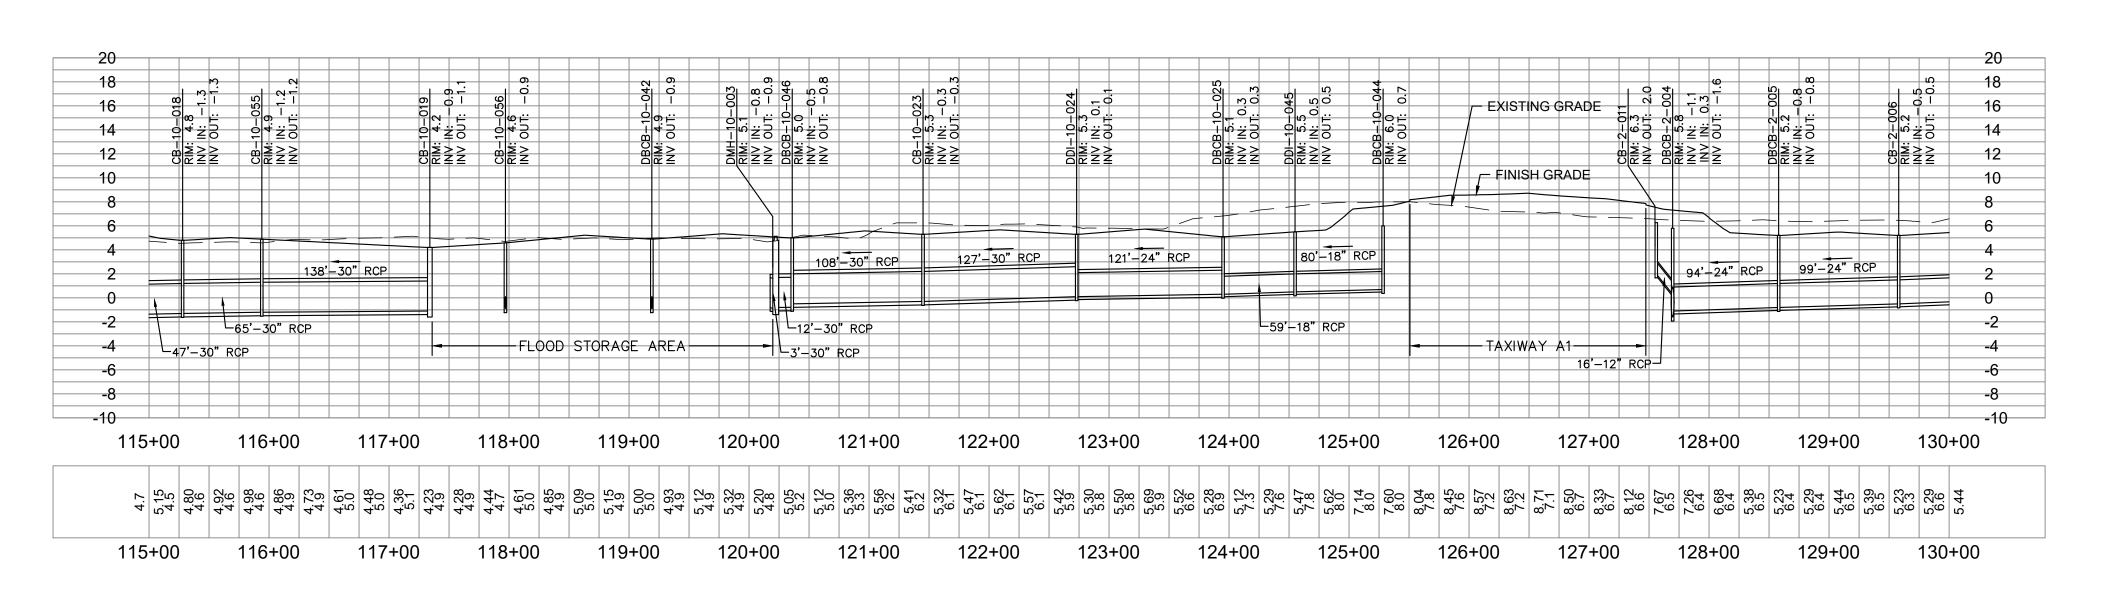ADDENDUM NO. 2 03/07/2023

QUONSET STATE AIRPORT 150 AIRPORT STREET NORTH KINGSTOWN, RI 02852 PHONE: (401) 691-2000

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VANASSE HANGEN BRUSTLIN, INC. 1 CEDAR STREET SUITE 400

PROVIDENCE, RI 02903

REGISTERED PROFESSIONAL ENGINEER

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QUONSET STATE AIRPORT RHODE ISLAND AIRPORT CORPORATION NORTH KINGSTOWN, RHODE ISLAND RUNWAY 16-34 RECONSTRUC

O 80 SCALE IN FEET 160 Know what's below.

Call before you dig.

NEW SHEET ADDED TO PLAN SET

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STORM DRAIN **PROFILE**

PROJECT NO. 112214003 FILE NO. DR02-11221400 AIP NO. 0-00-0000-000-0000

03/07/2023

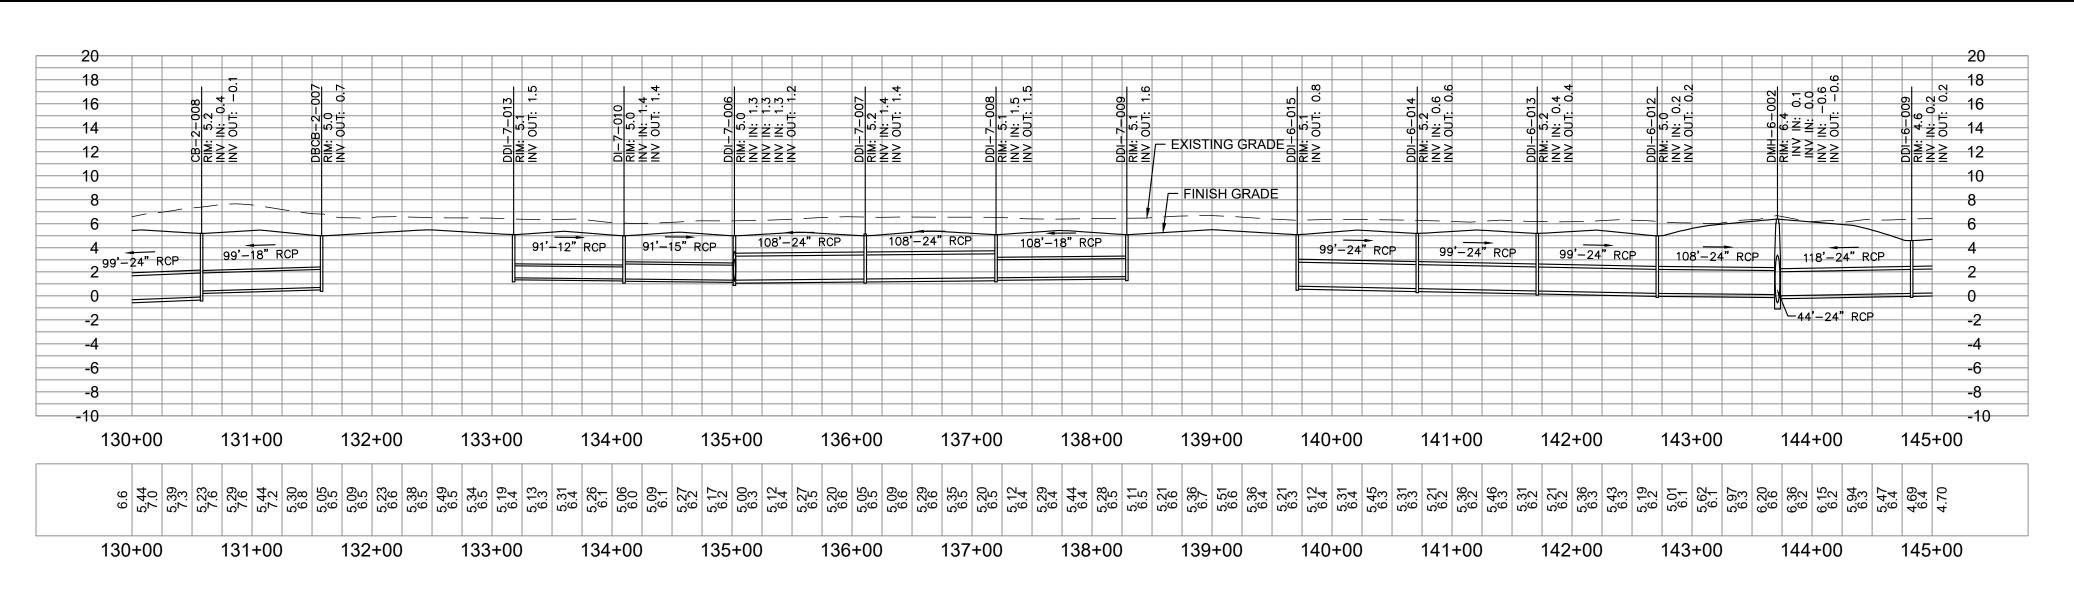
SHEET NO. C8.36 133 OF 297

DESIGNED BY

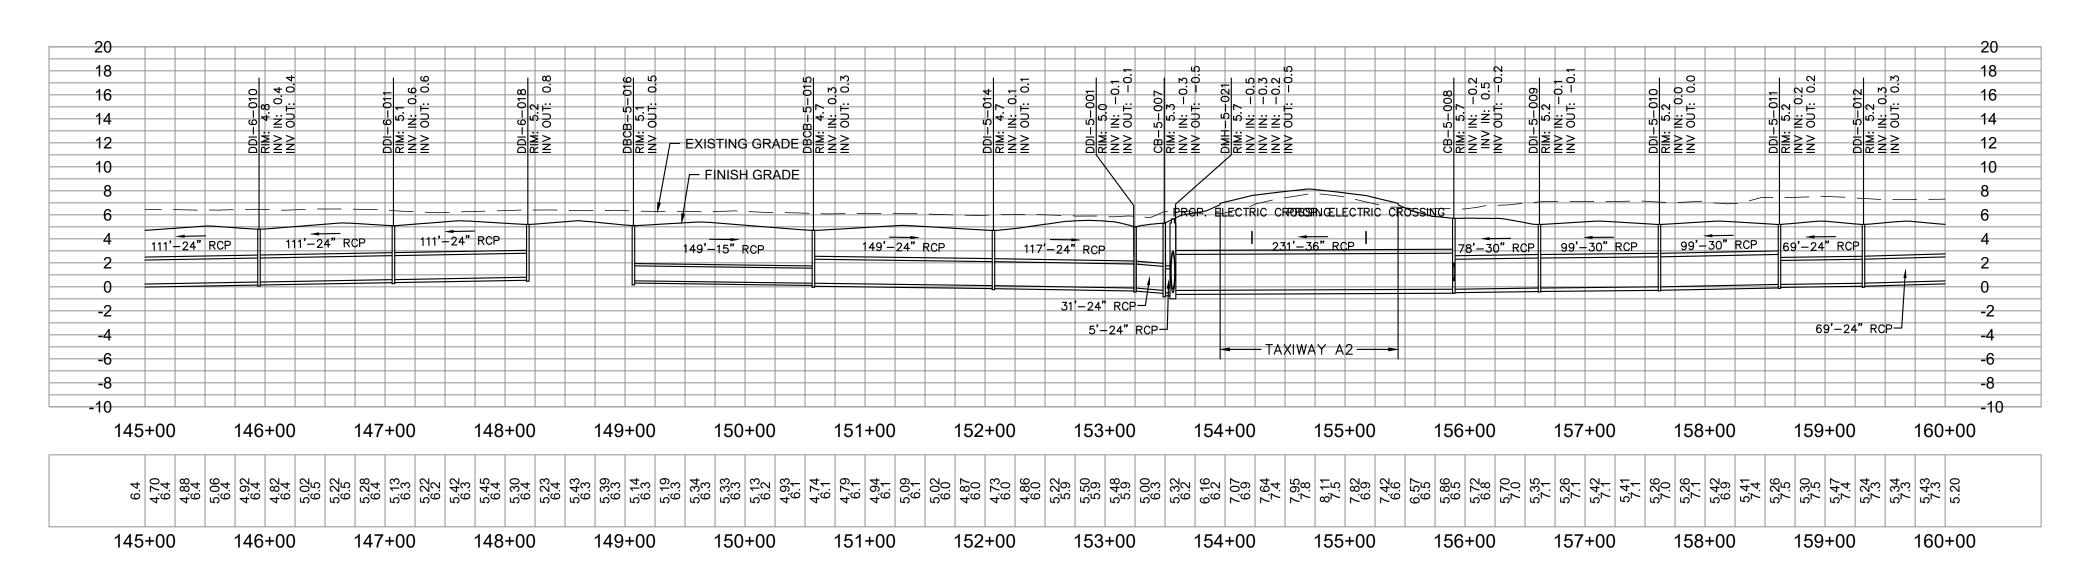
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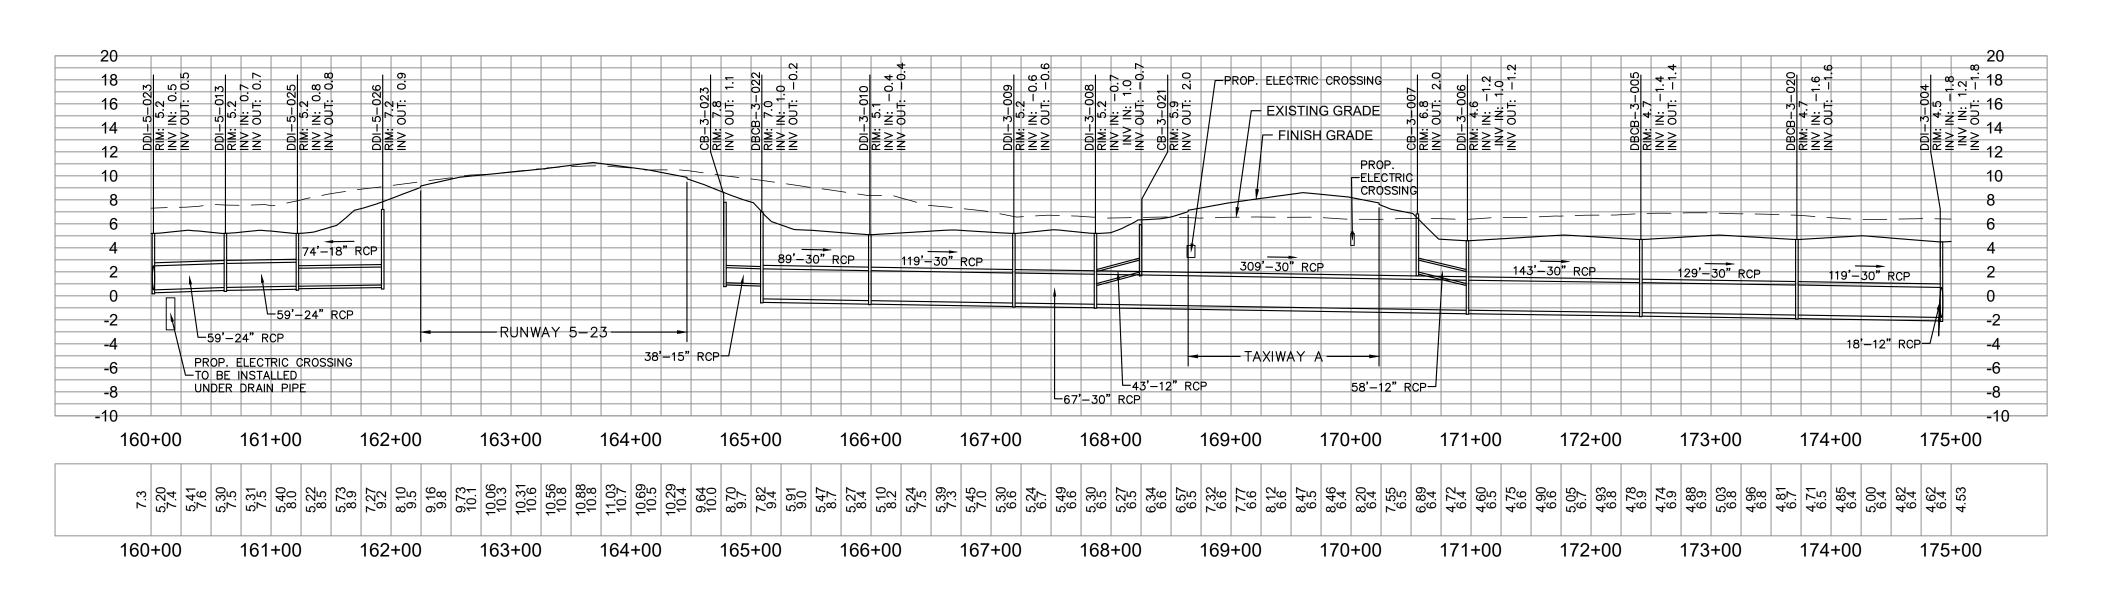
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STATION 130+00 TO 145+00



STATION 145+00 TO 160+00



STATION 160+00 TO 175+00

ADDENDUM NO. 2 03/07/2023

QUONSET STATE AIRPORT 150 AIRPORT STREET NORTH KINGSTOWN, RI 02852 PHONE: (401) 691-2000

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VANASSE HANGEN BRUSTLIN, INC. 1 CEDAR STREET SUITE 400

PROVIDENCE, RI 02903 (D)

REGISTERED PROFESSIONAL ENGINEER


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DESCRIPTION	ADDENDUM NO. 2					
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STATE AIRPORT
AIRPORT CORPORATIO
TOWN, RHODE ISLAND
RECONSTRUCT QUONSET S' RHODE ISLAND AIF NORTH KINGSTO RUNWAY 16-34 F

NEW SHEET ADDED TO PLAN SET O 80 SCALE IN FEET Know what's below.

Call before you dig.

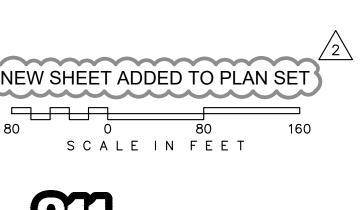O



STORM DRAIN **PROFILE**

PROJECT NO. 112214003

FILE NO. DR02-11221400 AIP NO. 0-00-0000-000-000

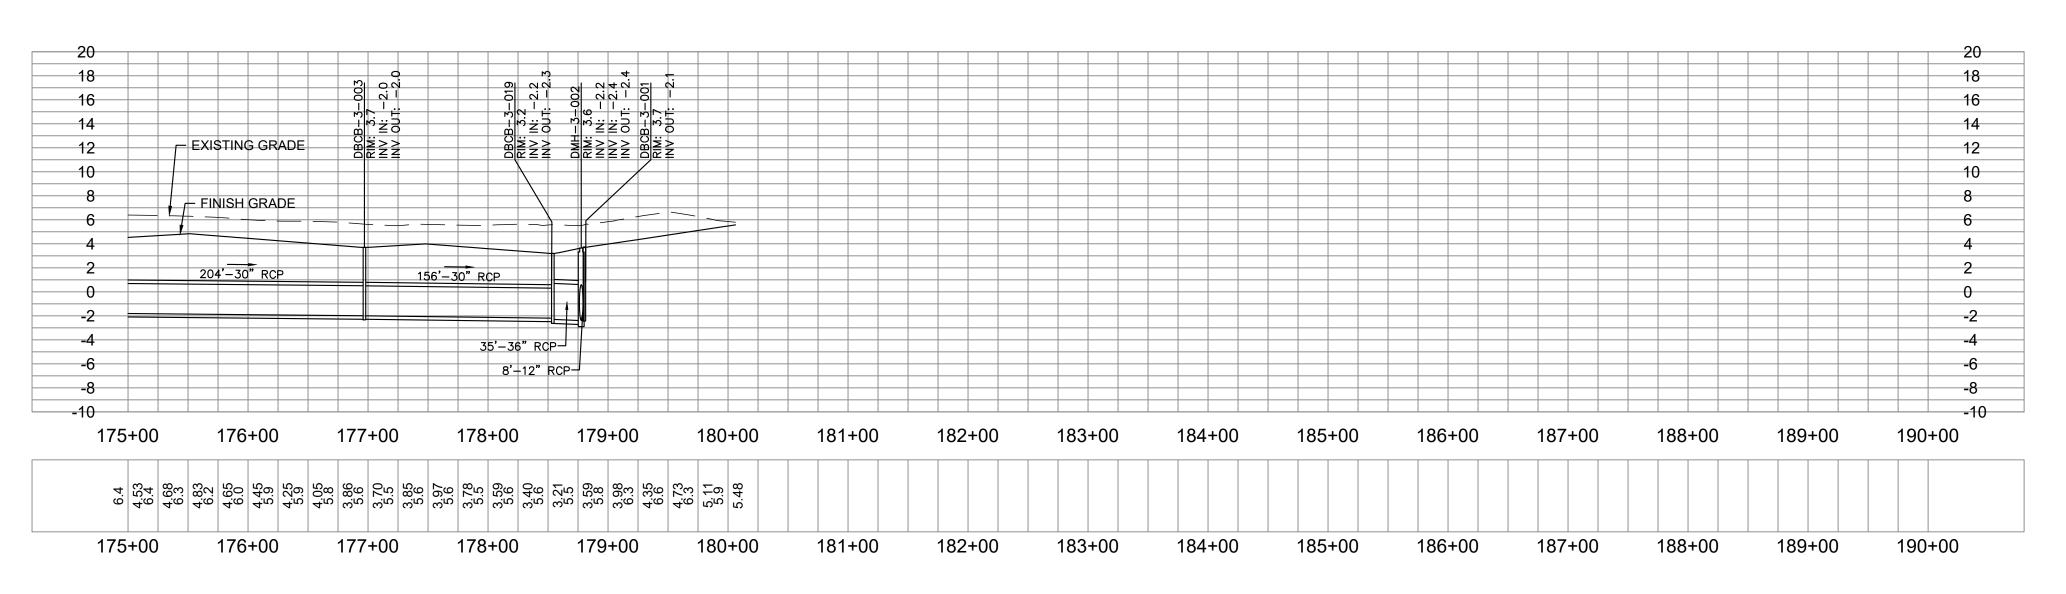
03/07/2023

SHEET NO. C8.37 134 OF 297

DESIGNED BY DRAWN BY

CHECKED BY

SHEET TITLE



STATION 175+00 TO 190+00

ADDENDUM NO. 2 03/07/2023

QUONSET STATE AIRPORT 150 AIRPORT STREET NORTH KINGSTOWN, RI 02852 PHONE: (401) 691-2000

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PROVIDENCE, RI 02903

REGISTERED PROFESSIONAL ENGINEER

QUONSET STATE AIRPORT RHODE ISLAND AIRPORT CORPORATIC NORTH KINGSTOWN, RHODE ISLAND RUNWAY 16-34 RECONSTRUC

03/07/2023

80 0 80 160 S C A L E I N F E E T Know what's below.

Call before you dig.

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NEW SHEET ADDED TO PLAN SET

STORM DRAIN **PROFILE**

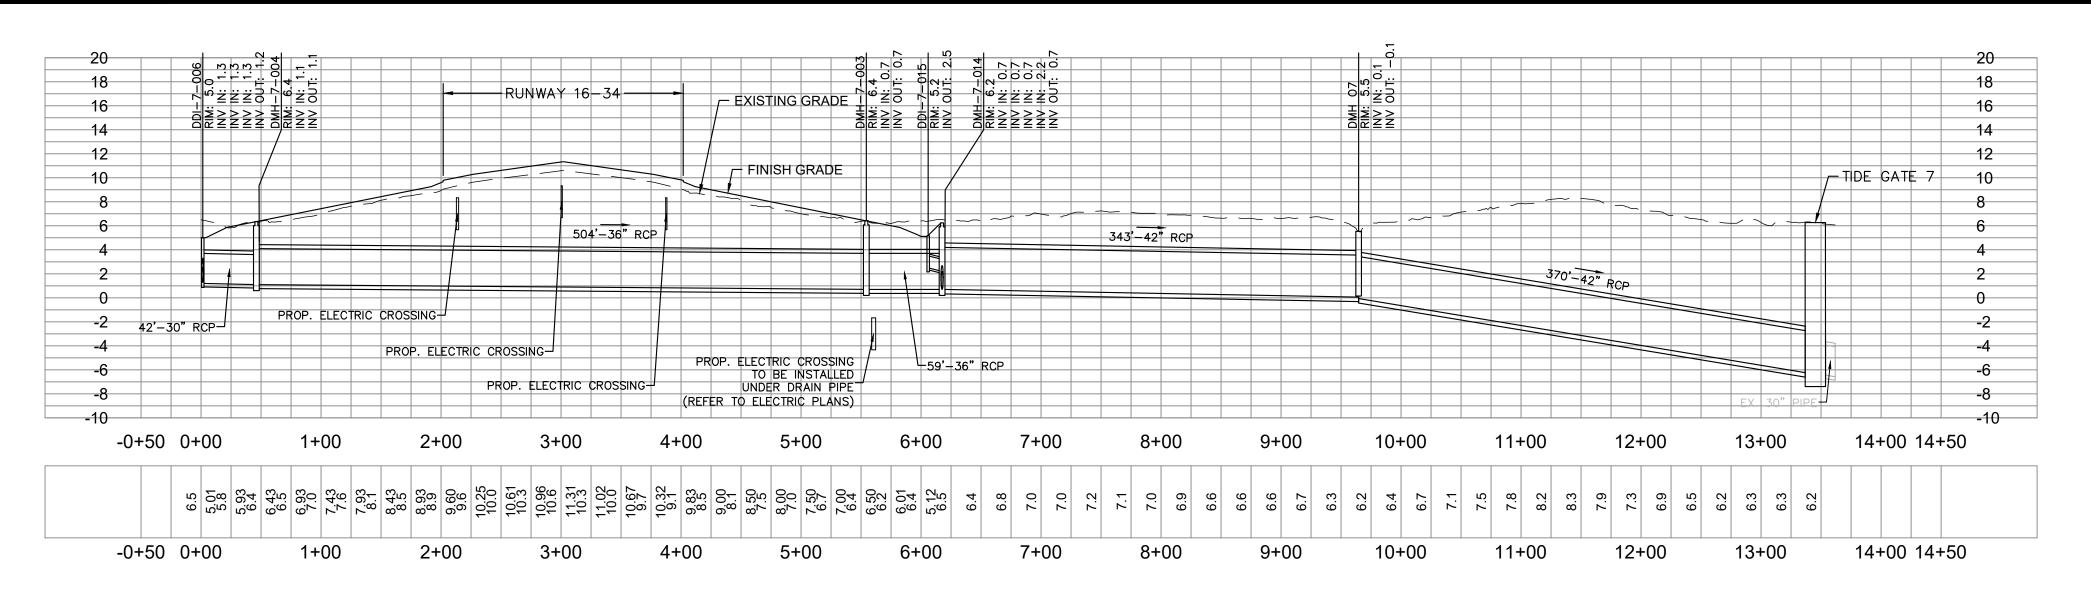
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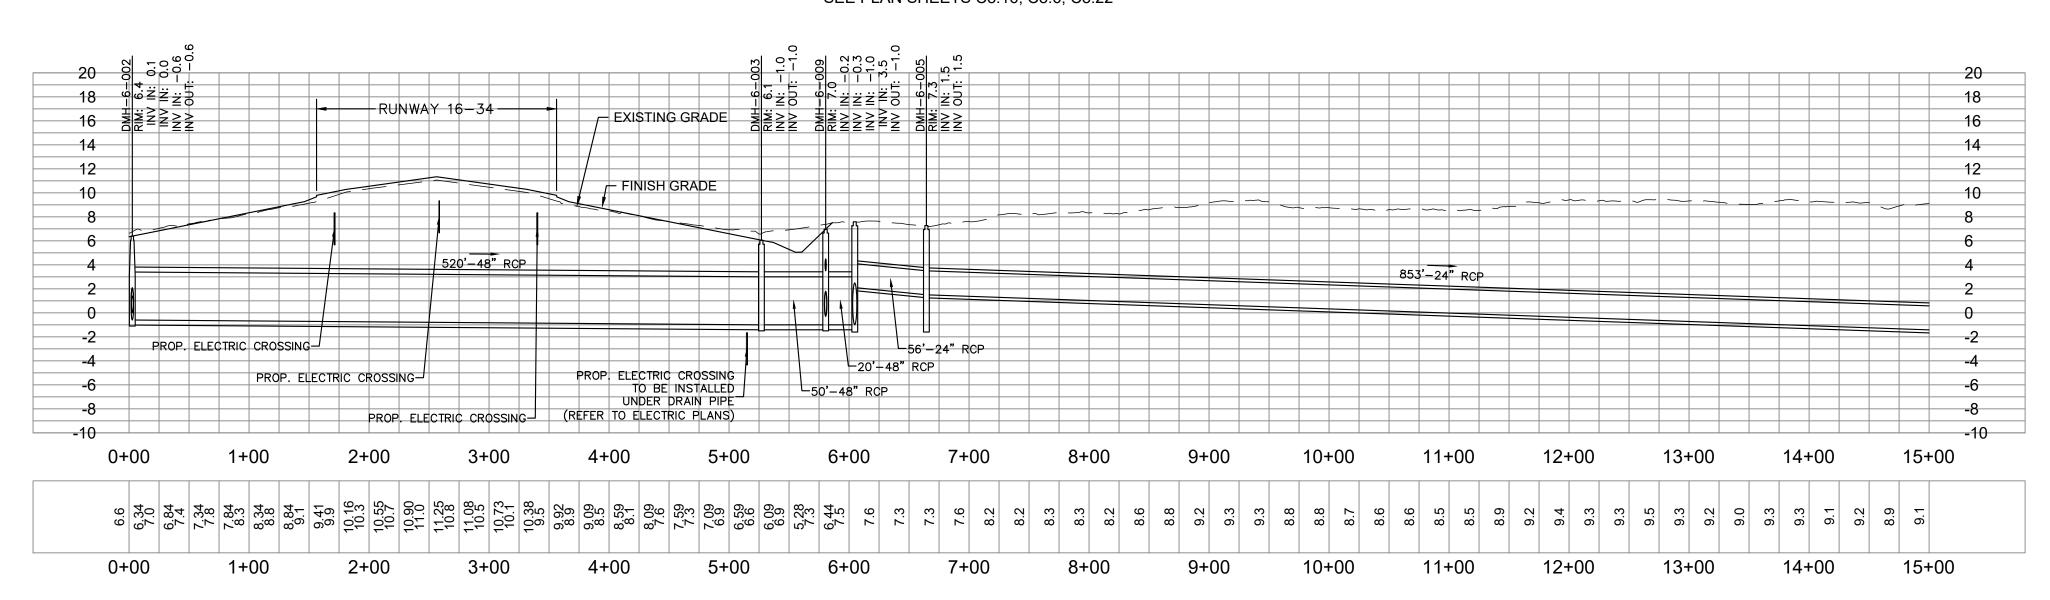
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SHEET TITLE


SHEET NO. C8.38 135 OF 297



STATION -0+50 TO 14+50 SEE PLAN SHEETS C8.16, C8.6, C8.22



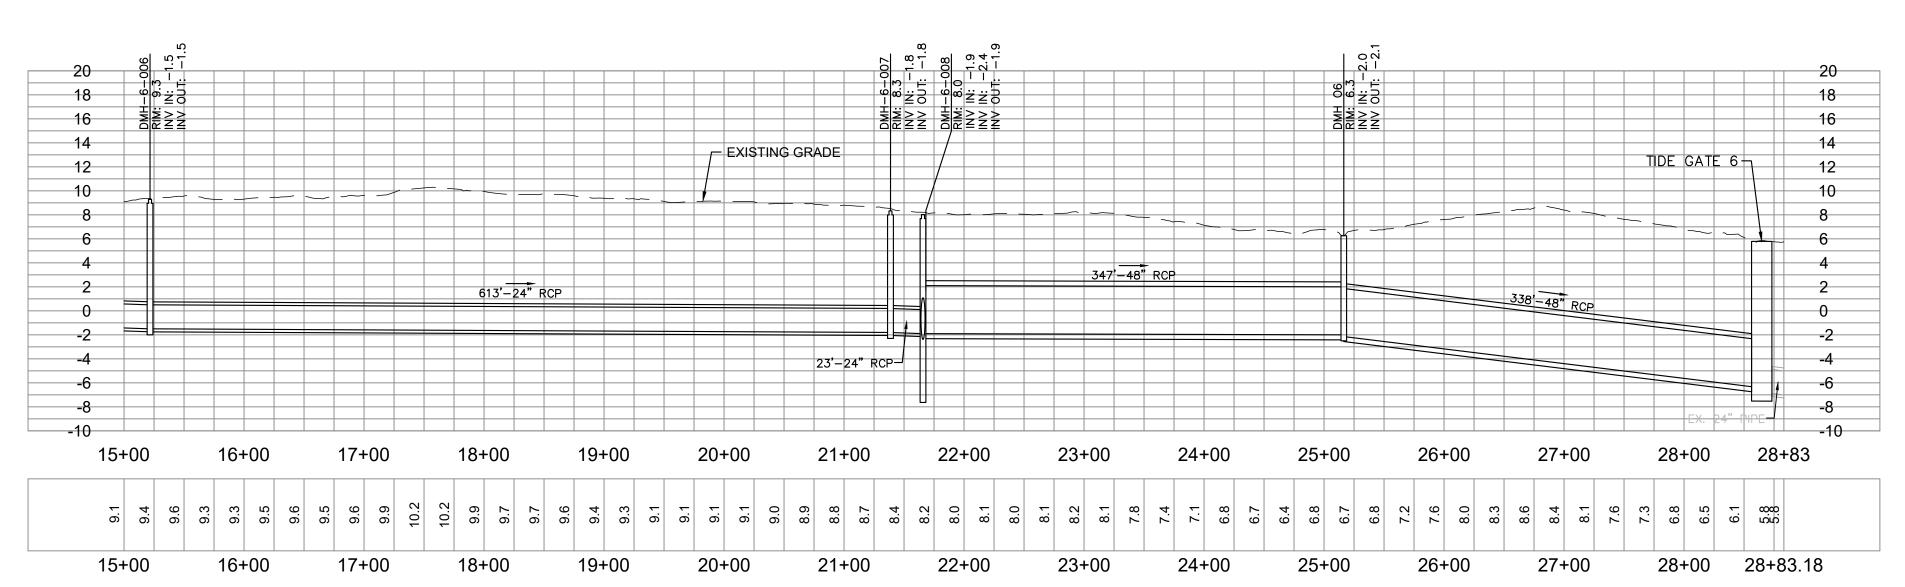STATION 0+00 TO 15+00 SEE PLAN SHEETS C8.17, C8.7, C8.27, C8.28, C8.24



STATION 15+00 TO 28+83 SEE PLAN SHEETS C8.17, C8.7, C8.27, C8.28, C8.24 NOTE: STATIONING ON THIS SHEET REFERS TO DISTANCE ALONG THE PIPE RUN STARTING WITH THE FURTHEST UPSTREAM STRUCTURE. SEE PLAN SHEETS SPECIFIED.

ADDENDUM NO. 2 03/07/2023

QUONSET STATE AIRPORT 150 AIRPORT STREET NORTH KINGSTOWN, RI 02852 PHONE: (401) 691-2000

Kimley » Horn

© 2023 KIMLEY-HORN AND ASSOCIATES, IN 404 WYMAN STREET SUITE 385 WALTHAM, MA 02451 PHONE: (781) 328-0676

VANASSE HANGEN BRUSTLIN, INC. 1 CEDAR STREET SUITE 400


PROVIDENCE, RI 02903 REGISTERED

PROFESSIONAL ENGINEER

			3/07	1202	3	_	
CKD	KWEZ	11.					
DATE	03/07/23 KMC						
DESCRIPTION	ADDENDUM NO. 2						
ВУ	RPL						
REV BY	2						

QUONSET S' RHODE ISLAND AIF NORTH KINGSTO RUNWAY 16-34 F

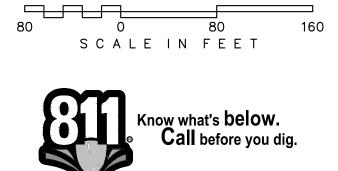NEW SHEET ADDED TO PLAN SET



STORM DRAIN **PROFILE**

PROJECT NO. 112214003 FILE NO. DR02-112214003 AIP NO. 0-00-0000-000-0000

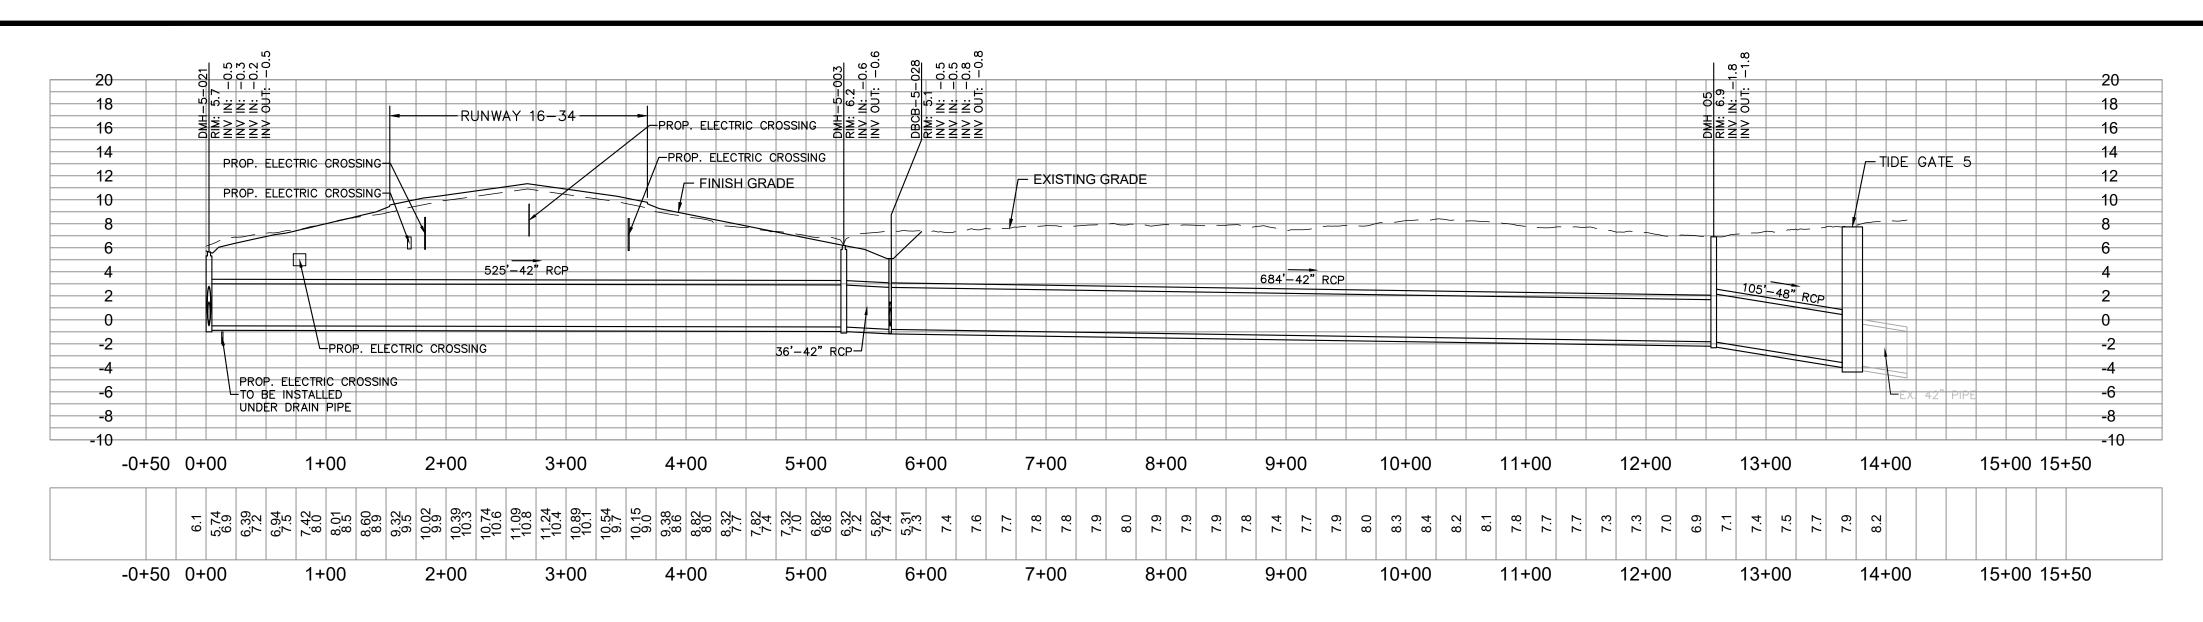
03/07/2023

SHEET NO. C8.39 136 OF 297


DESIGNED BY DRAWN BY

CHECKED BY

SHEET TITLE



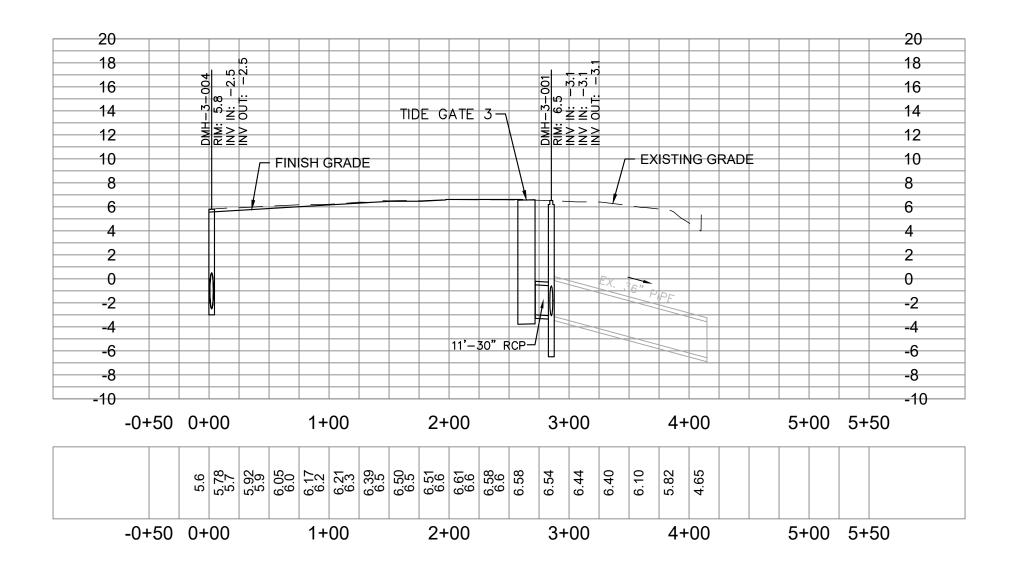STATION -0+50 TO 15+50 SEE PLAN SHEETS C8.18, C8.8, C8.29



STATION -0+50 TO 5+50 SEE PLAN SHEET C8.11

ADDENDUM NO. 2 03/07/2023

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SUITE 385
WALTHAM, MA 02451
PHONE: (781) 328-0676

VANASSE HANGEN BRUSTLIN, INC. 1 CEDAR STREET SUITE 400

PROVIDENCE, RI 02903

RENEE CODEO

No. 651

REGISTERED
PROFESSIONAL ENGINEER

2 RPL ADDENDUM NO. 2 03/07/23 KMZ

QUONSET STATE AIRPORT RHODE ISLAND AIRPORT CORPORATION NORTH KINGSTOWN, RHODE ISLAND RUNWAY 16-34 RECONSTRUCTIC

DESIGNED BY RPL

DRAWN BY MBE

CHECKED BY RLC

PROJECT NO. 112214003

FILE NO. DR02-112214003

AIP NO.0-00-0000-000-0000

SHEET TITLE

/2\ IEW CLIEFT 15555

NEW SHEET ADDED TO PLAN SET

80 0 80 160 S C A L E I N F E E T

Know what's below.
Call before you dig.

S C A

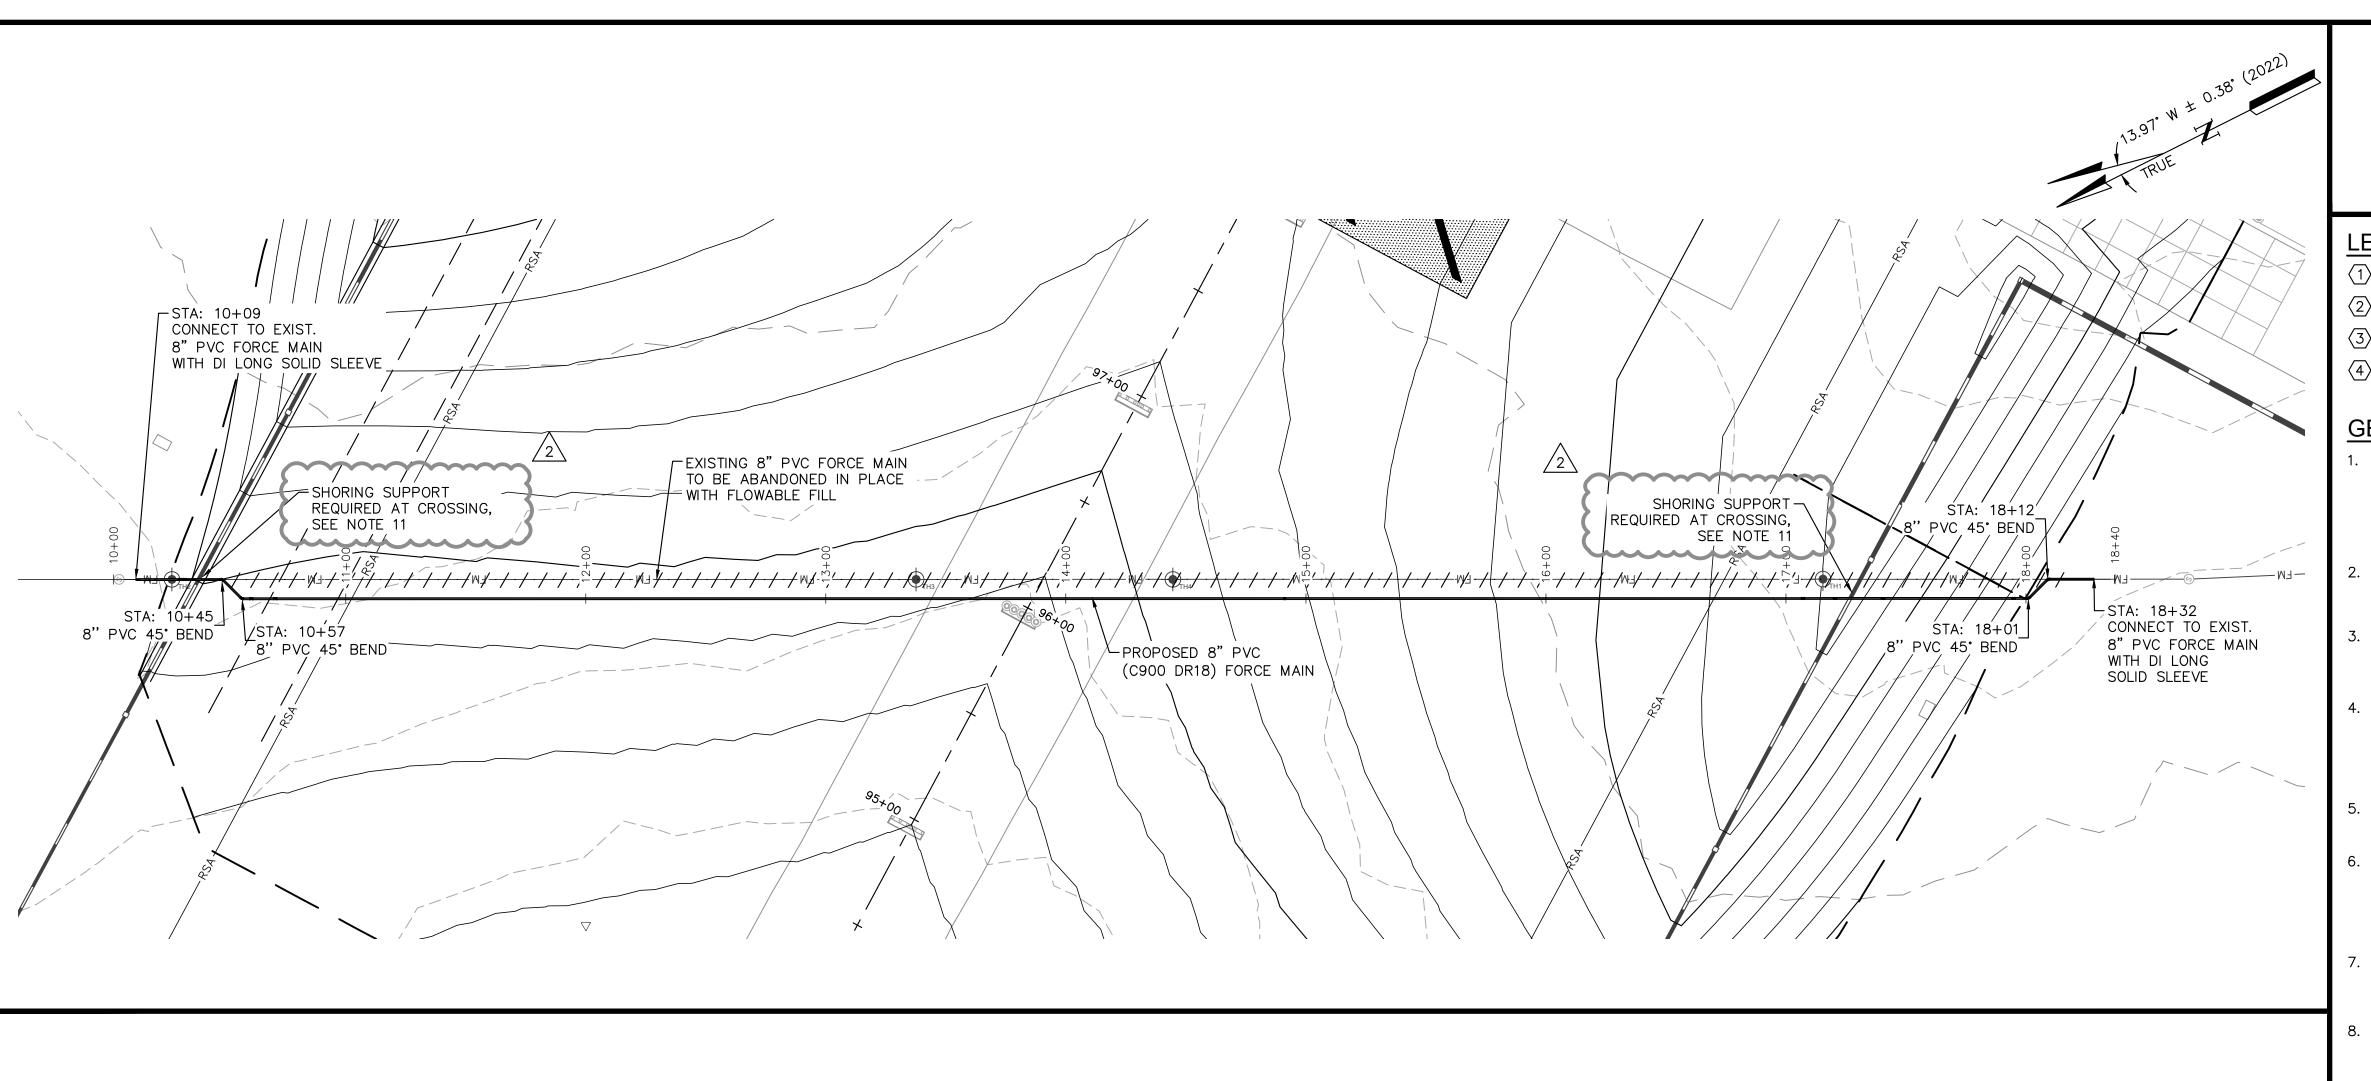
03/07/2023

STORM DRAIN PROFILE

137 OF 297

SHEET NO. C8.40

NOTE: STATIONING ON THIS SHEET REFERS TO DISTANCE ALONG THE PIPE RUN STARTING WITH THE FURTHEST UPSTREAM STRUCTURE. SEE PLAN SHEETS SPECIFIED.



28 26 26 EXISTING GRADE 24 PROPOSED GRADE 22 22 STA: 18+32-20 CONNECT TO EXIST. APPROX. LOCATION OF EXIST. -8" PVC FORCE MAIN ┌─ STA: | 10+09 8" PVC FORCE MAIN CONNECT TO EXIST. 8" PVC FORCE MAIN - EXISTING FORCE MAIN TO BE (PER TEST HOLE DATA) 18 ABANDONED WITH FLOWABLE FILL PROPOSED 15" RCP STORM DRAIN - EXISTING FORCE MAIN TO BE REMOVED CUT AND CAP EXISTING 16 FORCE MAIN - CUT AND CAP EXISTING 14 SLOPE: 0.20% 14 FORCE MAIN 12 12 -PROPOSED 8" PV¢ (C900 DR18) FORCE MAIN PROPOSED 15" -RCP STORM DRAIN 10 8 6 STA: 12+01 (HORIZONTAL) (HORIZONTAL) (HORIZONTAL) (HORIZONTAL) (HORIZONTAL) (HORIZONTAL) (HORIZONTAL) (HORIZONTAL) 4 STA: 10+28 8" PVC 45' BEN (VERTICAL) STA: 10+30 STA: 10+45 STA: 10+45 B" PVC 45' BEN (HORIZONTAL) (HORIZONTAL) STA: 10+61 STA: 10+71 20.8 21.0 21.8 22.0 22.1 21.9 21.0 20.9 21.1 21.5 20.45 21.6 21.6 21.7 21.7 21.3 19.44 21.2 18.73 20.8 17.35 20.5 20.3 20.0 18.9 18.5 12.79 21.4 19.8 14.94 19.2 13.85 10+00 11+00 12+00 13+00 14+00 15+00 16+00 17+00 18+00 18+50

03/07/2023

LEGEND

3 PROP. FORCE MAIN

4\-/-/-ABANDON EXIST. FORCE MAIN

GENERAL NOTES

- CONTRACTOR SHALL VERIFY ELEVATIONS OF CONNECTION POINTS AND EXISTING UTILITIES THAT WILL BE CROSSED AND NOTIFY ENGINEER IMMEDIATELY OF ANY DISCREPANCIES BETWEEN PLAN INFORMATION AND FIELD
- CONTRACTOR SHALL COORDINATE ALL SHUTDOWNS OF THE EXISTING FORCE MAIN WITH THE OWNER. ALL EXISTING VALVES WILL BE OPERATED BY THE OWNER.
- DURING FORCE MAIN SHUTDOWN THE CONTRACTOR SHALL BE RESPONSIBLE FOR DEWATERING THE EXISTING FORCE MAIN AND FLOW CONTROL AT EXISTING PUMP STATIONS.
- CONTRACT SHALL BE PERFORMED IN ACCORDANCE WITH QUONSET DEVELOPMENT CORPORATION DESIGN AND CONSTRUCTION STANDARDS, LATEST VERSIONS AVAILABLE AT THE TIME OF BID.
- ACCORDANCE WITH AWWA C605 AND M23, LATEST EDITION.
- PVC FORCE MAIN PIPING SHALL BE HYDROSTATICALLY MAKING CONNECTIONS TO EXISTING PIPING. TEST PRESSURE SHALL BE 150 PSI.
- CONNECTIONS TO EXISTING PIPING SHALL BE MADE USING DUCTILE IRON LONG SOLID MECHANICAL JOINT SLEEVES WITH JOINT RESTRAINTS.
- TRACER WIRE SHALL BE INSTALLED ALONG ALL PVC PIPE INSTALLATIONS. TRACER WIRE SHALL BE ATTACHED TO THE TOP OF THE PIPE WITH PLASTIC STRAPPING AT A
- INSTALLATIONS.
- 10. REFER TO SHEET C9.2 FOR MEASUREMENT AND PAYMENT DESCRIPTIONS.
- SHORING SUPPORT REQUIRED AT PROPOSED SANITARY SEWER AND STORM SEWER CROSSING. CONTRACTOR TO SUBMIT SHOP DRAWING OF PROPOSED SHORING SUPPORT FOR APPROVAL.

SCALE IN FEET

Know what's below.
Call before you dig.

ADDENDUM NO. 2

1 DESCRIPTION DESCRIPTION

- PRIOR TO BEGINNING PROPOSED FORCE MAIN INSTALLATION CONDITIONS.
- PORTIONS OF THE WORK INCLUDED AS PART OF THIS
- PVC FORCE MAIN PIPING SHALL BE INSTALLED IN
- TESTED IN ACCORDANCE WITH AWWA C605. FORCE MAIN PIPING SHALL BE HYDROSTATICALLY TESTED PRIOR TO
- MINIMUM SPACING OF 10 FEET.
- UTILITY MARKING SHALL BE PLACED ALONG ALL PVC PIPE

QUONSET STATE AIRPORT RHODE ISLAND AIRPORT CORPORATION NORTH KINGSTOWN, RHODE ISLAND RUNWAY 16-34 RECONSTRUC

Quonset Quonset State Airport

KIMLEY-HORN AND ASSOCIATES, IN

VANASSE HANGEN BRUSTLIN, INC

Michael Albert Norby

REGISTERED PROFESSIONAL ENGINEER

CIVIL

150 AIRPORT STREET NORTH KINGSTOWN, RI 02852

PHONE: (401) 691-2000

404 WYMAN STREET SUITE 385

WALTHAM, MA 02451 PHONE: (781) 328-0676

1 CEDAR STREET

PROVIDENCE, RI 02903

SUITE 400

DATE	03/07/2023
DESIGNED BY	Y KHA
DRAWN BY	KHA
CHECKED BY	KHA
PROJECT NO	. 112214003
FILE NO.	SS-112214003
AIP NO.0-00-0	0000-000-0000
SHEET TITLE	

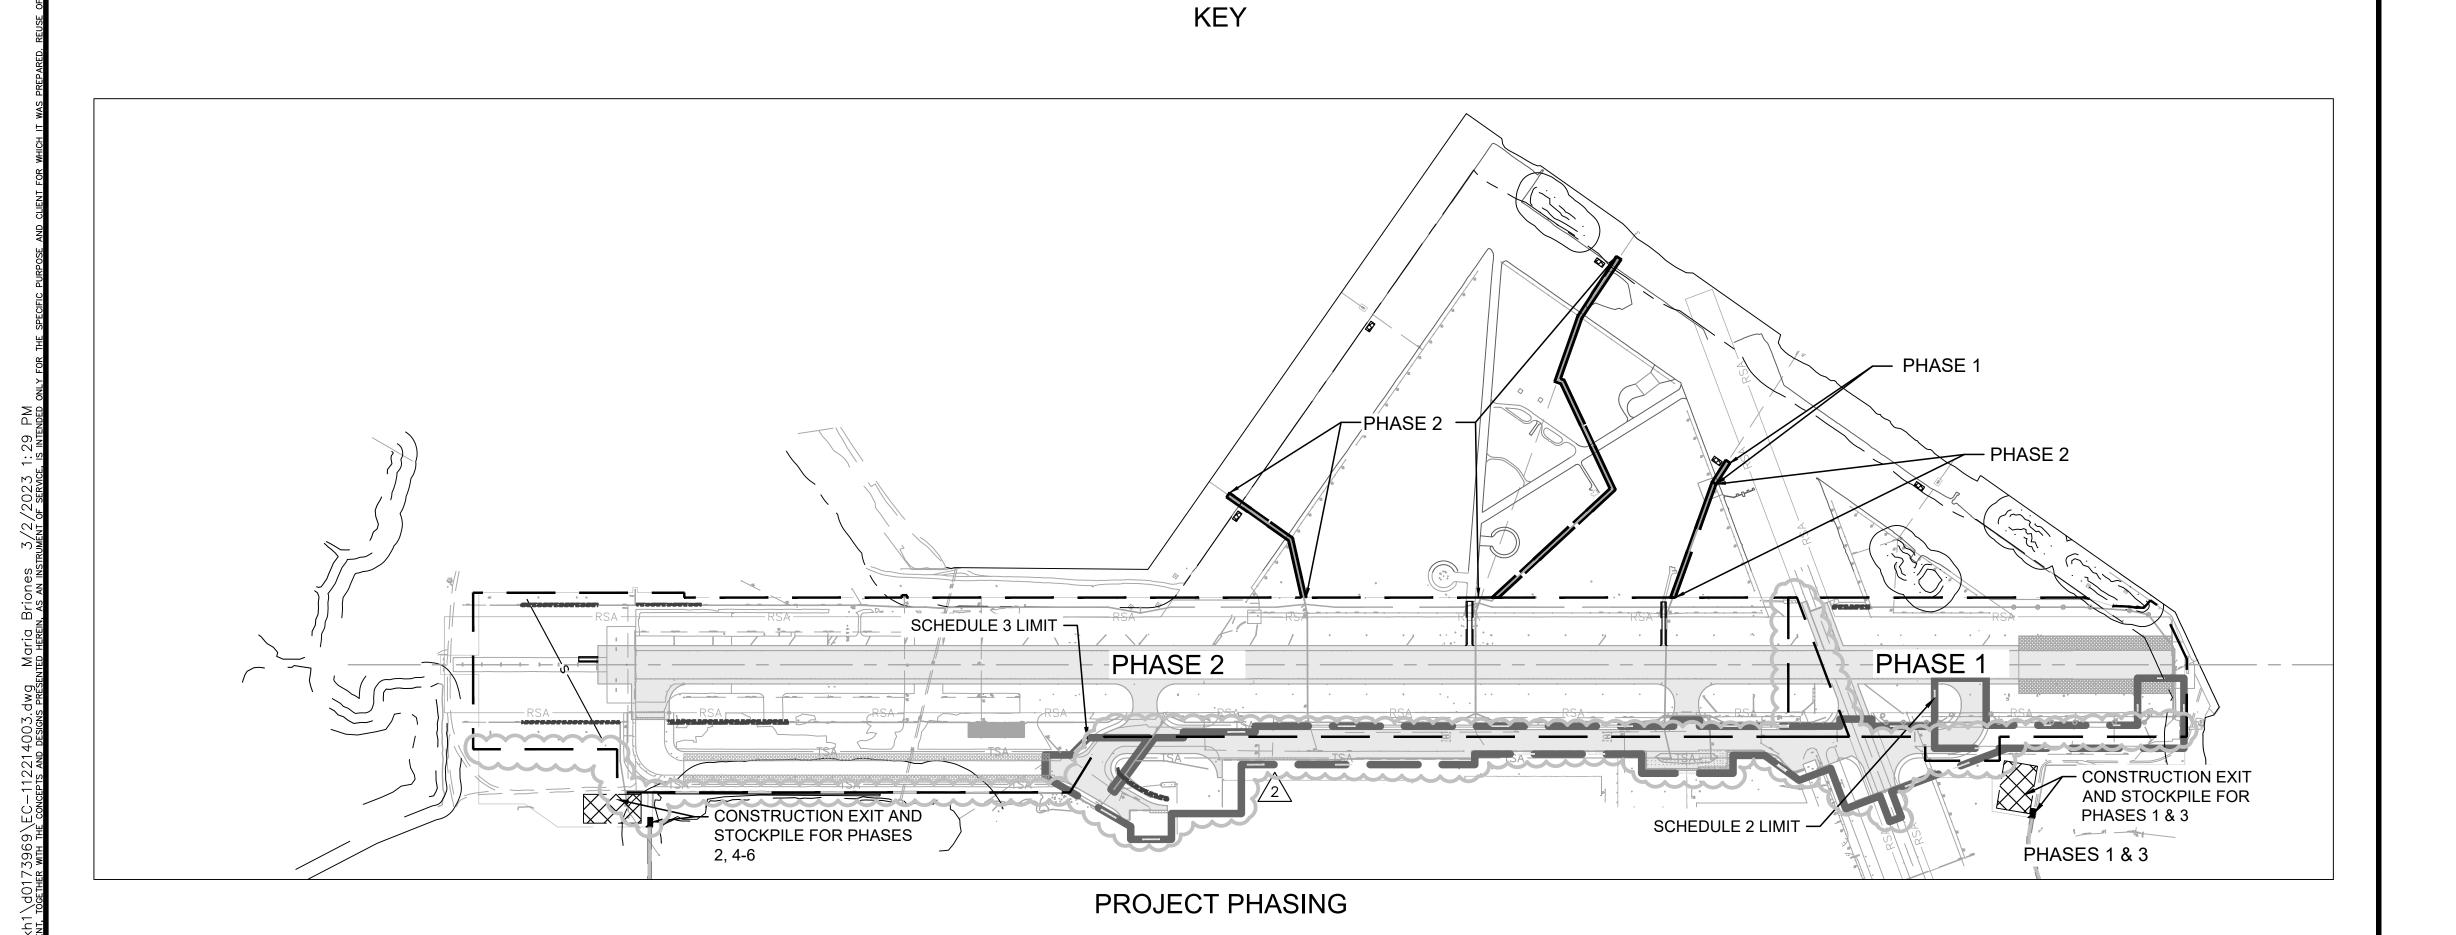
SANITARY SEWER

PLAN STA. XXX+XX TO STA. XXX+XX

SHEET NO.

C9.1

C15.7 C15.8 WEST NAMED NORTH TO VISION FOR THE PARTY OF THE PARTY OF



ADDENDUM NO. 2 03/07/2023

- REFER TO HORIZONTAL AND VERTICAL CONTROL PLAN, SHEET C1.14.
 - STATION AND OFFSET INFORMATION REFERENCES RUNWAY 16-34 CENTERLINE.
- 3. THE BASE INFORMATION SHOWN ON THESE PLANS IS BASED ON AVAILABLE RECORD PLANS.
- 4. THE PHASING LIMITS FOR SCHEDULE 3 ARE SHOWN HEREIN. HOWEVER, SCHEDULE 3 IS NOT PART OF THIS CONTRACT. REFER TO PHASING FOR SCHEDULES 1 AND 2 ON SHEETS C3.0 TO C3.8.

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404 WYMAN STREET

SUITE 385 WALTHAM, MA 02451 PHONE: (781) 328-0676

VANASSE HANGEN BRUSTLIN, INC.
1 CEDAR STREET
SLITE 400

RENEE CODOOR No. 6517

REGISTERED PROFESSIONAL ENGINEER

REV BY DESCRIPTION DATE CKD
2 MBB ADDENDUM NO. 2 03/07/23 KMC

QUONSET STATE AIRPORT
RHODE ISLAND AIRPORT CORPORATION
NORTH KINGSTOWN, RHODE ISLAND
RUNWAY 16-34 RECONSTRUCTION

DATE	03/07/2023
DESIGNED BY	EMO
DRAWN BY	EMO
CHECKED BY	KMC
PROJECT NO.	112214003
FILE NO. EC	-112214003

FILE NO. EC-112214003

AIP NO. 0-00-0000-0000-0000

SHEET TITLE

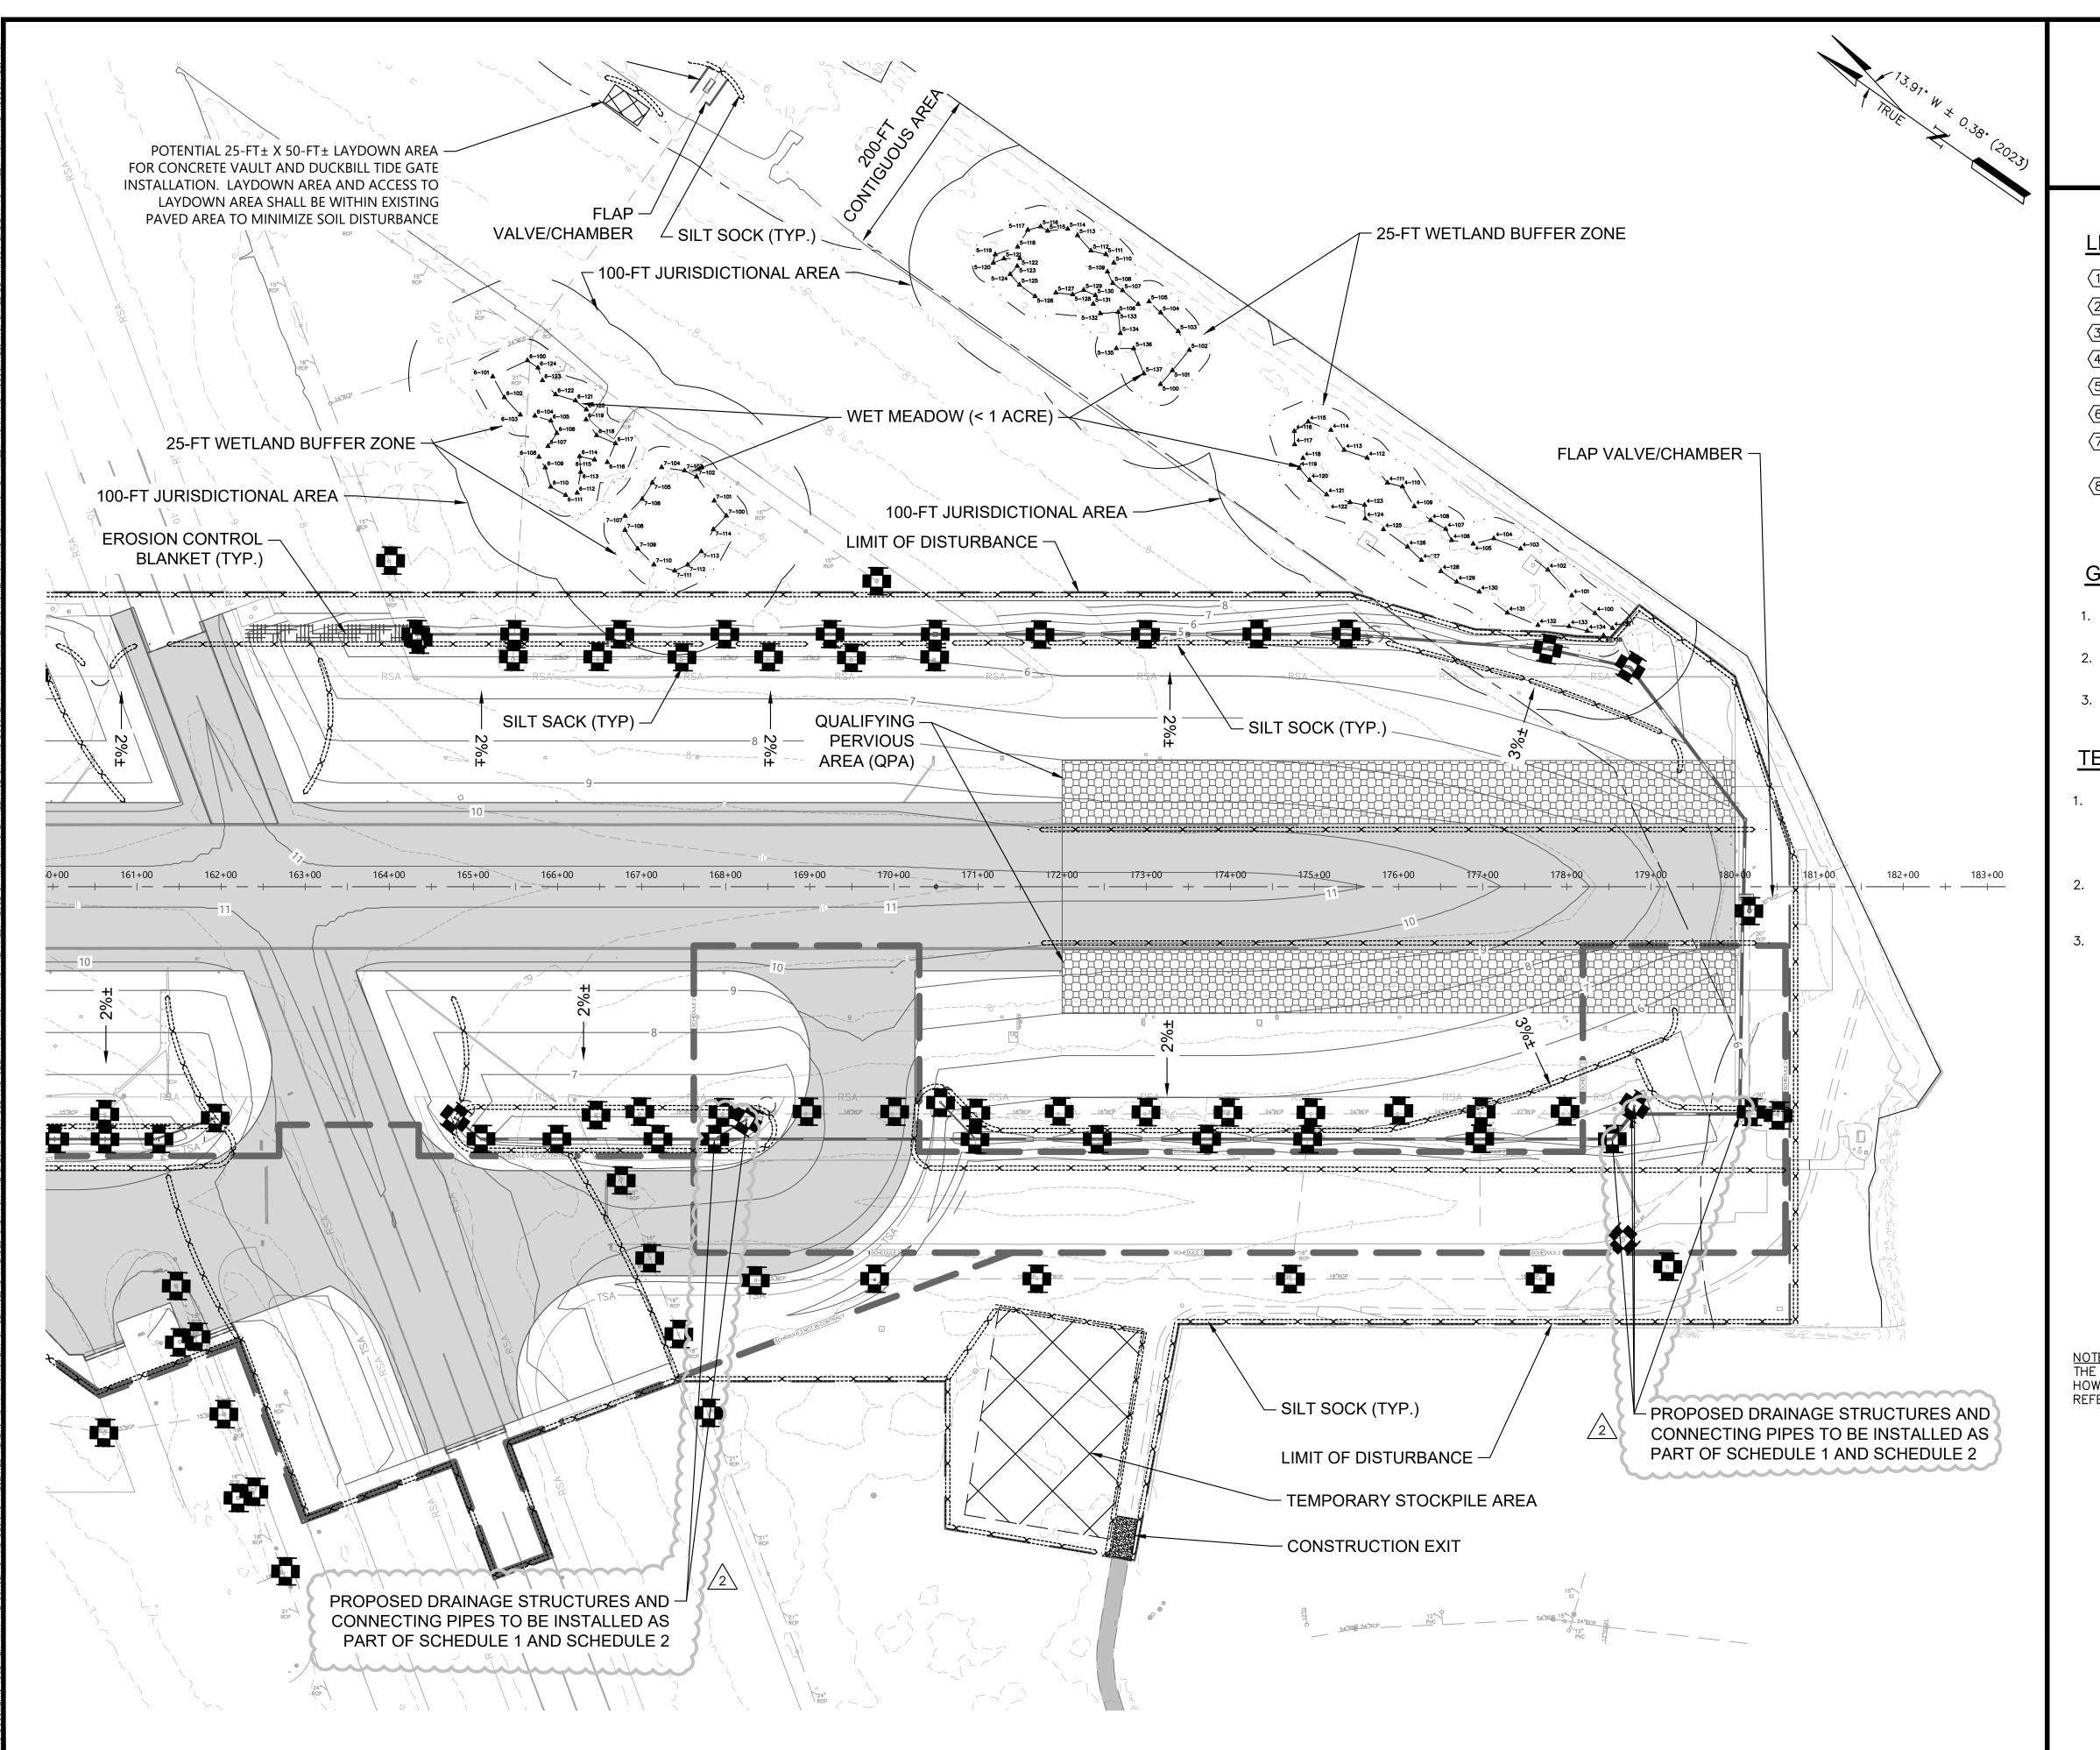
SOIL EROSION AND SEDIMENT CONTROL PLAN

195 OF 297

SHEET NO.
C14.0

SCALE IN FEET

Know what's below.
Call before you dig.



ADDENDUM NO. 2

03/07/2023

LEGEND

FLAP VALVE/CHAMBER 2 QUALIFYING PERVIOUS AREA (QPA)

(3) CATCH BASIN

5 DRAIN PIPE

(6) CEEEEEE SILT SOCK

8 EROSION CONTROL BLANKET

GENERAL NOTES

- REFER TO HORIZONTAL AND VERTICAL CONTROL PLAN,
- 2. STATION AND OFFSET INFORMATION REFERENCES RUNWAY 16-34 CENTERLINE.
- 3. PROPOSED GRADING PROVIDED BY KIMLEY HORN IN CAD FILE oFG-112214003.dwg DATED 1/31/2023.

TEMPORARY SEDIMENT TRAPS

- TEMPORARY SEDIMENT TRAPS SHALL BE CONSTRUCTED OF SILT SOCK BERMS INTENTIONALLY PLACED TO ACHIEVE THE REQUIRED STORAGE VOLUME OF 134 CY PER CONTRIBUTING ACRE, AS DESCRIBED IN THE RHODE ISLAND EROSION AND SEDIMENT CONTROL HANDBOOK
- 50% WET STORAGE SHALL BE PROVIDED BY PLACING SUPPLEMENTAL MATERIAL OVER THE BOTTOM HALF OF THE SILT SOCK, AS SEEN ON THE SILT SOCK DETAIL.
- THE TABLE BELOW SHOWS THE MAXIMUM DRAINAGE FLOW PATH DISTANCE THAT CAN BE DIRECTED TO A 12" SILT SOCK IN ORDER TO ACHIEVE THE REQUIRED STORAGE VOLUME, BASED ON THE SLOPE OF THE CONTRIBUTING DRAINAGE AREA. THE CONTRACTOR MAY CONSULT THE TABLE BELOW SHOULD SITE CONDITIONS CHANGE FROM WHAT IS SHOWN ON THIS PLAN.

Temporary Sediment Trap Calculations

Slope	Max. Flow Path
1%	600 FT
2%	300 FT
3%	200 FT
4%	150 FT
5%	120 FT
6%	100 FT
7%	85 FT
8%	75 FT
9%	65 FT
10%	60 FT

NOTE: THE LIMITS FOR SCHEDULE 3 ARE SHOWN HEREIN. HOWEVER, SCHEDULE 3 IS NOT PART OF THIS CONTRACT. REFER TO SCHEDULE 1 AND 2 PLANS AS DIRECTED.





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VANASSE HANGEN BRUSTLIN, INC 1 CEDAR STREET SUITE 400

PROVIDENCE, RI 02903

ROFESSIONAL ENGINEE

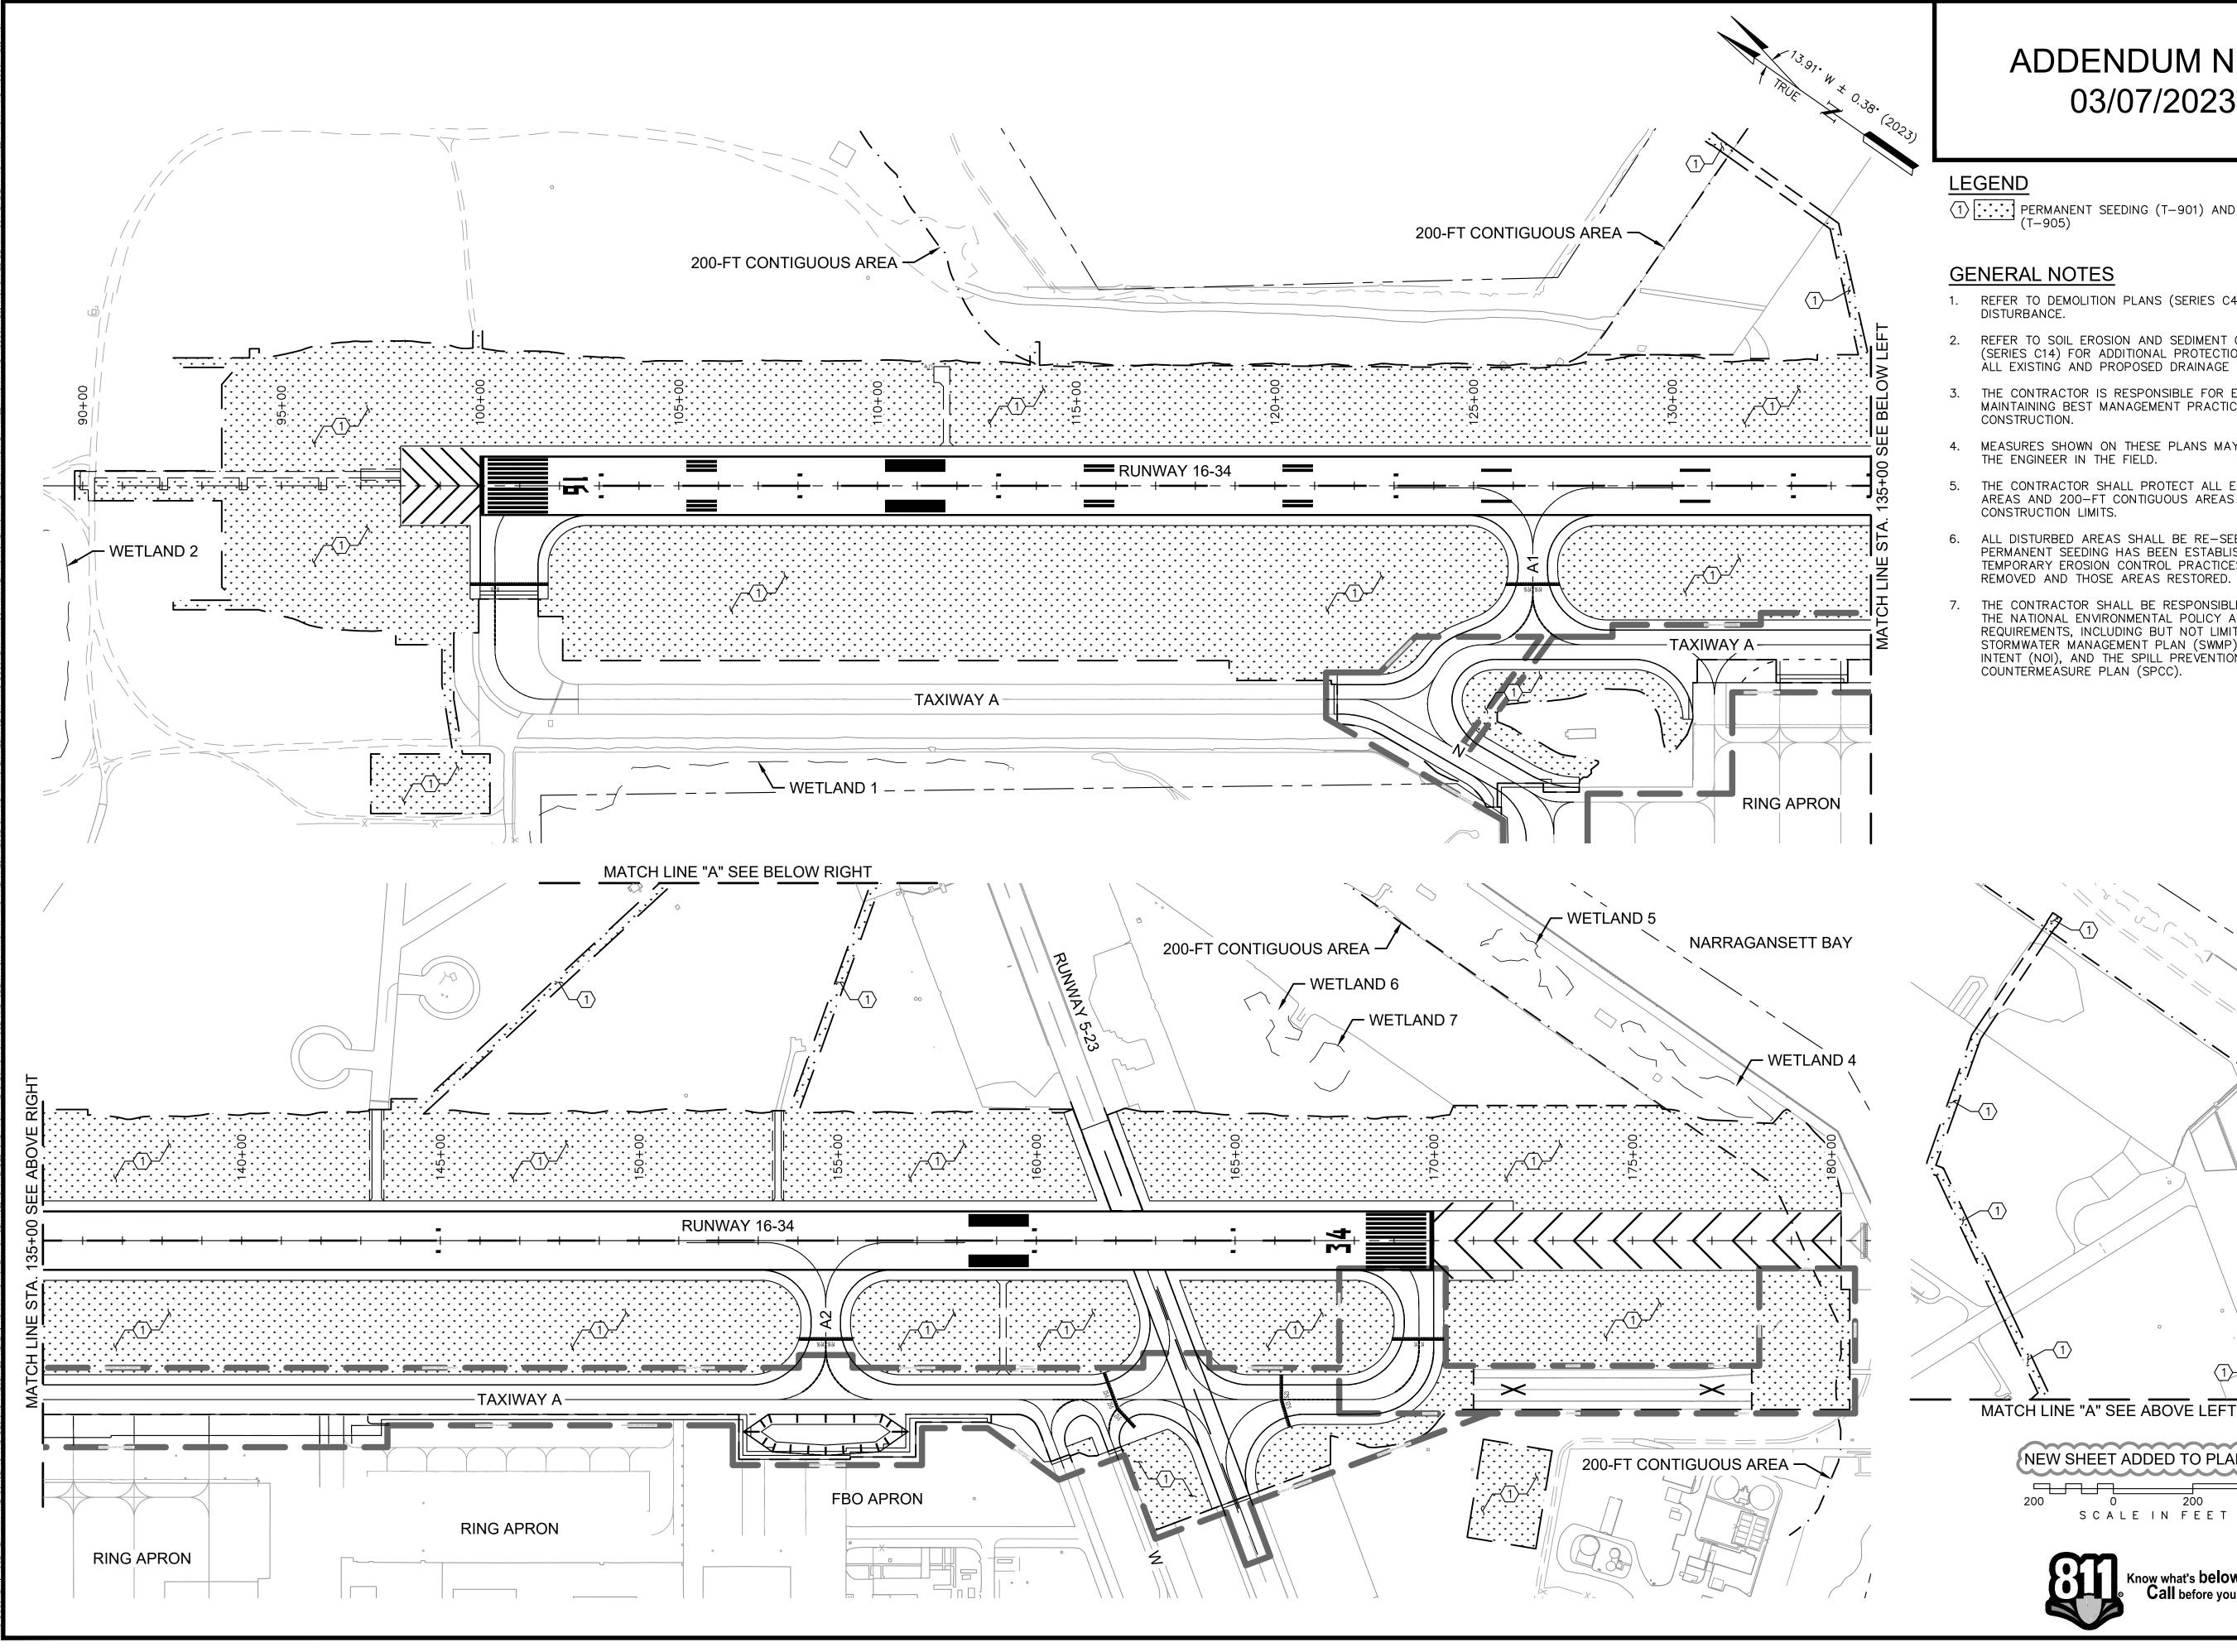
QUONSET (
RHODE ISLAND A
NORTH KINGST
RUNWAY 16-34

DATE 03/07/2023 **DESIGNED BY** EMC DRAWN BY CHECKED BY PROJECT NO. 112214003 FILE NO. EC-112214003 AIP NO. 0-00-0000-000-0000

SOIL EROSION AND SEDIMENT **CONTROL PLAN**

SHEET NO. C14.6

SHEET TITLE



ADDENDUM NO. 2 03/07/2023

LEGEND

PERMANENT SEEDING (T-901) AND HYDROMULCH (T-905)

GENERAL NOTES

- 1. REFER TO DEMOLITION PLANS (SERIES C4) FOR LIMITS OF DISTURBANCE.
- REFER TO SOIL EROSION AND SEDIMENT CONTROL PLANS (SERIES C14) FOR ADDITIONAL PROTECTION MEASURES FOR ALL EXISTING AND PROPOSED DRAINAGE FACILITIES.
- THE CONTRACTOR IS RESPONSIBLE FOR ESTABLISHING AND MAINTAINING BEST MANAGEMENT PRACTICES DURING CONSTRUCTION.
- MEASURES SHOWN ON THESE PLANS MAY BE MODIFIED BY THE ENGINEER IN THE FIELD.
- THE CONTRACTOR SHALL PROTECT ALL EXISTING WETLAND AREAS AND 200-FT CONTIGUOUS AREAS OUTSIDE THE CONSTRUCTION LIMITS.
- ALL DISTURBED AREAS SHALL BE RE-SEEDED. ONCE PERMANENT SEEDING HAS BEEN ESTABLISHED, ALL TEMPORARY EROSION CONTROL PRACTICES SHALL BE REMOVED AND THOSE AREAS RESTORED.
- THE CONTRACTOR SHALL BE RESPONSIBLE FOR MEETING THE NATIONAL ENVIRONMENTAL POLICY ACT (NEPA)
 REQUIREMENTS, INCLUDING BUT NOT LIMITED TO, THE
 STORMWATER MANAGEMENT PLAN (SWMP), NOTICE OF
 INTENT (NOI), AND THE SPILL PREVENTION, CONTROL AND COUNTERMEASURE PLAN (SPCC).

NEW SHEET ADDED TO PLAN SET

O 200 SCALE IN FEET

Know what's below.
Call before you dig.




QUONSET STATE AIRPORT 150 AIRPORT STREET NORTH KINGSTOWN, RI 02852 PHONE: (401) 691-2000

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SUITE 400 PROVIDENCE, RI 02903



REGISTERED PROFESSIONAL ENGINEER


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CKD	MAN											
DATE	03/07/23 MAN											
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DATE	03/07/2023
DESIGNED BY	MPB
DRAWN BY	MPB
CHECKED BY	MAN
PROJECT NO.	112214003
FILE NO. EC01	-112214003
AIP NO.0-00-000	00-000-0000

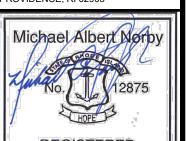SHEET TITLE SOIL EROSION AND SEDIMENT **CONTROL PLAN** ALL BID SCHEDULES


SHEET NO.

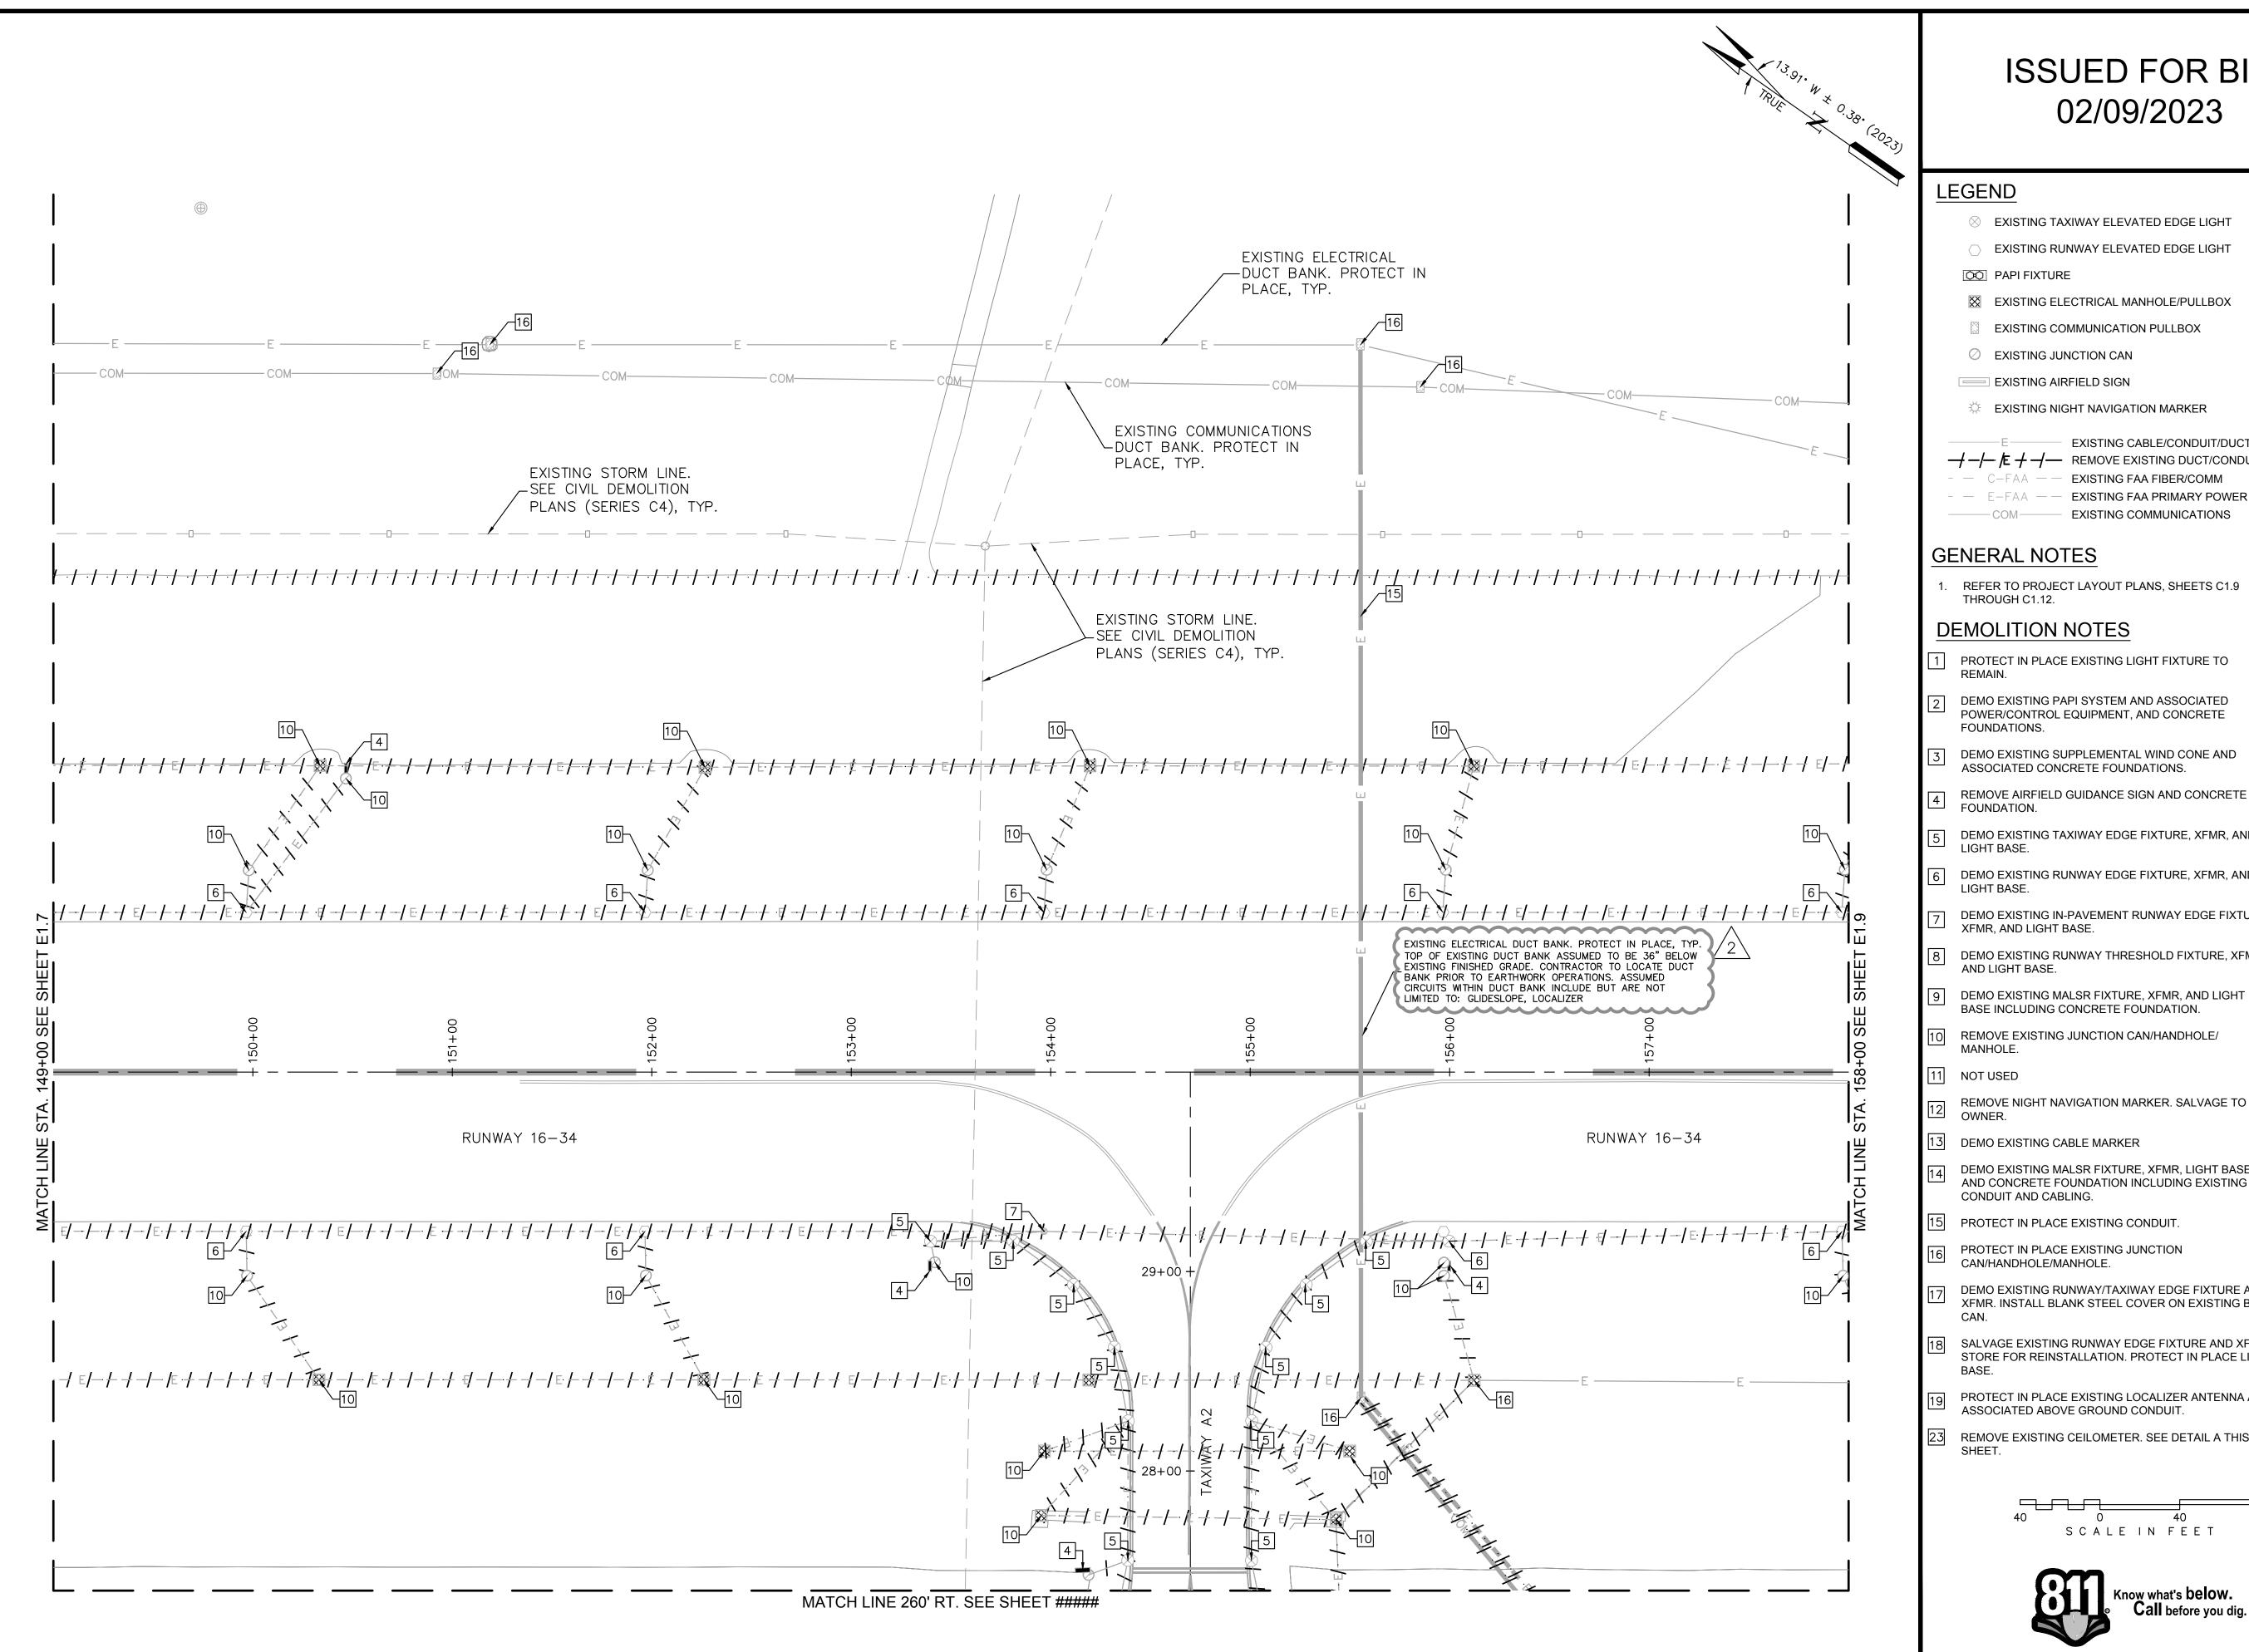C14.9 204 OF 297



LEGEND

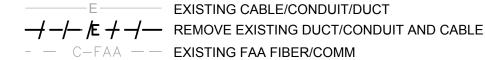- EXISTING TAXIWAY ELEVATED EDGE LIGHT.
- PAPI FIXTURE
- EXISTING COMMUNICATION PULLBOX
- EXISTING JUNCTION CAN
- **EXISTING AIRFIELD SIGN**
- EXISTING NIGHT NAVIGATION MARKER




- - E-FAA -- EXISTING FAA PRIMARY POWER —— COM——— EXISTING COMMUNICATIONS

GENERAL NOTES

REFER TO PROJECT LAYOUT PLANS, SHEETS C1.9 THROUGH C1.12.

DEMOLITION NOTES

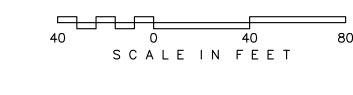- PROTECT IN PLACE EXISTING LIGHT FIXTURE TO
- DEMO EXISTING PAPI SYSTEM AND ASSOCIATED POWER/CONTROL EQUIPMENT, AND CONCRETE FOUNDATIONS.
- DEMO EXISTING SUPPLEMENTAL WIND CONE AND ASSOCIATED CONCRETE FOUNDATIONS.
- REMOVE AIRFIELD GUIDANCE SIGN AND CONCRETE FOUNDATION.
- DEMO EXISTING TAXIWAY EDGE FIXTURE, XFMR, AND LIGHT BASE.
- DEMO EXISTING RUNWAY EDGE FIXTURE, XFMR, AND LIGHT BASE.
- DEMO EXISTING IN-PAVEMENT RUNWAY EDGE FIXTURE, XFMR, AND LIGHT BASE.
- DEMO EXISTING RUNWAY THRESHOLD FIXTURE, XFMR,
- AND LIGHT BASE.
- BASE INCLUDING CONCRETE FOUNDATION.
- REMOVE EXISTING JUNCTION CAN/HANDHOLE/
- 1 NOT USED
- REMOVE NIGHT NAVIGATION MARKER. SALVAGE TO
- DEMO EXISTING CABLE MARKER
- DEMO EXISTING MALSR FIXTURE, XFMR, LIGHT BASE AND CONCRETE FOUNDATION INCLUDING EXISTING CONDUIT AND CABLING.
- PROTECT IN PLACE EXISTING CONDUIT.
- PROTECT IN PLACE EXISTING JUNCTION CAN/HANDHOLE/MANHOLE.
- DEMO EXISTING RUNWAY/TAXIWAY EDGE FIXTURE AND XFMR. INSTALL BLANK STEEL COVER ON EXISTING BASE
- SALVAGE EXISTING RUNWAY EDGE FIXTURE AND XFMR. STORE FOR REINSTALLATION. PROTECT IN PLACE LIGHT
- PROTECT IN PLACE EXISTING LOCALIZER ANTENNA AND ASSOCIATED ABOVE GROUND CONDUIT.
- REMOVE EXISTING CEILOMETER. SEE DETAIL A THIS SHEET.





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VANASSE HANGEN BRUSTLIN, INC. 1 CEDAR STREET

SUITE 400 PROVIDENCE, RI 02903

JOSEPH BRADSHAW REGISTERED PROFESSIONAL ENGINEER ELECTRICAL


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DATE	03/07/23									
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QUONSE RHODE ISLAND NORTH KING RUNWAY 16-3

02/09/2023 **DESIGNED BY** DRAWN BY **CHECKED BY** PROJECT NO. 112214003 FILE NO. ED01-112214003 AIP NO. 0-00-0000-000-0000 SHEET TITLE ELECTRICAL **DEMOLITION PLAN RUNWAY 16-34** BID SCHEDULE 3


STA. 149+00 TO STA. 158+00 SHEET NO.
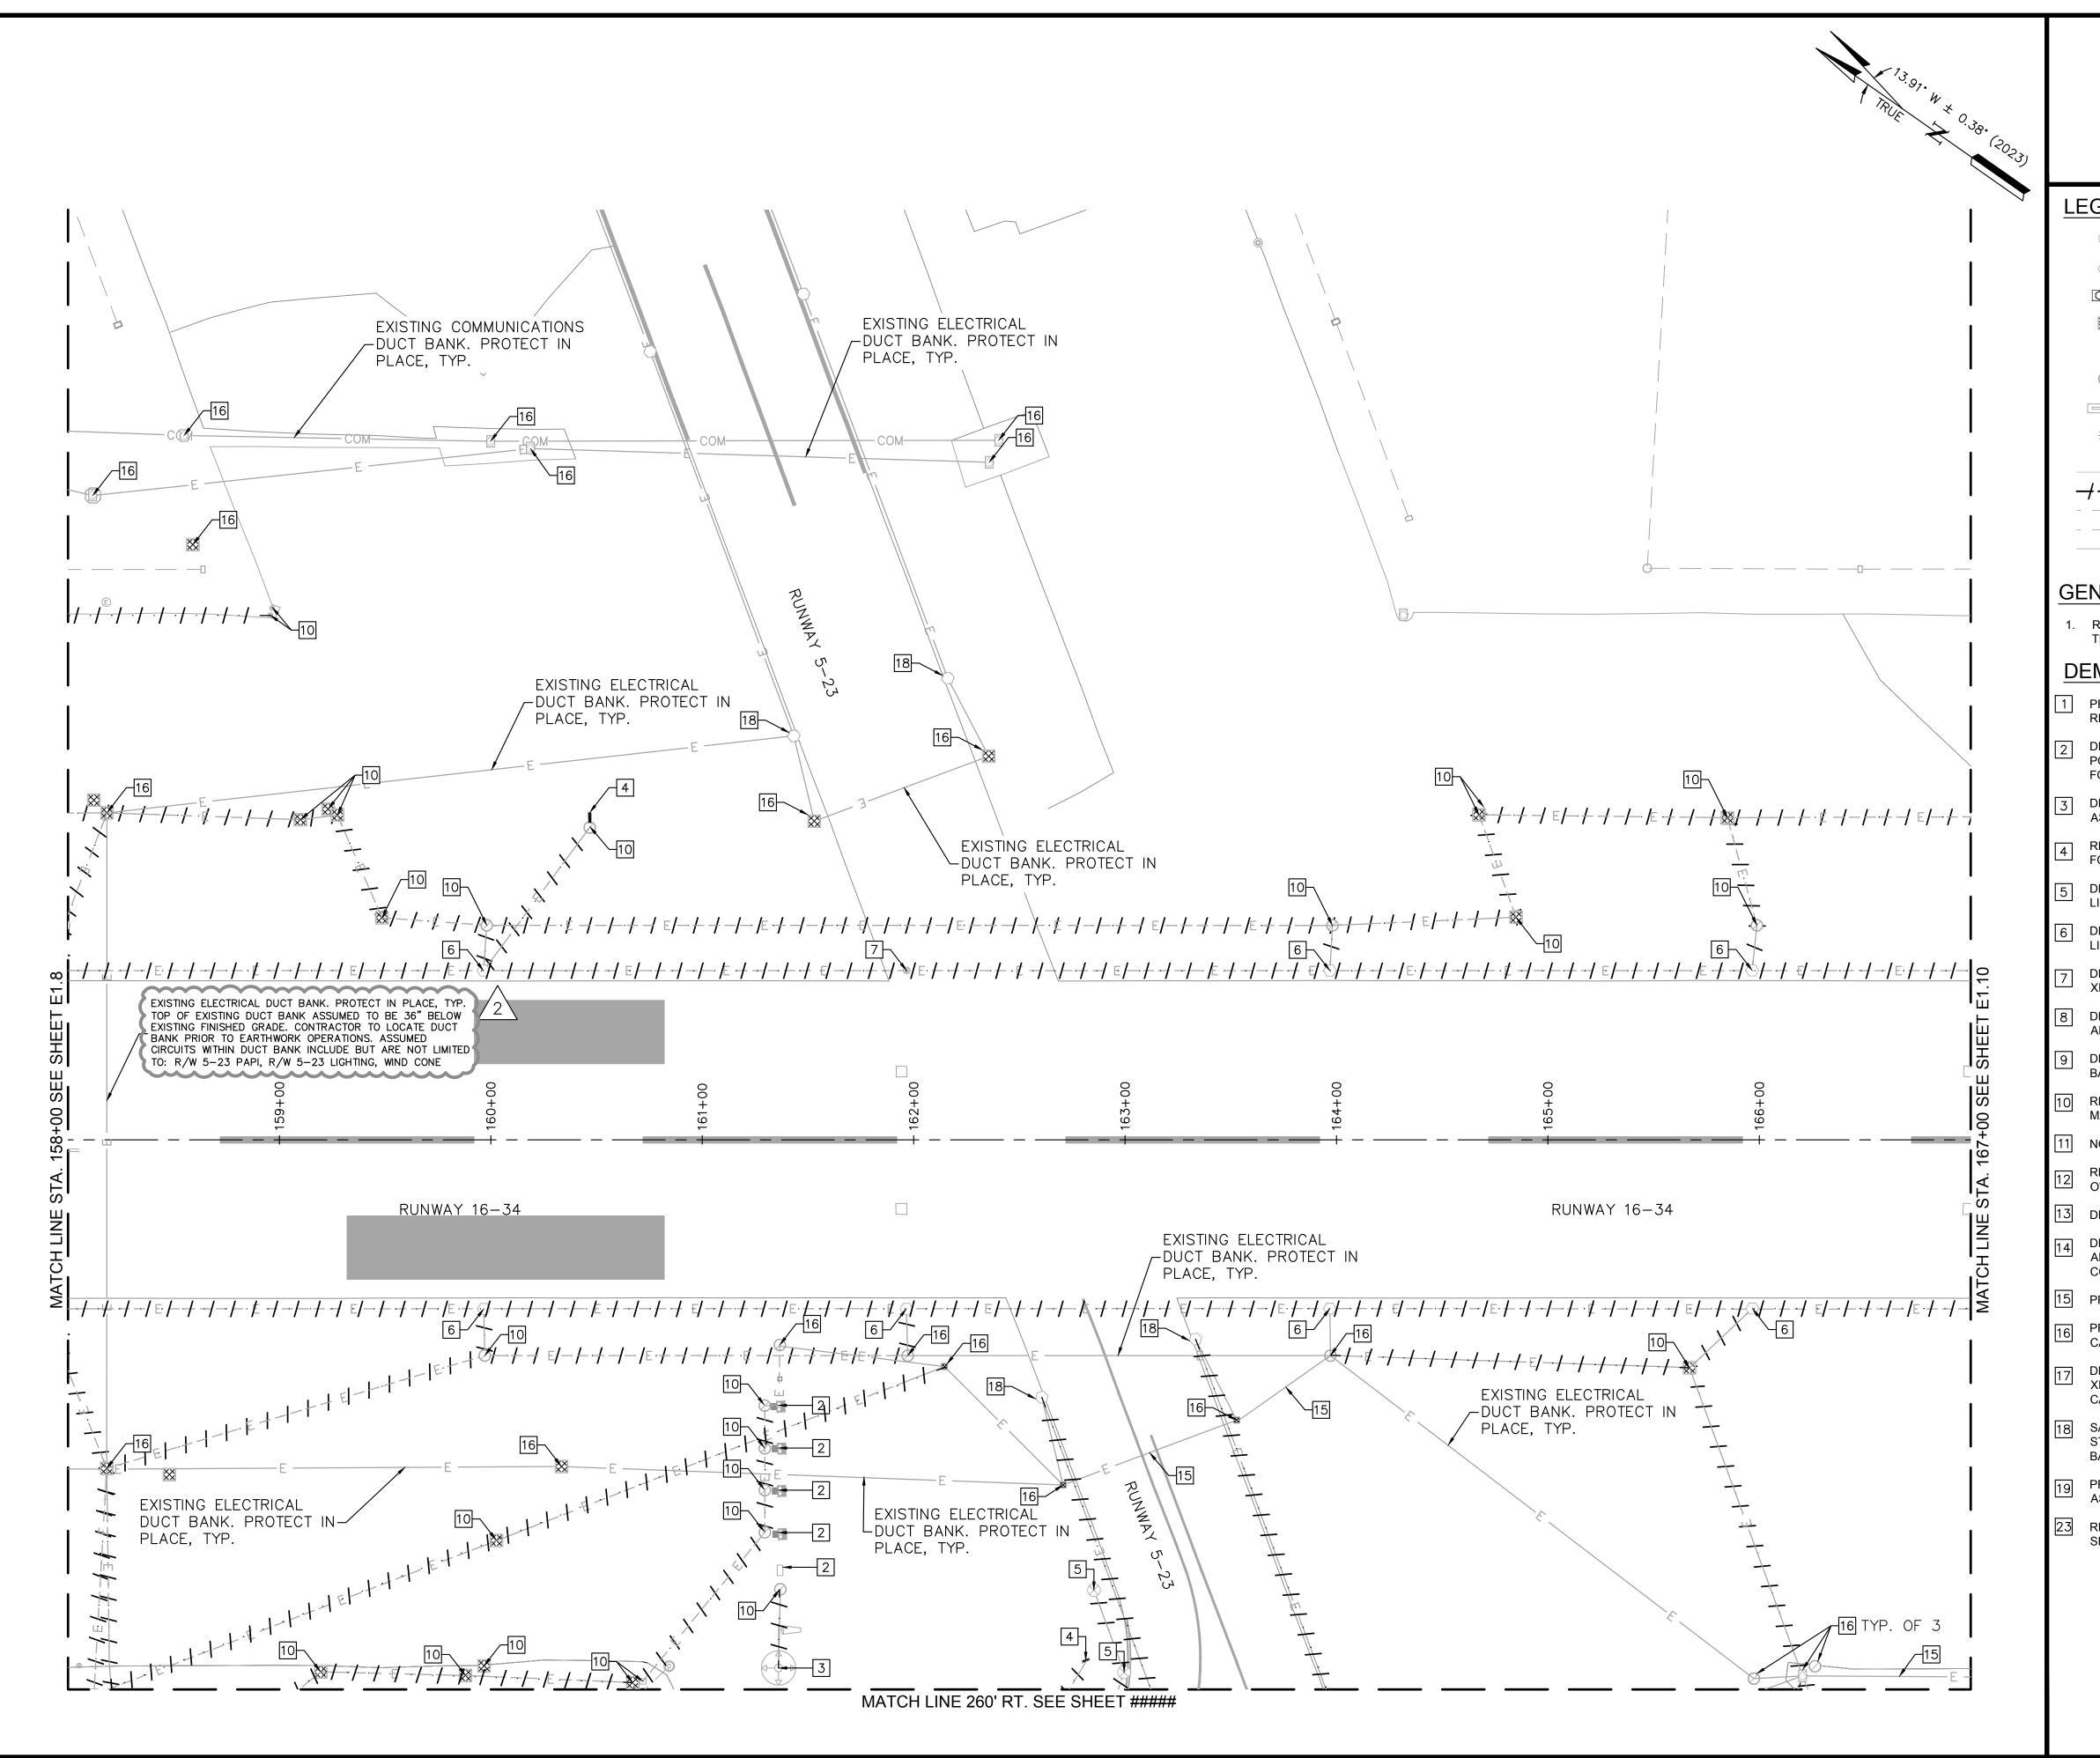
> E1.8 202 OF 286



LEGEND

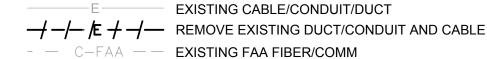- EXISTING TAXIWAY ELEVATED EDGE LIGHT
- PAPI FIXTURE
- EXISTING COMMUNICATION PULLBOX
- EXISTING JUNCTION CAN
- **EXISTING AIRFIELD SIGN**
- EXISTING NIGHT NAVIGATION MARKER



- - E-FAA -- EXISTING FAA PRIMARY POWER — COM — EXISTING COMMUNICATIONS

GENERAL NOTES

REFER TO PROJECT LAYOUT PLANS, SHEETS C1.9 THROUGH C1.12.

DEMOLITION NOTES

- 1 PROTECT IN PLACE EXISTING LIGHT FIXTURE TO
- DEMO EXISTING PAPI SYSTEM AND ASSOCIATED POWER/CONTROL EQUIPMENT, AND CONCRETE FOUNDATIONS.
- DEMO EXISTING SUPPLEMENTAL WIND CONE AND ASSOCIATED CONCRETE FOUNDATIONS.
- REMOVE AIRFIELD GUIDANCE SIGN AND CONCRETE FOUNDATION.
- DEMO EXISTING TAXIWAY EDGE FIXTURE, XFMR, AND LIGHT BASE.
- DEMO EXISTING RUNWAY EDGE FIXTURE, XFMR, AND LIGHT BASE.
- DEMO EXISTING IN-PAVEMENT RUNWAY EDGE FIXTURE, XFMR, AND LIGHT BASE.
- DEMO EXISTING RUNWAY THRESHOLD FIXTURE, XFMR,
- AND LIGHT BASE.
- DEMO EXISTING MALSR FIXTURE, XFMR, AND LIGHT BASE INCLUDING CONCRETE FOUNDATION.
- REMOVE EXISTING JUNCTION CAN/HANDHOLE/ MANHOLE.
- NOT USED
- REMOVE NIGHT NAVIGATION MARKER. SALVAGE TO
- DEMO EXISTING CABLE MARKER
- DEMO EXISTING MALSR FIXTURE, XFMR, LIGHT BASE AND CONCRETE FOUNDATION INCLUDING EXISTING CONDUIT AND CABLING.
- PROTECT IN PLACE EXISTING CONDUIT.
- PROTECT IN PLACE EXISTING JUNCTION CAN/HANDHOLE/MANHOLE.
- DEMO EXISTING RUNWAY/TAXIWAY EDGE FIXTURE AND XFMR. INSTALL BLANK STEEL COVER ON EXISTING BASE
- SALVAGE EXISTING RUNWAY EDGE FIXTURE AND XFMR. STORE FOR REINSTALLATION. PROTECT IN PLACE LIGHT
- PROTECT IN PLACE EXISTING LOCALIZER ANTENNA AND ASSOCIATED ABOVE GROUND CONDUIT.
- REMOVE EXISTING CEILOMETER. SEE DETAIL A THIS SHEET.





QUONSET STATE AIRPORT 150 AIRPORT STREET NORTH KINGSTOWN, RI 02852 PHONE: (401) 691-2000

404 WYMAN STREET

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PHONE: (781) 328-0676

VANASSE HANGEN BRUSTLIN, INC 1 CEDAR STREET SUITE 400

PROVIDENCE, RI 02903

JOSEPH BRADSHAW REGISTERED PROFESSIONAL ENGINEER **ELECTRICAL**

02/09/2023									
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DATE	03/07/23								
DESCRIPTION	ADDENDUM NO. 2								
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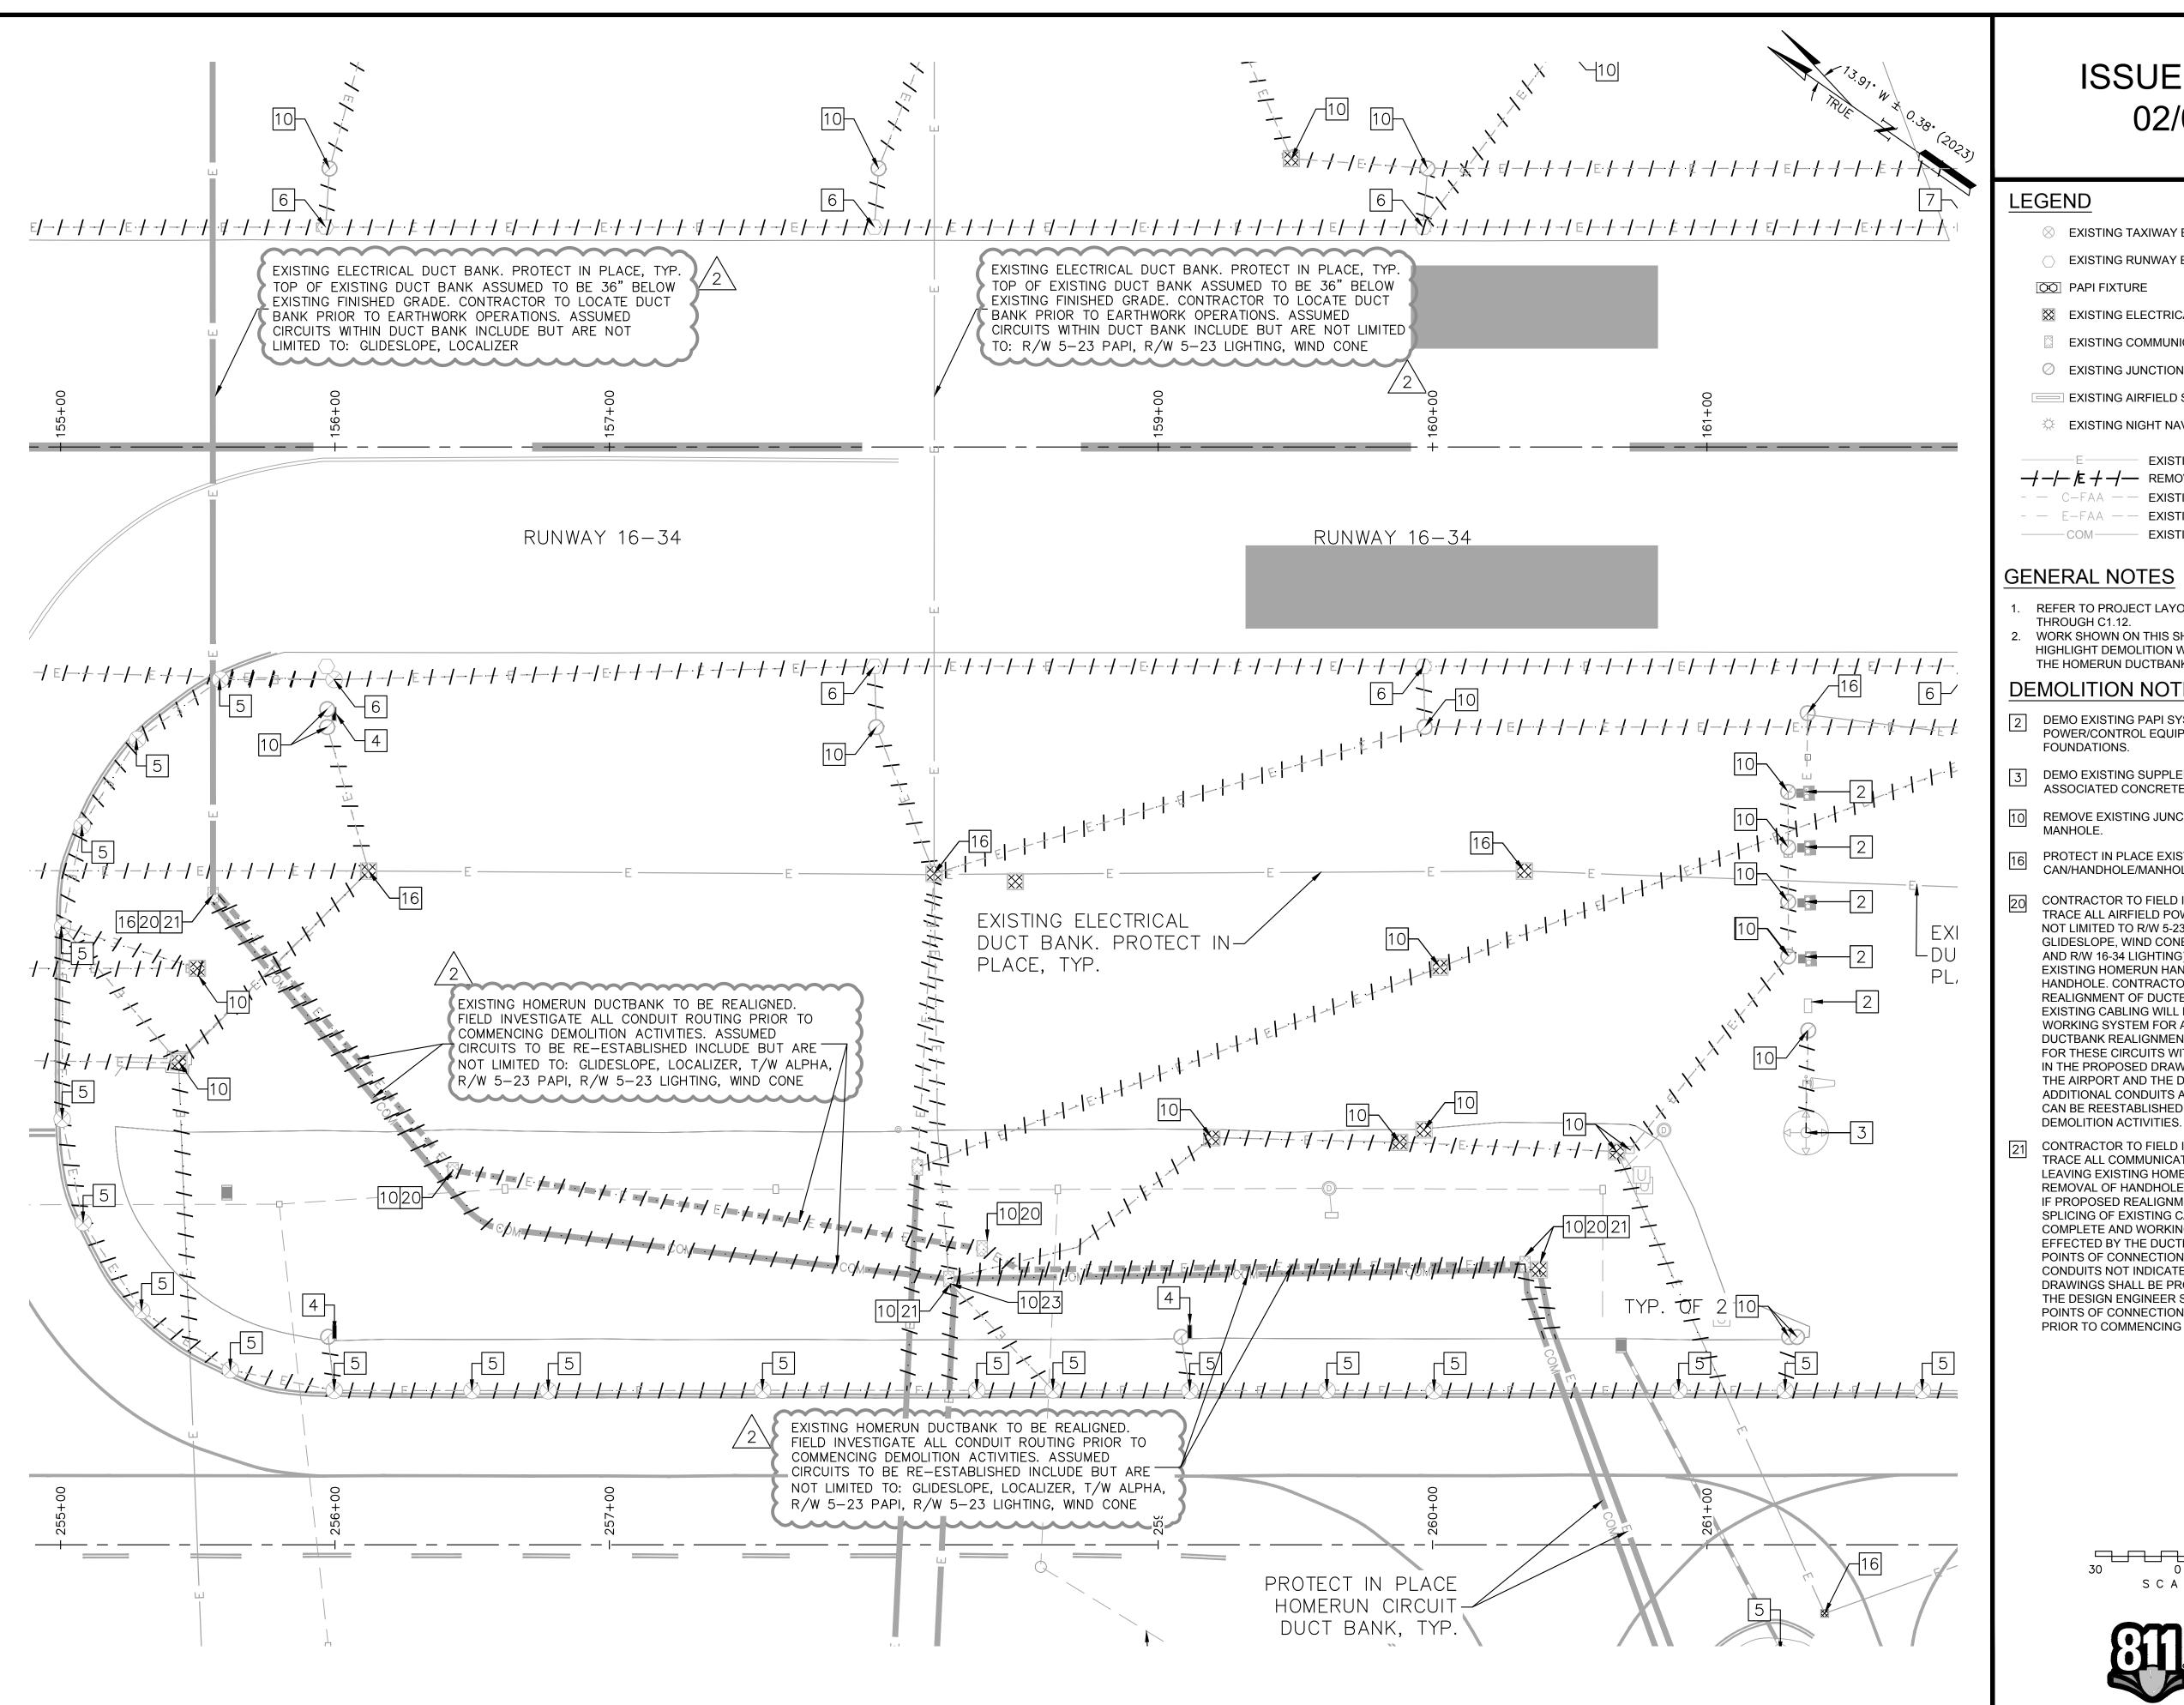
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02/09/2023 **DESIGNED BY** DRAWN BY CHECKED BY PROJECT NO. 112214003 FILE NO. ED01-112214003 AIP NO. 0-00-0000-000-000


SHEELECTRICAL **DEMOLITION**

PLANS **RUNWAY 16-34** BID SCHEDULE 3 STA. 158+00 TO

SHEET NO." E1.9 203 OF 286



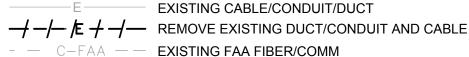- PAPI FIXTURE
- EXISTING COMMUNICATION PULLBOX
- EXISTING JUNCTION CAN
- EXISTING AIRFIELD SIGN
- EXISTING NIGHT NAVIGATION MARKER



- - E-FAA -- EXISTING FAA PRIMARY POWER

— COM — EXISTING COMMUNICATIONS

GENERAL NOTES

- REFER TO PROJECT LAYOUT PLANS, SHEETS C1.9 THROUGH C1.12.
- 2. WORK SHOWN ON THIS SHEET IS INTENDED TO HIGHLIGHT DEMOLITION WORK IN THE AREA OF THE HOMERUN DUCTBANK REALIGNMENT.

DEMOLITION NOTES

- DEMO EXISTING PAPI SYSTEM AND ASSOCIATED POWER/CONTROL EQUIPMENT, AND CONCRETE FOUNDATIONS.
- DEMO EXISTING SUPPLEMENTAL WIND CONE AND ASSOCIATED CONCRETE FOUNDATIONS.
- 10 REMOVE EXISTING JUNCTION CAN/HANDHOLE/ MANHOLE.
- PROTECT IN PLACE EXISTING JUNCTION CAN/HANDHOLE/MANHOLE.
- 20 CONTRACTOR TO FIELD INVESTIGATE TO IDENTIFY AND TRACE ALL AIRFIELD POWER CIRCUITS (INCLUDING BUT NOT LIMITED TO R/W 5-23 LIGHTING, T/W A LIGHTING, GLIDESLOPE, WIND CONES, LOCALIZER, R/W 5-23 PAPI. AND R/W 16-34 LIGHTING) ENTERING AND LEAVING EXISTING HOMERUN HANDHOLE PRIOR TO REMOVAL OF REALIGNMENT OF DUCTBANK AND SPLICING OF EXISTING CABLING WILL ENABLE A COMPLETE AND WORKING SYSTEM FOR ALL CIRCUITS EFFECTED BY THE DUCTBANK REALIGNMENT. ANY POINTS OF CONNECTION FOR THESE CIRCUITS WITH CONDUITS NOT INDICATED IN THE PROPOSED DRAWINGS SHALL BE PROVIDED TO THE AIRPORT AND THE DESIGN ENGINEER SO ADDITIONAL CONDUITS AND POINTS OF CONNECTION CAN BE REESTABLISHED PRIOR TO COMMENCING
- CONTRACTOR TO FIELD INVESTIGATE TO IDENTIFY AND TRACE ALL COMMUNICATIONS CABLING ENTERING AND LEAVING EXISTING HOMERUN HANDHOLE PRIOR TO REMOVAL OF HANDHOLE. CONTRACTOR TO DETERMINE IF PROPOSED REALIGNMENT OF DUCTBANK AND SPLICING OF EXISTING CABLING WILL ENABLE A COMPLETE AND WORKING SYSTEM FOR ALL SYSTEMS EFFECTED BY THE DUCTBANK REALIGNMENT. ANY POINTS OF CONNECTION FOR THESE SYSTEMS WITH CONDUITS NOT INDICATED IN THE PROPOSED DRAWINGS SHALL BE PROVIDED TO THE AIRPORT AND THE DESIGN ENGINEER SO ADDITIONAL CONDUITS AND POINTS OF CONNECTION CAN BE REESTABLISHED PRIOR TO COMMENCING DEMOLITION ACTIVITIES.





QUONSET STATE AIRPORT 150 AIRPORT STREET NORTH KINGSTOWN, RI 02852

PHONE: (401) 691-2000

Kimley»Horn

© 2023 KIMLEY-HORN AND ASSOCIATES, IN 404 WYMAN STREET SUITE 385 WALTHAM, MA 02451 PHONE: (781) 328-0676

VANASSE HANGEN BRUSTLIN, INC 1 CEDAR STREET

SUITE 400 PROVIDENCE, RI 02903

JOSEPH BRADSHAW REGISTERED PROFESSIONAL ENGINEER ELECTRICAL

	02/09/2023									
CKD	ADB									
DATE	03/07/23									
DESCRIPTION	ADDENDUM NO. 2									
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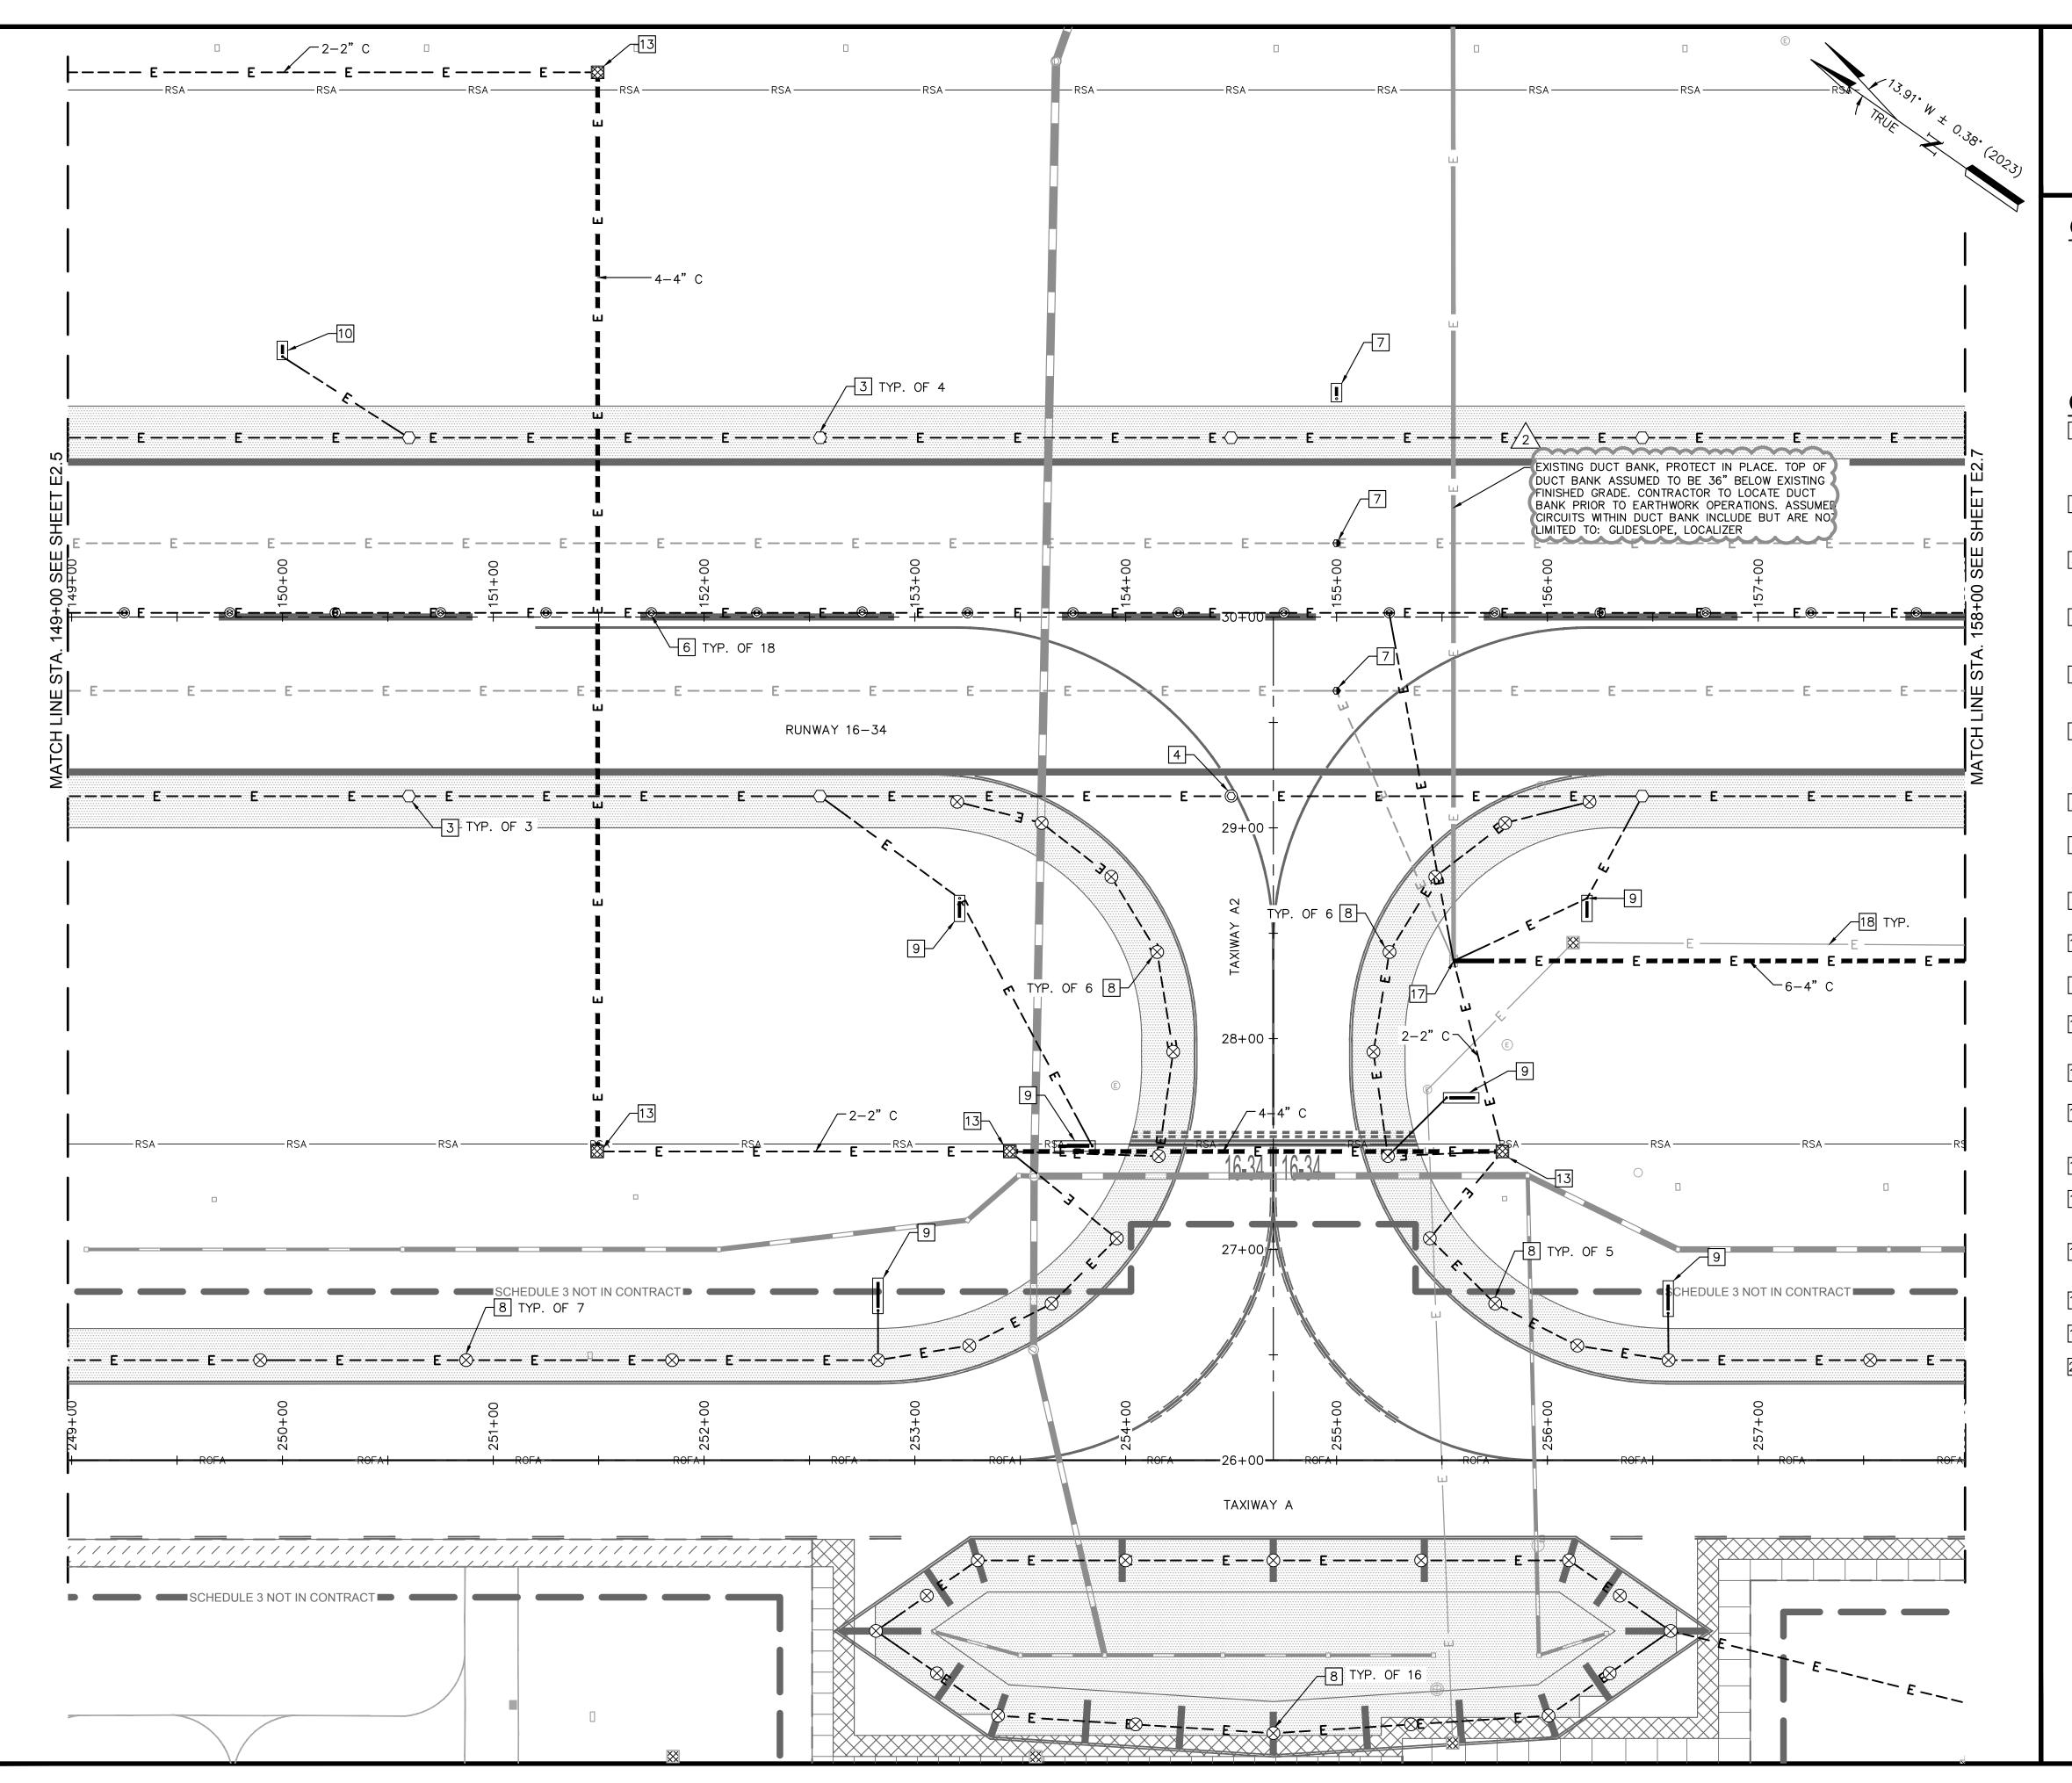
TE AIRPC
RT CORPORA
RHODE ISLA
SONSTRU OWN, QUONSET & RHODE ISLAND A NORTH KINGST RUNWAY 16-34

02/09/2023 **DESIGNED BY** DRAWN BY CHECKED BY PROJECT NO. 112214003 FILE NO. ED01-112214003 AIP NO. 0-00-0000-000-0000 SHEET TITLE

ELECTRICAL DEMOLITION PLAN HOMERUN DUCTBANK REALIGNMENT

SCHEDULE 1 & 2

SHEET NO. E1.20



GENERAL NOTES

- 1. REFER TO PROJECT LAYOUT PLANS, SHEETS C1.9
- THROUGH C1.12.

 2. ALL PROPOSED CONDUIT IN THE PLANS ASSUMED TO BE 1-2" SCH. 40 PVC UNLESS OTHERWISE NOTED. ALL CONDUITS PASSING UNDER FULL STRENGTH PAVEMENT
- 3. THE LIMITS OF SCHEDULE 3 ARE SHOWN HEREIN, HOWEVER, SCHEDULE 3 IS NOT PART OF THIS CONTRACT. REFER TO SCHEDULE 1 AND SCHEDULE 2 PLANS AS DIRECTED.

CONSTRUCTION NOTES

TO BE CONCRETE ENCASED.

- 1 INSTALL NEW 5-LIGHT FRANGIBLE BAR FOR NEW FAA MALSR INCLUDING LIGHT FIXTURES, ISOLATION TRANSFORMERS, JUNCTION CANS, AND CONCRETE BASE. SEE E7 MALSR PLAN SERIES.
- INSTALL NEW MALSR LIGHT FIXTURES WITH ISOLATION TRANSFORMERS ON NEW L-867 BASE CANS FOR FAA MALSR THRESHOLD BAR. SEE E7 MALSR PLAN SERIES.
- INSTALL NEW L-862(L) LED ELEVATED RUNWAY EDGE LIGHT AND CABLING ON NEW L-867 BASE CAN WITH NEW ISOLATION TRANSFORMER. SEE DETAIL 1 SHEET E5.5.
- INSTALL NEW L-850C(L) LED IN-PAVEMENT RUNWAY EDGE LIGHT AND CABLING ON NEW L-868 BASE CAN WITH NEW ISOLATION TRANSFORMER. SEE DETAIL 2 SHEET E5.5.
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 CENTERLINE LIGHT AND CABLING ON NEW L-868 BASE CAN
 WITH NEW ISOLATION TRANSFORMER. SEE DETAIL 2 SHEET
 E5.5
- ZONE LIGHT FIXTURE/SIGN. SEE E4 SERIES FOR DETAIL.
- INSTALL NEW L-861T(L) LED ELEVATED TAXIWAY EDGE LIGHT AND CABLING ON NEW L-867 BASE CAN WITH NEW ISOLATION TRANSFORMER. SEE DETAIL 1 SHEET E5.5.
- 9 INSTALL NEW L-858 LED AIRFIELD GUIDANCE SIGN ON NEW CONCRETE FOUNDATION. SEE DETAIL 1 SHEET E5.4.
- INSTALL NEW L-858 LED RUNWAY DISTANCE REMAINING SIGN ON NEW CONCRETE FOUNDATION. SEE DETAIL 1 SHEET E5.6.
- INSTALL NEW L-880 4-BOX LED PAPI ON NEW CONCRETE FOUNDATION. SEE DETAILS SHEETS E5.9 AND E5.10.
- 12 INSTALL NEW L-807 SUPPLEMENTAL WIND CONE. SEE DETAIL 2 SHEET E5.6.
- INSTALL NEW AIRCRAFT LOAD RATED CONCRETE HANDHOLE.
- 13 SEE DETAIL 1 SHEET E5.2.
- INSTALL SALVAGED RUNWAY 5-23 EDGE LIGHT FIXTURE AND CABLING WITH SALVAGED ISOLATION TRANSFORMER ON EXISTING BASE CAN.
- INSTALL BLANK STEEL COVER ON EXISTING BASE CAN.
- INSTALL NEW L-861T QUARTZ ELEVATED TAXIWAY EDGE LIGHT AND CABLING ON NEW L-867 BASE CAN WITH NEW ISOLATION TRANSFORMER. SEE DETAIL 1 SHEET E5.5.
- EXISTING MANHOLE/HANDHOLE/JUNCTION CAN. PROTECT IN PLACE
- EXISTING ELECTRICAL CONDUIT/DUCT BANK. PROTECT IN PLACE.
- 9 INSTALL NEW L-867B BASE CAN WITH BLANK STEEL COVER.
- SAWCUT EXISTING ASPHALT SHOULDER FOR NEW 1-2" SCH. 40 PVC DIRECT BURIED CONDUIT TRENCH. FILL TO SURFACE WITH CLSM.





QUONSET STATE AIRPORT 150 AIRPORT STREET NORTH KINGSTOWN, RI 02852

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VANASSE HANGEN BRUSTLIN, INC.

1 CEDAR STREET

JOSEPH BRADSHAW

No 14552
REGISTERED
PROFESSIONAL ENGINEER
ELECTRICAL

CKD	aar			
DATE	03/07/23			
DESCRIPTION	ADDENDUM NO. 2			
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QUONSET STATE AIRPORT
RHODE ISLAND AIRPORT CORPORATION
NORTH KINGSTOWN, RHODE ISLAND
RUNWAY 16-34 RECONSTRUCTIC

 DATE
 02/09/2023

 DESIGNED BY
 JDB

 DRAWN BY
 JPT

 CHECKED BY
 JDB

 PROJECT NO.
 112214003

 FILE NO.
 EL01-112214003

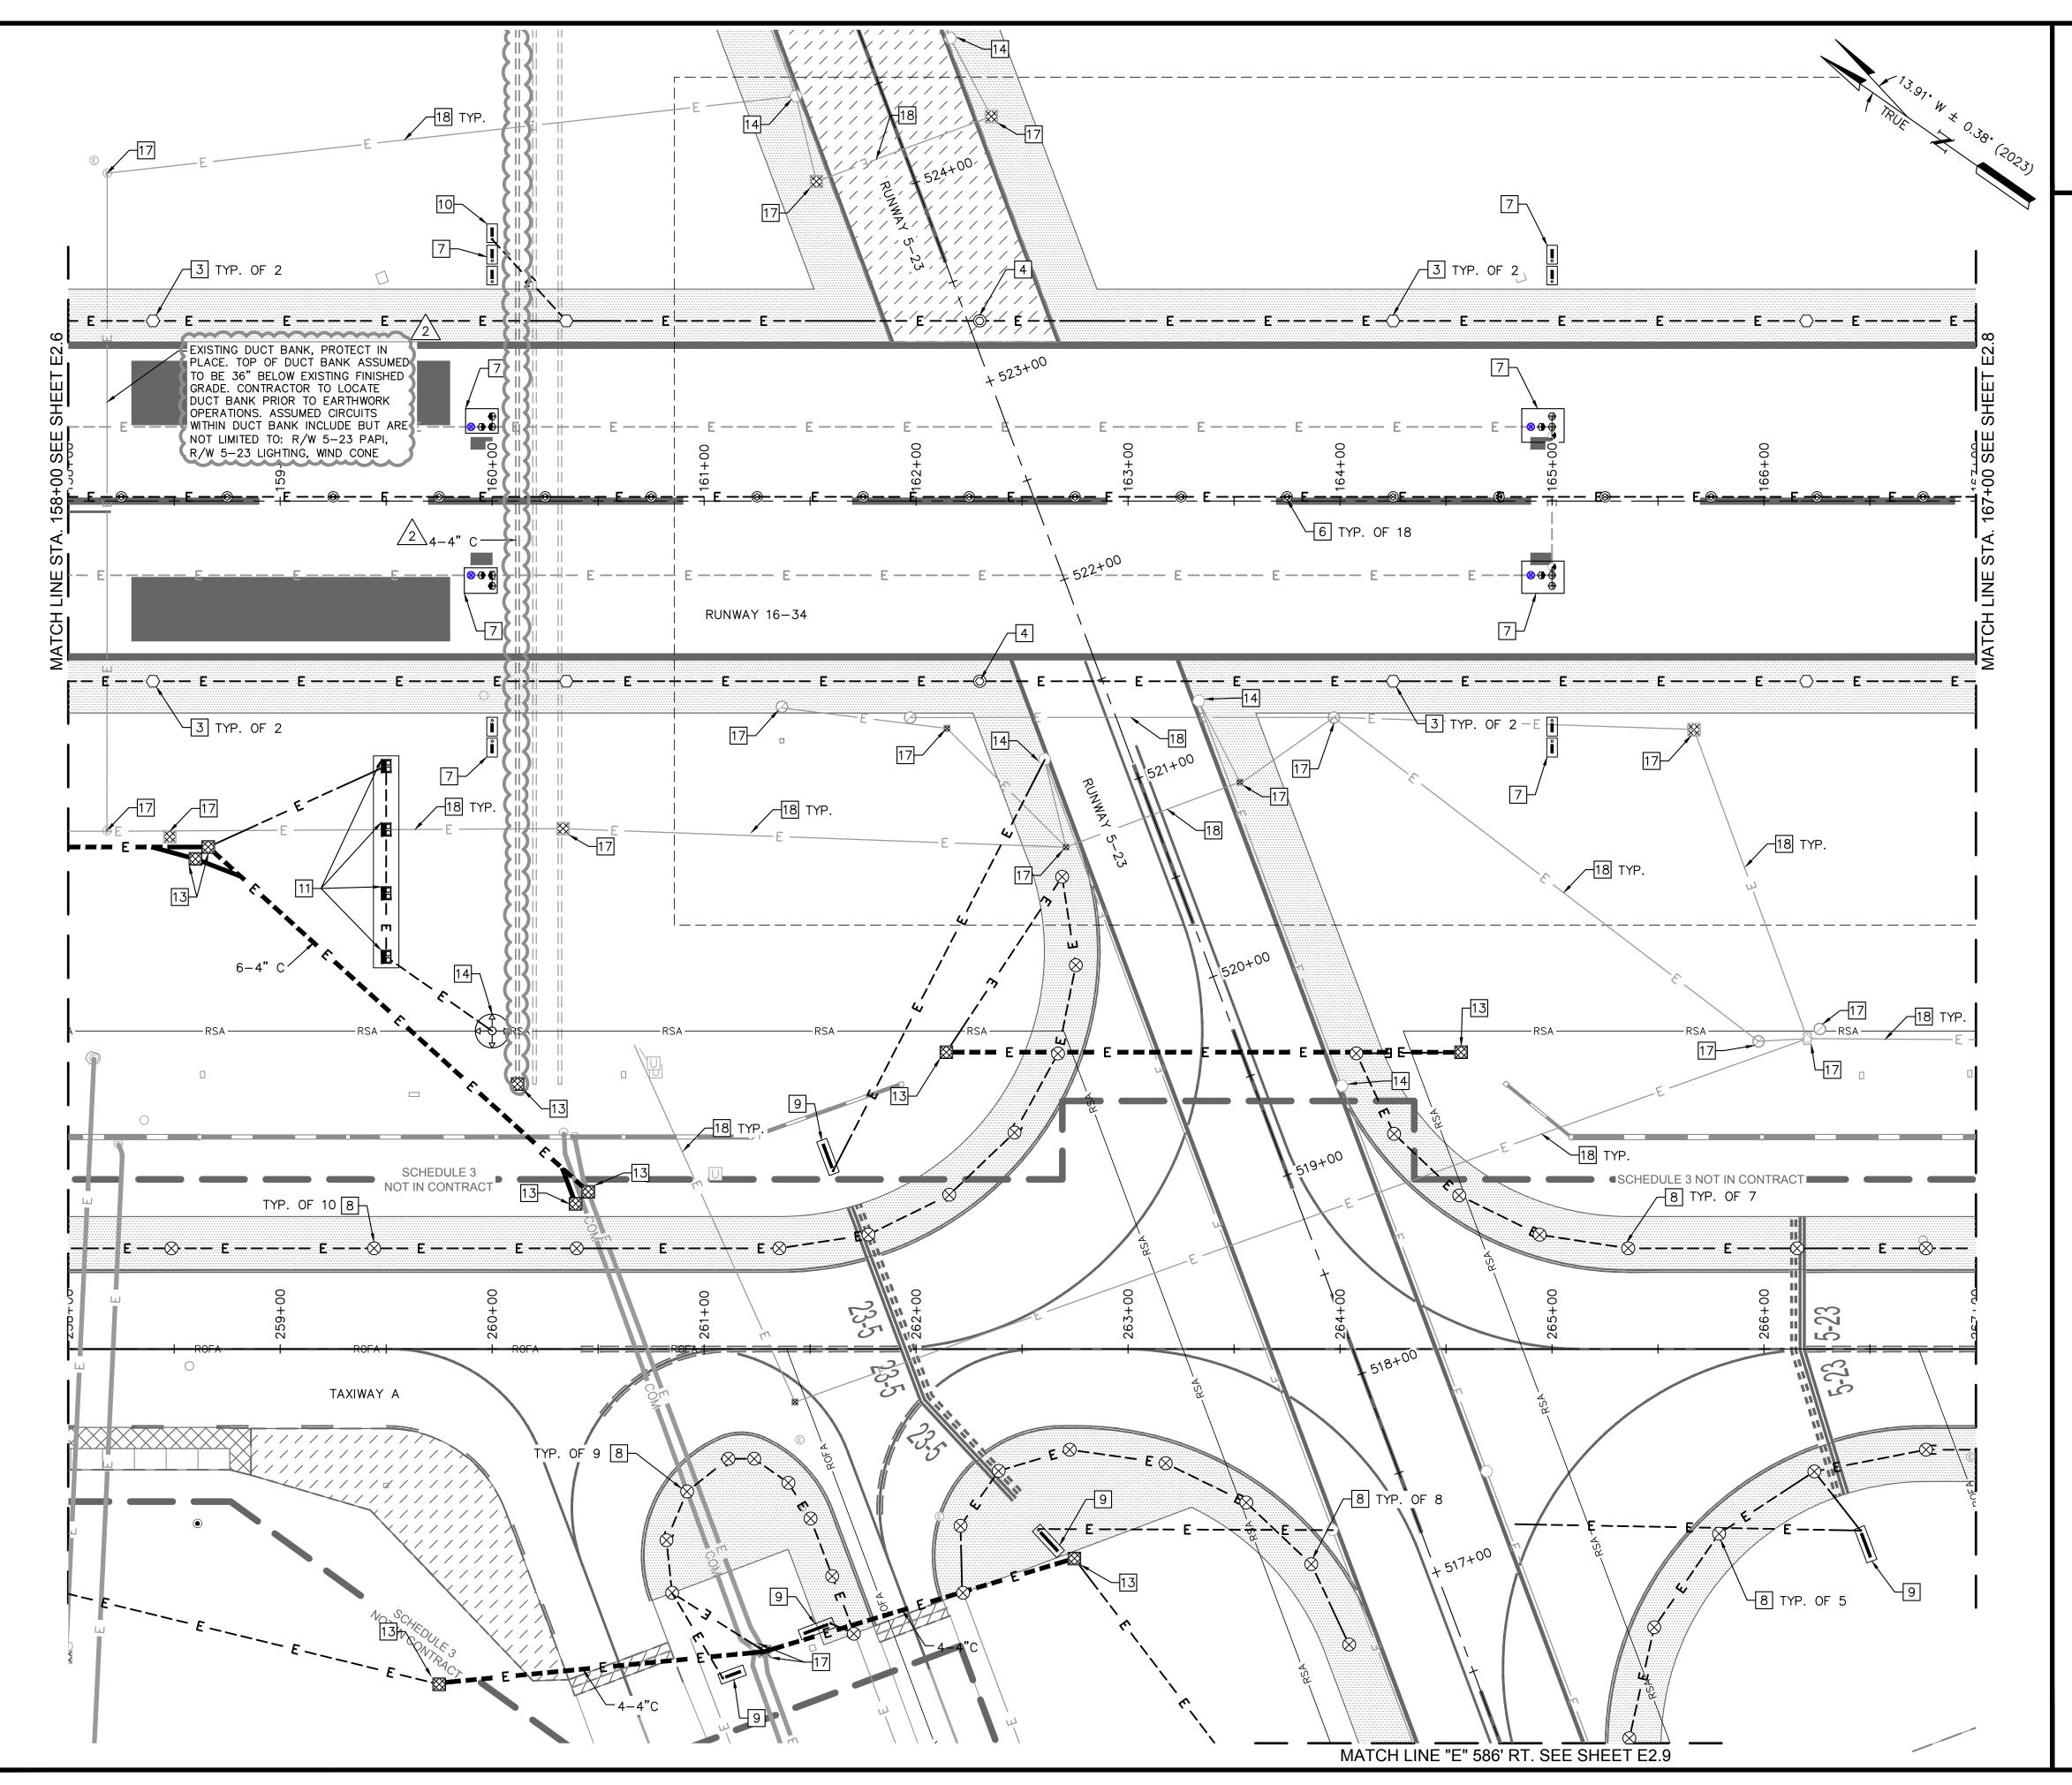
 AIP NO.0-00-000-0000-0000

SHEET TITLE
LIGHTING AND
SIGNAGE PLAN

BID SCHEDULE 3 STA. 149+00 TO

STA. 158+00 SHEET NO.

E2.6
221 OF 286



GENERAL NOTES

- 1. REFER TO PROJECT LAYOUT PLANS, SHEETS C1.9 THROUGH C1.12.
- 2. ALL PROPOSED CONDUIT IN THE PLANS ASSUMED TO BE 1-2" SCH. 40 PVC UNLESS OTHERWISE NOTED. ALL CONDUITS PASSING UNDER FULL STRENGTH PAVEMENT TO BE CONCRETE ENCASED.
- 3. THE LIMITS OF SCHEDULE 3 ARE SHOWN HEREIN, HOWEVER, SCHEDULE 3 IS NOT PART OF THIS CONTRACT. REFER TO SCHEDULE 1 AND SCHEDULE 2 PLANS AS DIRECTED.

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- 12 INSTALL NEW L-807 SUPPLEMENTAL WIND CONE. SEE DETAIL 2 SHEET E5.6.
- INSTALL NEW AIRCRAFT LOAD RATED CONCRETE HANDHOLE.
- SEE DETAIL 1 SHEET E5.2.
- INSTALL SALVAGED RUNWAY 5-23 EDGE LIGHT FIXTURE AND CABLING WITH SALVAGED ISOLATION TRANSFORMER ON EXISTING BASE CAN.
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- SAWCUT EXISTING ASPHALT SHOULDER FOR NEW 1-2" SCH. 40 PVC DIRECT BURIED CONDUIT TRENCH. FILL TO SURFACE WITH CLSM.





- QUONSET STATE AIRPORT 150 AIRPORT STREET NORTH KINGSTOWN, RI 02852

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VANASSE HANGEN BRUSTLIN, INC 1 CEDAR STREET

JOSEPH BRADSHAW

No 14552

REGISTERED

PROFESSIONAL ENGINEER

ELECTRICAL

СКБ	JDB			
DATE	03/07/23 JDB			
DESCRIPTION	ADDENDUM NO. 2			
ВУ	JPT			
REV BY	2			

QUONSET STATE AIRPORT
RHODE ISLAND AIRPORT CORPORATION
NORTH KINGSTOWN, RHODE ISLAND
RUNWAY 16-34 RECONSTRUCTIC

DATE 02/09/2023

DESIGNED BY JDB

DRAWN BY JPT

CHECKED BY JDB

PROJECT NO. 112214003

FILE NO. EL01-112214003

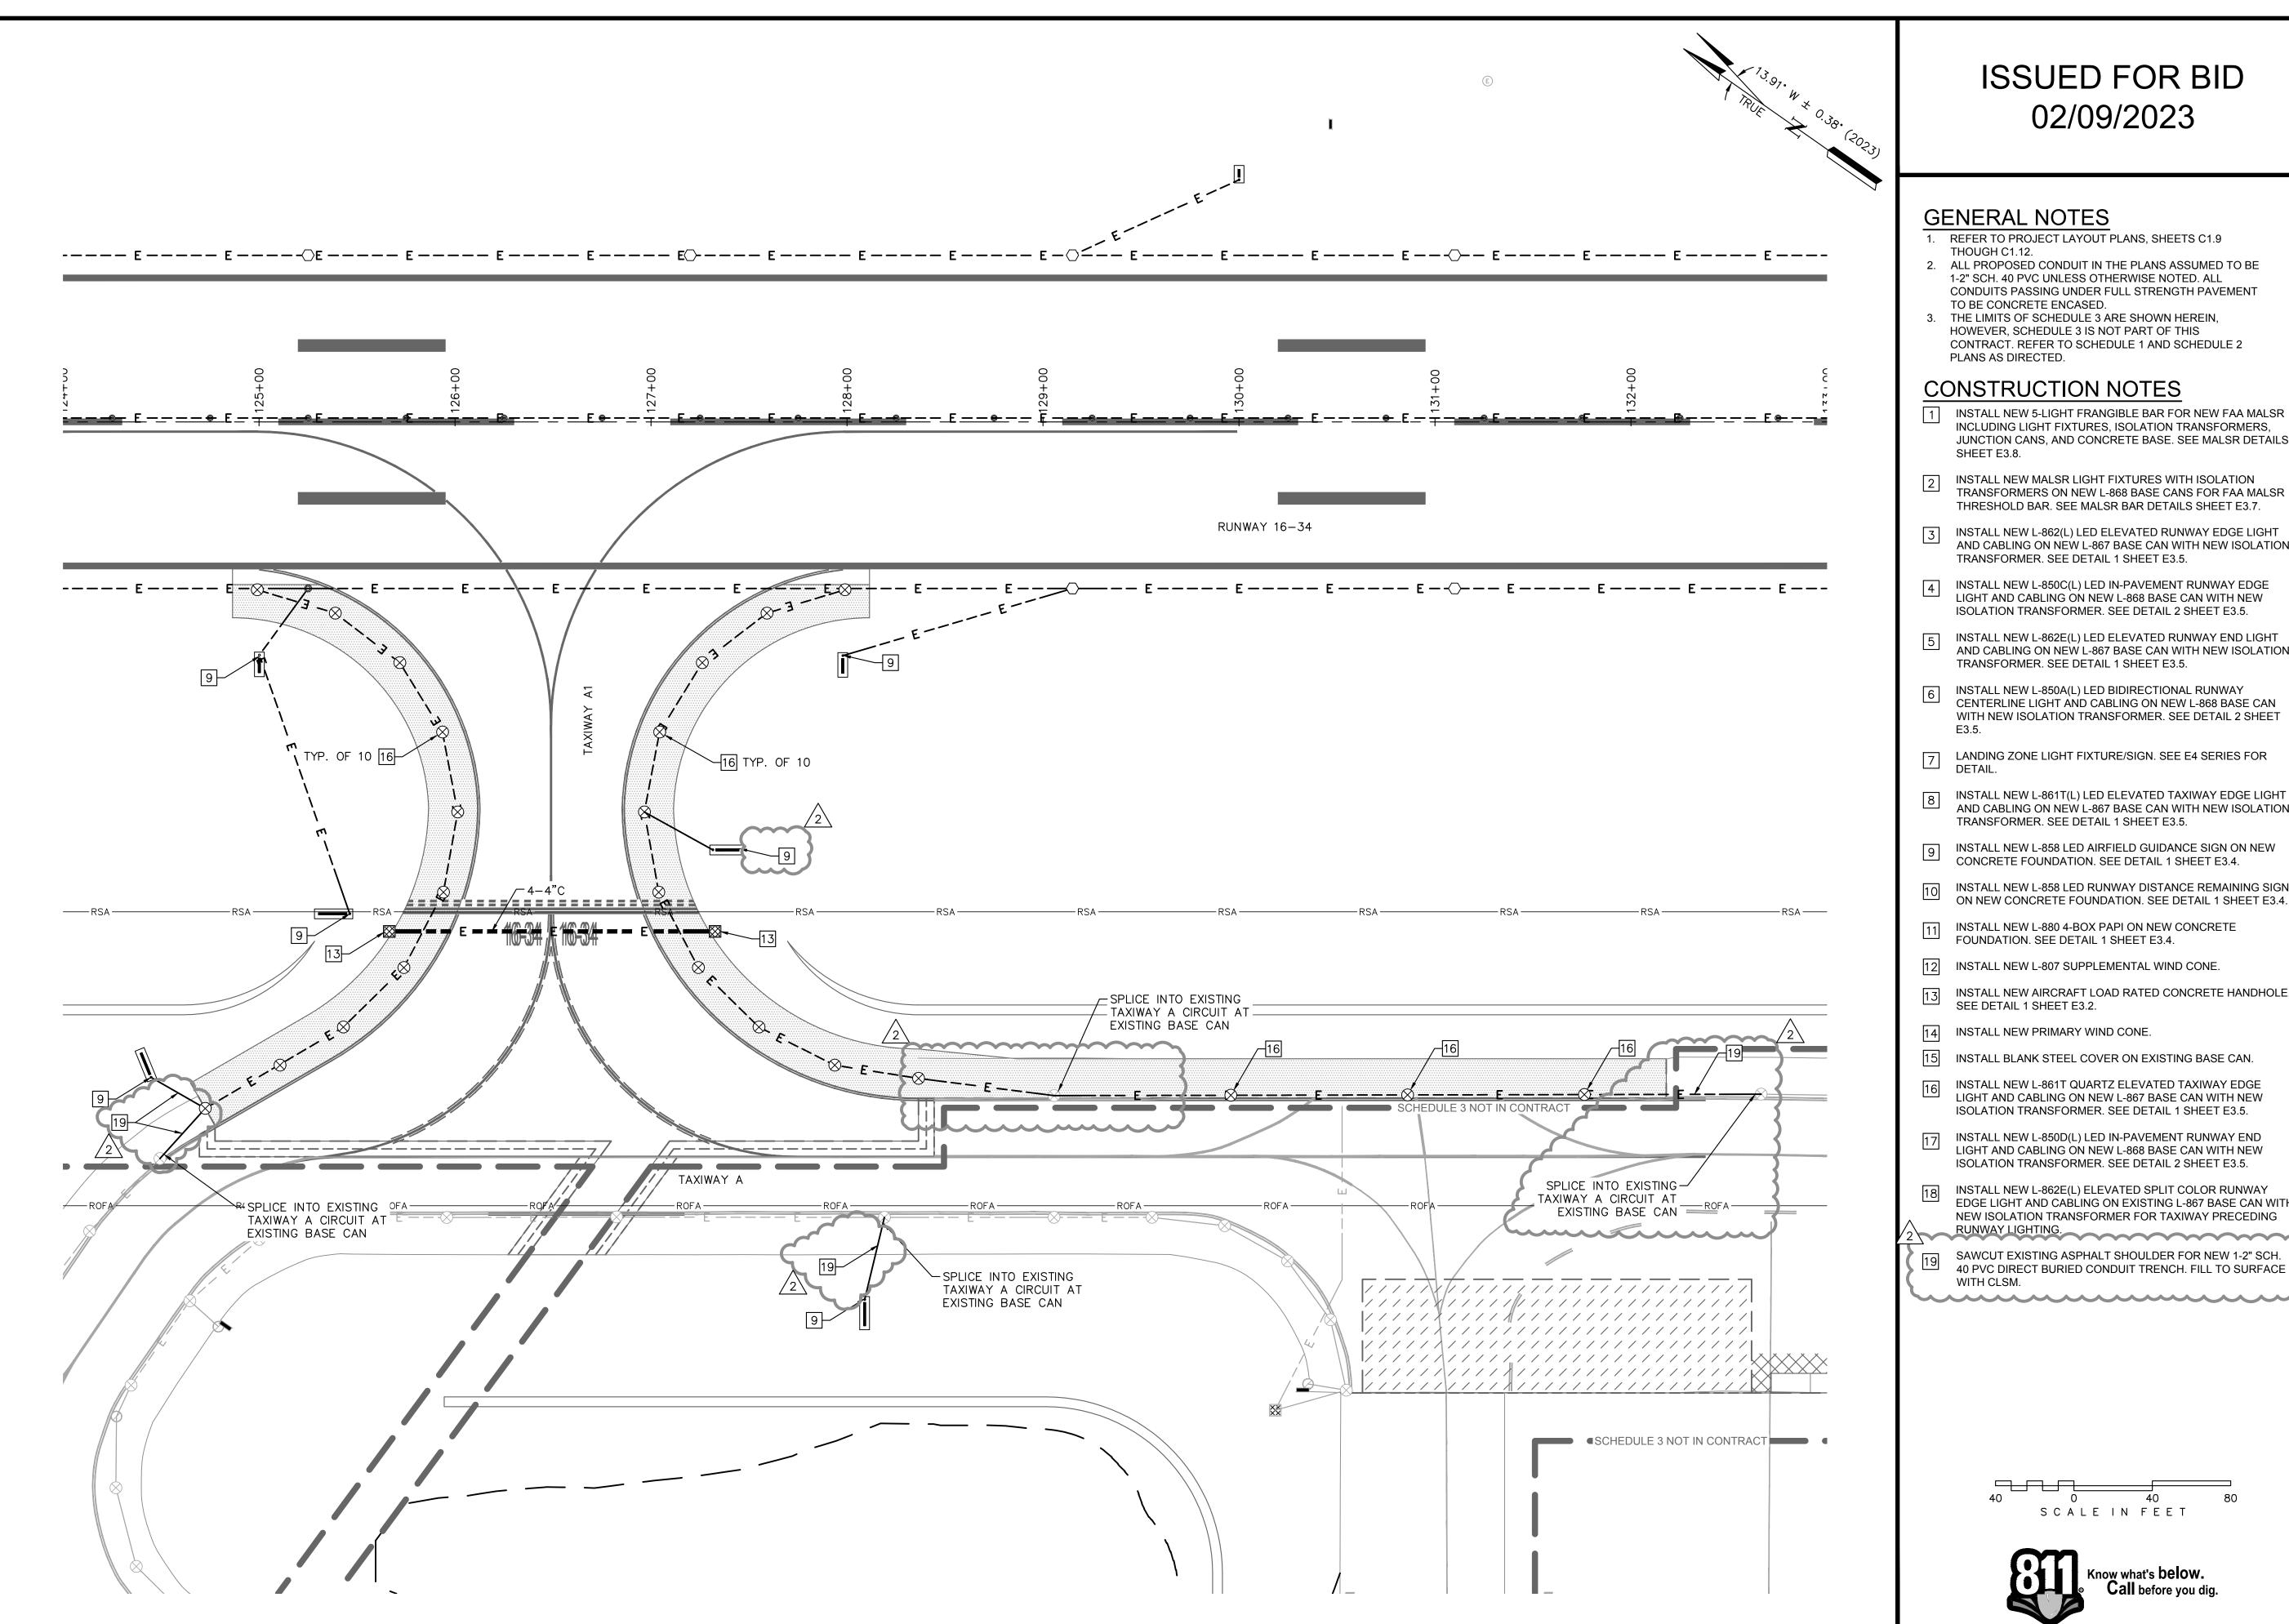
AIP NO.0-00-0000-0000-0000

SHEET TITLE
LIGHTING AND
SIGNAGE PLAN

BID SCHEDULE 3 STA. 158+00 TO STA. 167+00

STA. SHEET NO.

E2.7 222 OF 286



GENERAL NOTES

- REFER TO PROJECT LAYOUT PLANS, SHEETS C1.9
- THOUGH C1.12. 2. ALL PROPOSED CONDUIT IN THE PLANS ASSUMED TO BE 1-2" SCH. 40 PVC UNLESS OTHERWISE NOTED. ALL CONDUITS PASSING UNDER FULL STRENGTH PAVEMENT
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CONSTRUCTION NOTES

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- INSTALL NEW MALSR LIGHT FIXTURES WITH ISOLATION TRANSFORMERS ON NEW L-868 BASE CANS FOR FAA MALSR THRESHOLD BAR, SEE MALSR BAR DETAILS SHEET E3.7.
- INSTALL NEW L-862(L) LED ELEVATED RUNWAY EDGE LIGHT AND CABLING ON NEW L-867 BASE CAN WITH NEW ISOLATION TRANSFORMER. SEE DETAIL 1 SHEET E3.5.
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- INSTALL NEW L-858 LED RUNWAY DISTANCE REMAINING SIGN ON NEW CONCRETE FOUNDATION. SEE DETAIL 1 SHEET E3.4.
- 11 INSTALL NEW L-880 4-BOX PAPI ON NEW CONCRETE FOUNDATION. SEE DETAIL 1 SHEET E3.4.
- INSTALL NEW L-807 SUPPLEMENTAL WIND CONE.
- INSTALL NEW AIRCRAFT LOAD RATED CONCRETE HANDHOLE.
- SEE DETAIL 1 SHEET E3.2.
- INSTALL NEW PRIMARY WIND CONE.
- INSTALL NEW L-861T QUARTZ ELEVATED TAXIWAY EDGE LIGHT AND CABLING ON NEW L-867 BASE CAN WITH NEW ISOLATION TRANSFORMER. SEE DETAIL 1 SHEET E3.5.

INSTALL BLANK STEEL COVER ON EXISTING BASE CAN.

- INSTALL NEW L-850D(L) LED IN-PAVEMENT RUNWAY END LIGHT AND CABLING ON NEW L-868 BASE CAN WITH NEW ISOLATION TRANSFORMER. SEE DETAIL 2 SHEET E3.5.
- INSTALL NEW L-862E(L) ELEVATED SPLIT COLOR RUNWAY EDGE LIGHT AND CABLING ON EXISTING L-867 BASE CAN WITH NEW ISOLATION TRANSFORMER FOR TAXIWAY PRECEDING 2 RUNWAY LIGHTING.
- SAWCUT EXISTING ASPHALT SHOULDER FOR NEW 1-2" SCH. 40 PVC DIRECT BURIED CONDUIT TRENCH. FILL TO SURFACE WITH CLSM.





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> 404 WYMAN STREET SUITE 385

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VANASSE HANGEN BRUSTLIN, INC. 1 CEDAR STREET

SUITE 400

PROVIDENCE, RI 02903 JOSEPH BRADSHAW

REGISTERED PROFESSIONAL ENGINEER ELECTRICAL

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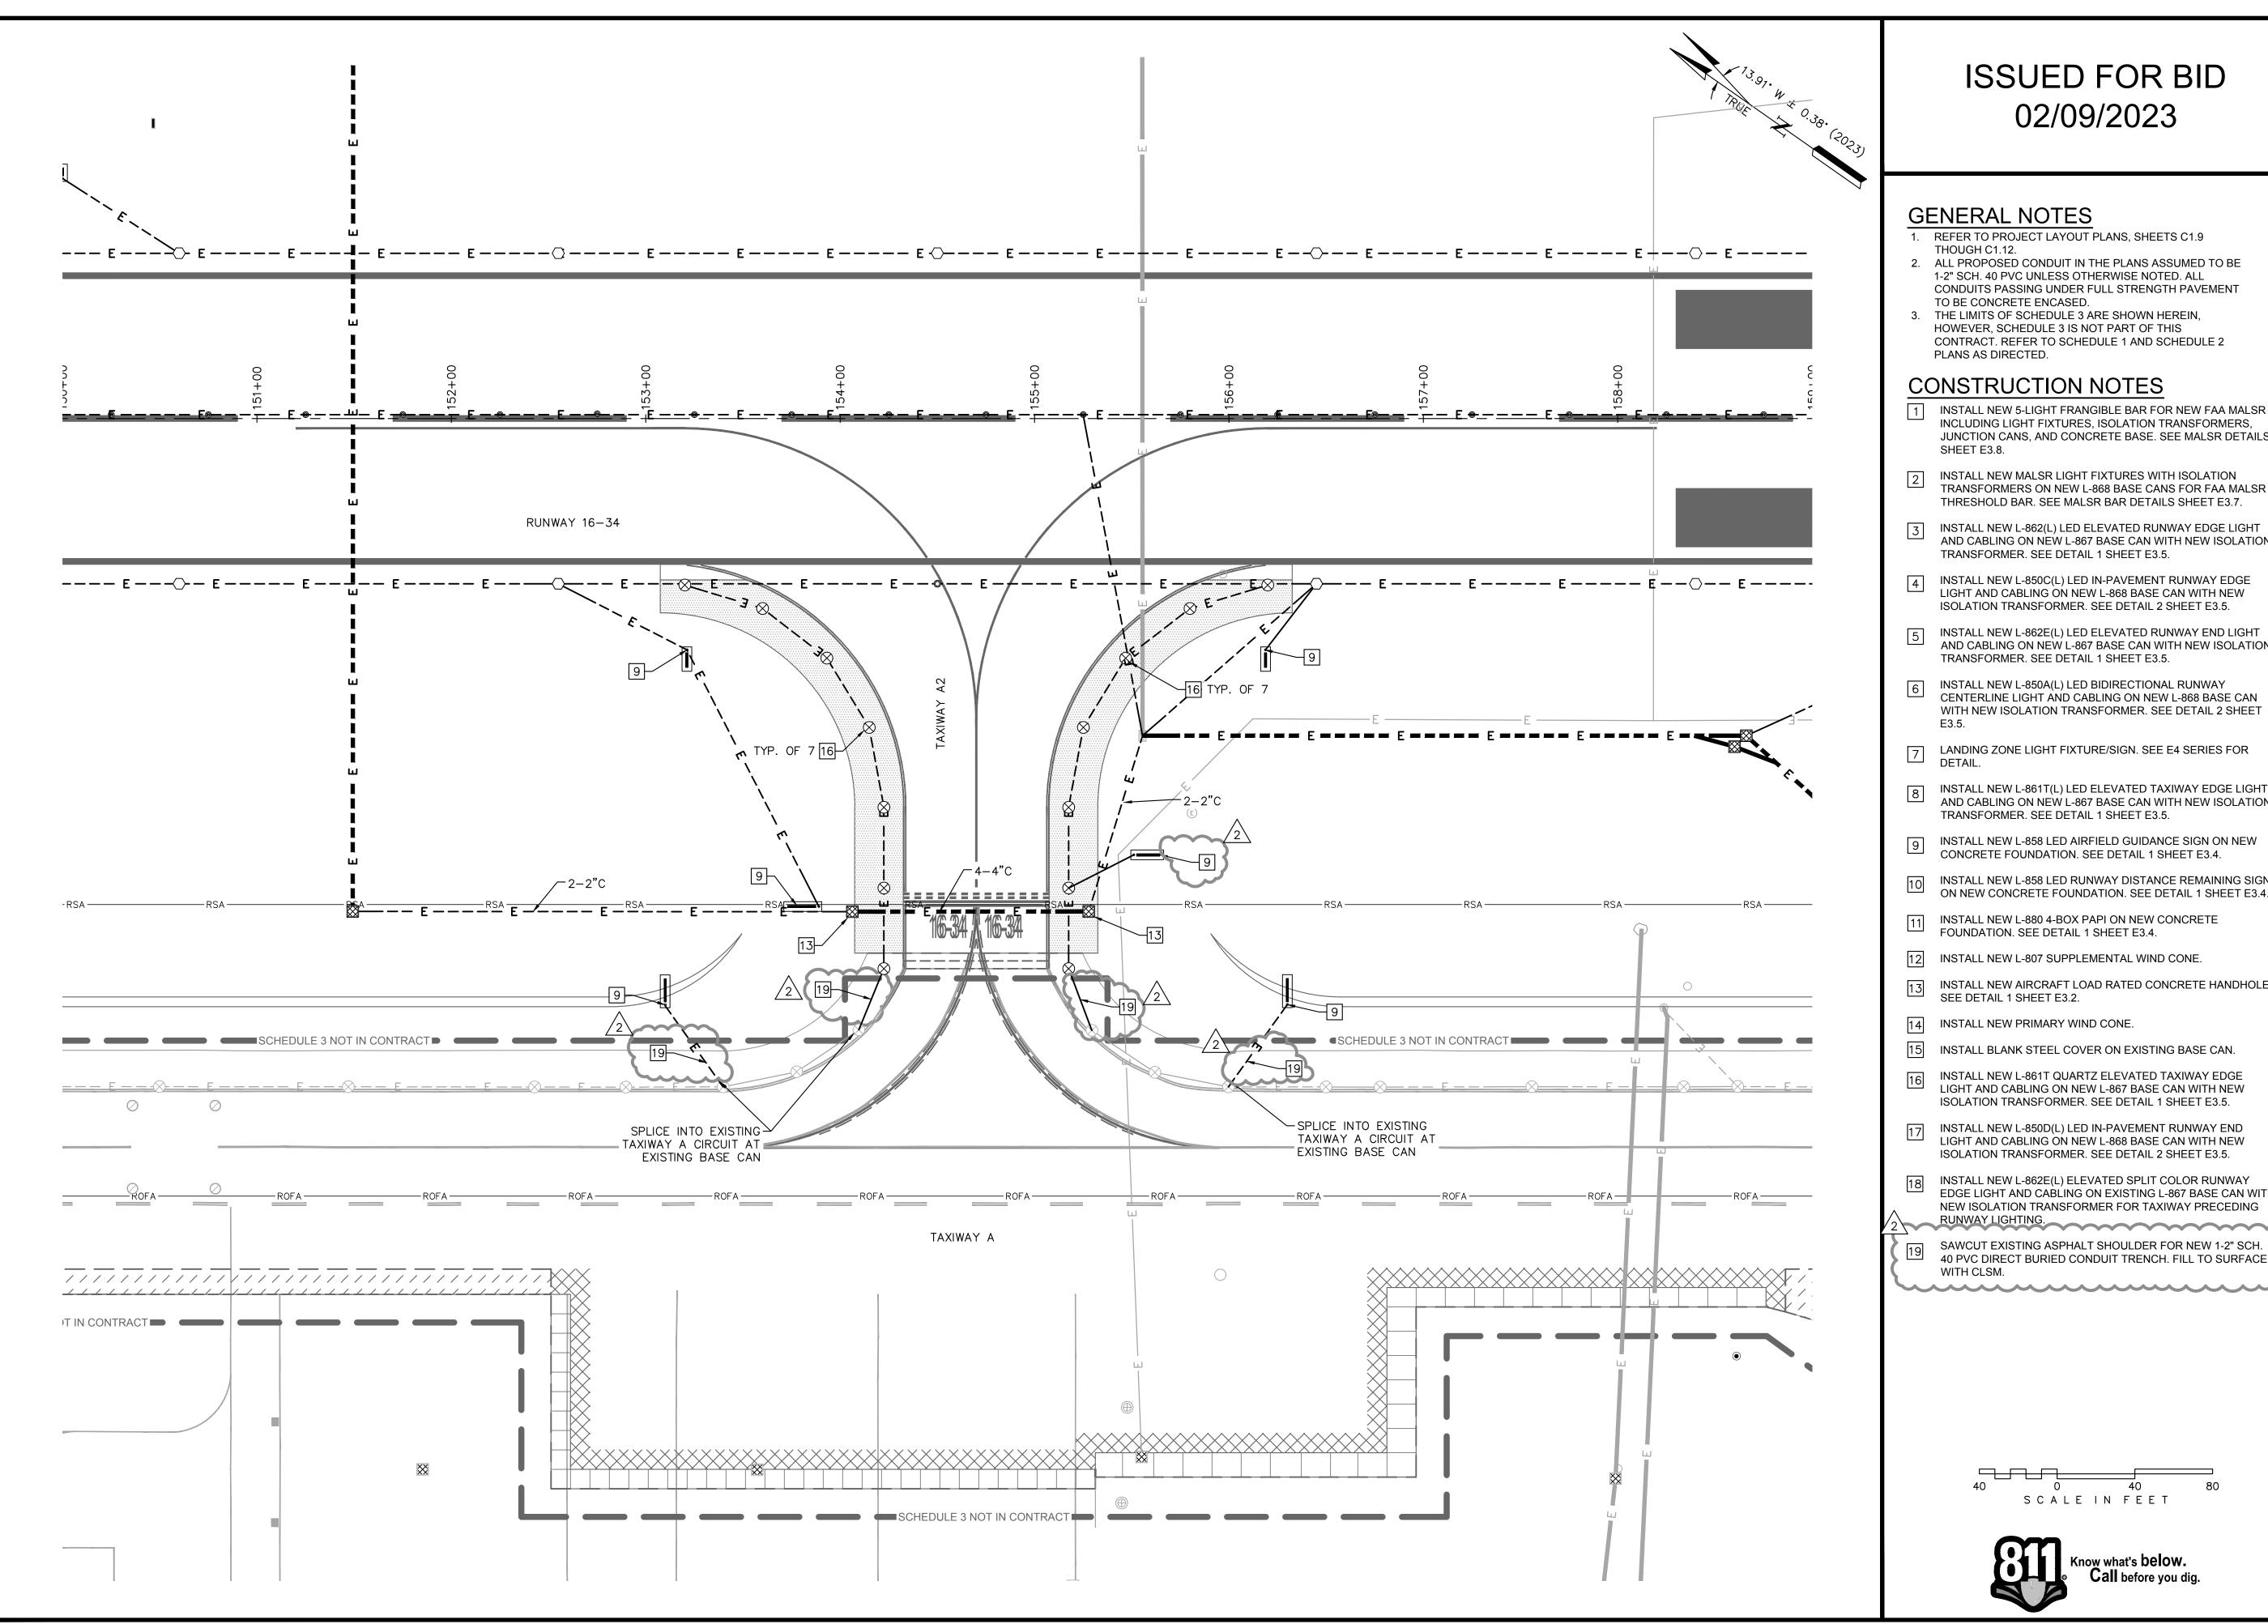
02/09/2023 **DESIGNED BY** DRAWN BY CHECKED BY PROJECT NO. 112214003 FILE NO. EL03-112214003 AIP NO. 0-00-0000-000-0000

SHEET TITLE LIGHTING AND SIGNAGE PLAN

TAXIWAY A1 BID SCHEDULES 1 AND 2 STA. 124+00 TO

STA. 133+00 SHEET NO.

> E2.12 227 OF 286



GENERAL NOTES

- REFER TO PROJECT LAYOUT PLANS, SHEETS C1.9 THOUGH C1.12.
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- 11 INSTALL NEW L-880 4-BOX PAPI ON NEW CONCRETE FOUNDATION. SEE DETAIL 1 SHEET E3.4.
- INSTALL NEW L-807 SUPPLEMENTAL WIND CONE.
- INSTALL NEW AIRCRAFT LOAD RATED CONCRETE HANDHOLE.

INSTALL BLANK STEEL COVER ON EXISTING BASE CAN.

- SEE DETAIL 1 SHEET E3.2.
- 14 INSTALL NEW PRIMARY WIND CONE.
- INSTALL NEW L-861T QUARTZ ELEVATED TAXIWAY EDGE LIGHT AND CABLING ON NEW L-867 BASE CAN WITH NEW ISOLATION TRANSFORMER. SEE DETAIL 1 SHEET E3.5.
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- SAWCUT EXISTING ASPHALT SHOULDER FOR NEW 1-2" SCH. 40 PVC DIRECT BURIED CONDUIT TRENCH. FILL TO SURFACE WITH CLSM.





QUONSET STATE AIRPORT 150 AIRPORT STREET NORTH KINGSTOWN, RI 02852

PHONE: (401) 691-2000

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PHONE: (781) 328-0676

VANASSE HANGEN BRUSTLIN, INC.

1 CEDAR STREET SUITE 400

PROVIDENCE, RI 02903 JOSEPH BRADSHAW

REGISTERED PROFESSIONAL ENGINEER ELECTRICAL

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DATE	03/07/23					
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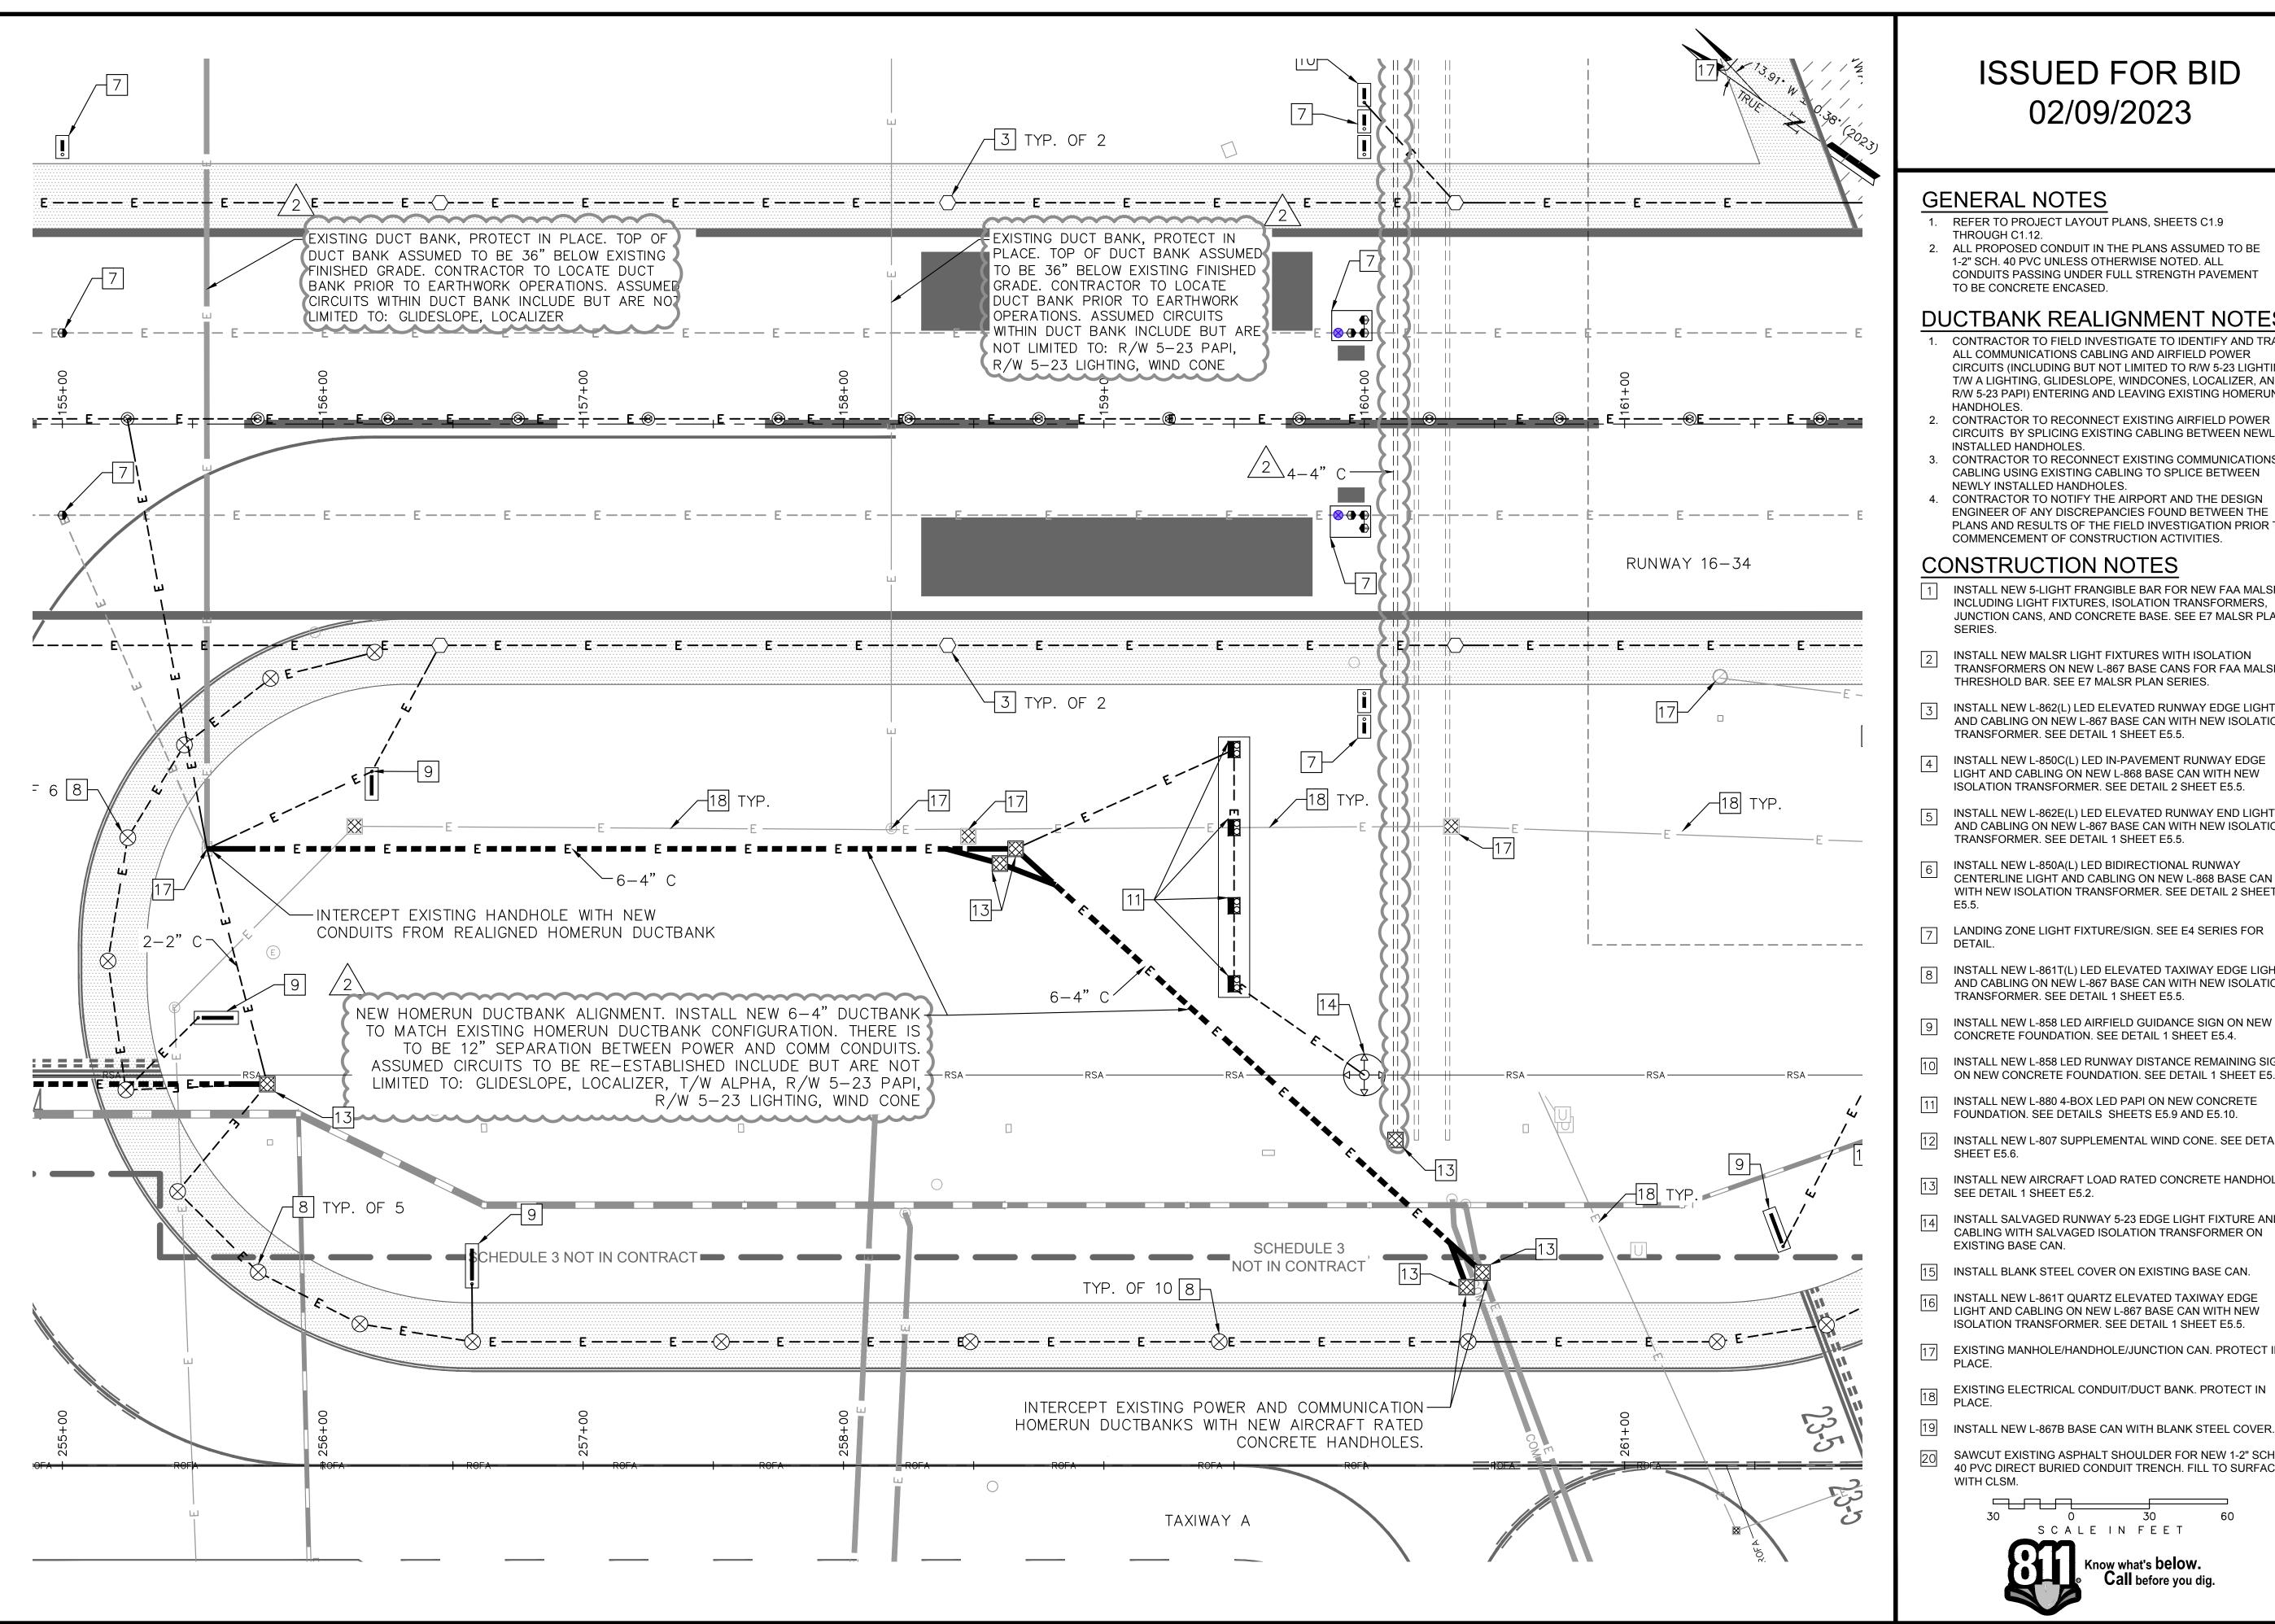
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02/09/2023 **DESIGNED BY** DRAWN BY CHECKED BY PROJECT NO. 112214003 FILE NO. EL03-112214003 AIP NO. 0-00-0000-000-0000 SHEET TITLE LIGHTING AND

SIGNAGE PLAN **TAXIWAY A2**

BID SCHEDULES 1 AND 2 STA. 150+00 TO STA. 159+00

SHEET NO. E2.13



GENERAL NOTES


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DUCTBANK REALIGNMENT NOTES

- CONTRACTOR TO FIELD INVESTIGATE TO IDENTIFY AND TRACE ALL COMMUNICATIONS CABLING AND AIRFIELD POWER CIRCUITS (INCLUDING BUT NOT LIMITED TO R/W 5-23 LIGHTING, T/W A LIGHTING, GLIDESLOPE, WINDCONES, LOCALIZER, AND R/W 5-23 PAPI) ENTERING AND LEAVING EXISTING HOMERUN HANDHOLES.
- CIRCUITS BY SPLICING EXISTING CABLING BETWEEN NEWLY INSTALLED HANDHOLES. 3. CONTRACTOR TO RECONNECT EXISTING COMMUNICATIONS
- CABLING USING EXISTING CABLING TO SPLICE BETWEEN NEWLY INSTALLED HANDHOLES.
- 4. CONTRACTOR TO NOTIFY THE AIRPORT AND THE DESIGN ENGINEER OF ANY DISCREPANCIES FOUND BETWEEN THE PLANS AND RESULTS OF THE FIELD INVESTIGATION PRIOR TO COMMENCEMENT OF CONSTRUCTION ACTIVITIES.

CONSTRUCTION NOTES

- INSTALL NEW 5-LIGHT FRANGIBLE BAR FOR NEW FAA MALSR INCLUDING LIGHT FIXTURES, ISOLATION TRANSFORMERS, JUNCTION CANS, AND CONCRETE BASE. SEE E7 MALSR PLAN
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- EXISTING ELECTRICAL CONDUIT/DUCT BANK. PROTECT IN
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SUITE 400 PROVIDENCE, RI 02903

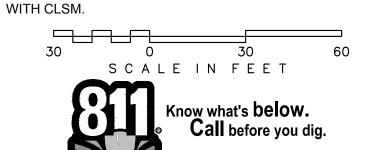JOSEPH BRADSHAW REGISTERED PROFESSIONAL ENGINEER ELECTRICAL

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CKD	JDB				
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E AIRPOF CORPORAT HODE ISLAN SLANG KING 16-3 QUONS RHODE ISL NORTH K

02/09/2023 DATE **DESIGNED BY** DRAWN BY CHECKED BY PROJECT NO. 112214003 FILE NO. EL01-112214003 AIP NO. 0-00-0000-000-0000 SHEET TITLE

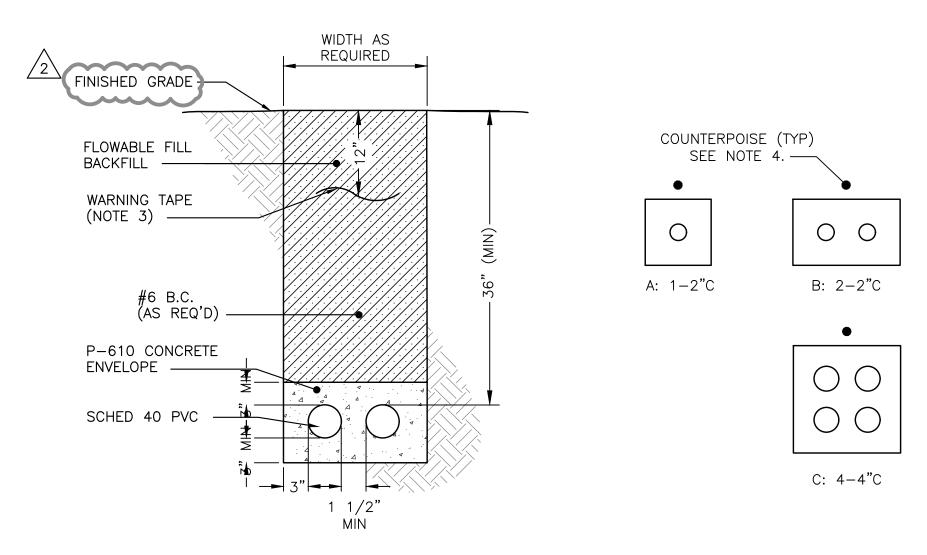
ELECTRICAL LAYOUT PLAN HOMERUN DUCTBANK REALIGNMENT

SCHEDULE 1 & 2 SHEET NO.


> E2.17 232 OF 286



- 1. SEE PLANS FOR REQUIRED DUCT SECTIONS. ALL OF THE SECTIONS SHOWN ON THIS DRAWING MAY NOT BE USED ON
- 2. PROVIDE PULL WIRES IN ALL (NEW) UNUSED CONDUITS. PLUG CONDUIT ENDS IN HANDHOLES OR MANHOLES.
- 3. WARNING TAPE REQUIRED IN ALL AREAS. WHERE IN CONFLICT WITH THE COUNTERPOISE, INSTALL THE TAPE DIRECTLY ABOVE THE COUNTERPOISE.
- 4. U.O.N. INSTALL A #6 BARE COPPER (BC) COUNTERPOISE CONDUCTOR WITH EACH DUCT ASSEMBLY AND EACH SINGLE CONDUIT. EXOTHERMICALLY WELD TO GROUND RODS PER SPECS. DO NOT CONNECT TO BASES OR GROUNDING SYSTEM. COUNTERPOISE CONDUCTOR TO BE PULLED EXTERIOR TO DIRECTIONAL BORE.
- 5. BACKFILL-D.B. APPLICATION: FILL FROM WARNING TAPE TO BOTTOM OF PAVEMENT WITH P-152. NATIVE BACKFILL USED
- 6. BACKFILL-C.E. APPLICATION: FILL ABOVE CONCRETE ENVELOPE TO BOTTOM OF P-209.
- 7. REFER TO SPECIFICATION ITEM L-110 FOR CONDUIT/DUCT SPACER SYSTEM.



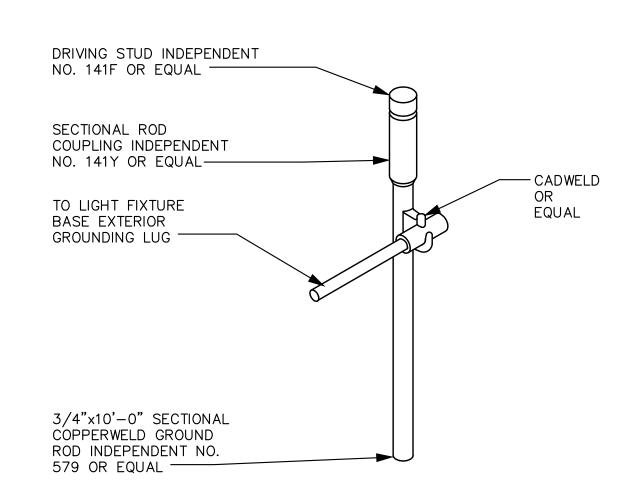
TRENCH SECTION - CONCRETE ENCASED SCALE: NTS



BASE COUNTERPOISE

SCALE: NTS

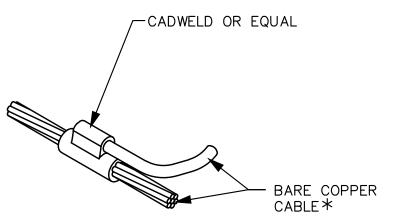TRENCH SECTION — DIRECT BURY SCALE: NTS



* BARE COPPER CABLE -#4/0 FOR FAA FACILITIES, #1/0 FOR FAA DUCTS, #6 SOLID FOR AIRFIELD

-NATIVE MATERIAL

EXISTING ASPHALT

(AS REQ'D)-

PAVEMENT—

BACKFILL WITH CLSM

(NOTE 3)

WARNING TAPE

SCHED 40 PVC

IN TWO POURS -

COUNTERPOISE (TYP)

SEE NOTE 4. -

SCALE: NTS

WIDTH AS

REQUIRED

A: 1-2"C

WIDTH AS

REQUIRED

TRENCH SECTION — SAWCUT IN EXISTING PAVEMENT

ISSUED FOR BID 02/09/2023

VERIFY PAVEMENT

SECTION

-2" OR 4" HDPE

-DRIVING STUD INDEPENDENT

-SECTIONAL ROD COUPLING

INDEPENDENT NO. 141Y OR

NO. 141F OR EQUAL

-18" RADIUS, MINIMUM

- BARE COPPER CABLE*

EQUAL

(TYP)

CONDUITS

TYPICAL SECTION - DIRECTIONAL BORE

COUNTERPOISE GROUND ROD

(E) SUBGRADE

#6 B.C. (OR AS REQ'D) —

DRILLING FLUID -

SCALE: NTS

NOTE: INFORMATIONAL

CADWELD OR EQUAL

3/4"x10'-0" SECTIONAL

COPPERWELD GROUND

ROD INDEPENDENT NO.

SCALE: NTS

579 OR EQUAL -

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VANASSE HANGEN BRUSTLIN, INC 1 CEDAR STREET SUITE 400 PROVIDENCE, RI 02903 JOSEPH BRADSHAW

KIMLEY-HORN AND ASSOCIATES, IN

QUONSET STATE AIRPORT

150 AIRPORT STREET NORTH KINGSTOWN, RI 02852

PHONE: (401) 691-2000

C 2023

REGISTERED PROFESSIONAL ENGINEER ELECTRICAL

ATE AIRPORT ORT CORPORATIO N, RHODE ISLAND ECONSTRUCT QUONSET (
RHODE ISLAND A
NORTH KINGST
RUNWAY 16-34

DATE 02/09/2023 **DESIGNED BY** DRAWN BY CHECKED BY PROJECT NO. 112214003

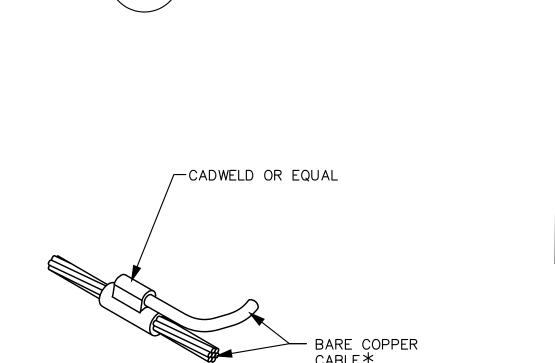
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SHEET TITLE **ELECTRICAL**

DETAILS TRENCHING & GROUNDING

SHEET NO. E5.3

256 OF 286



FINISHED

GRADE -

BACKFILL (NOTE 5)

BACKFILL (NOTE 5)

#6 B.C.

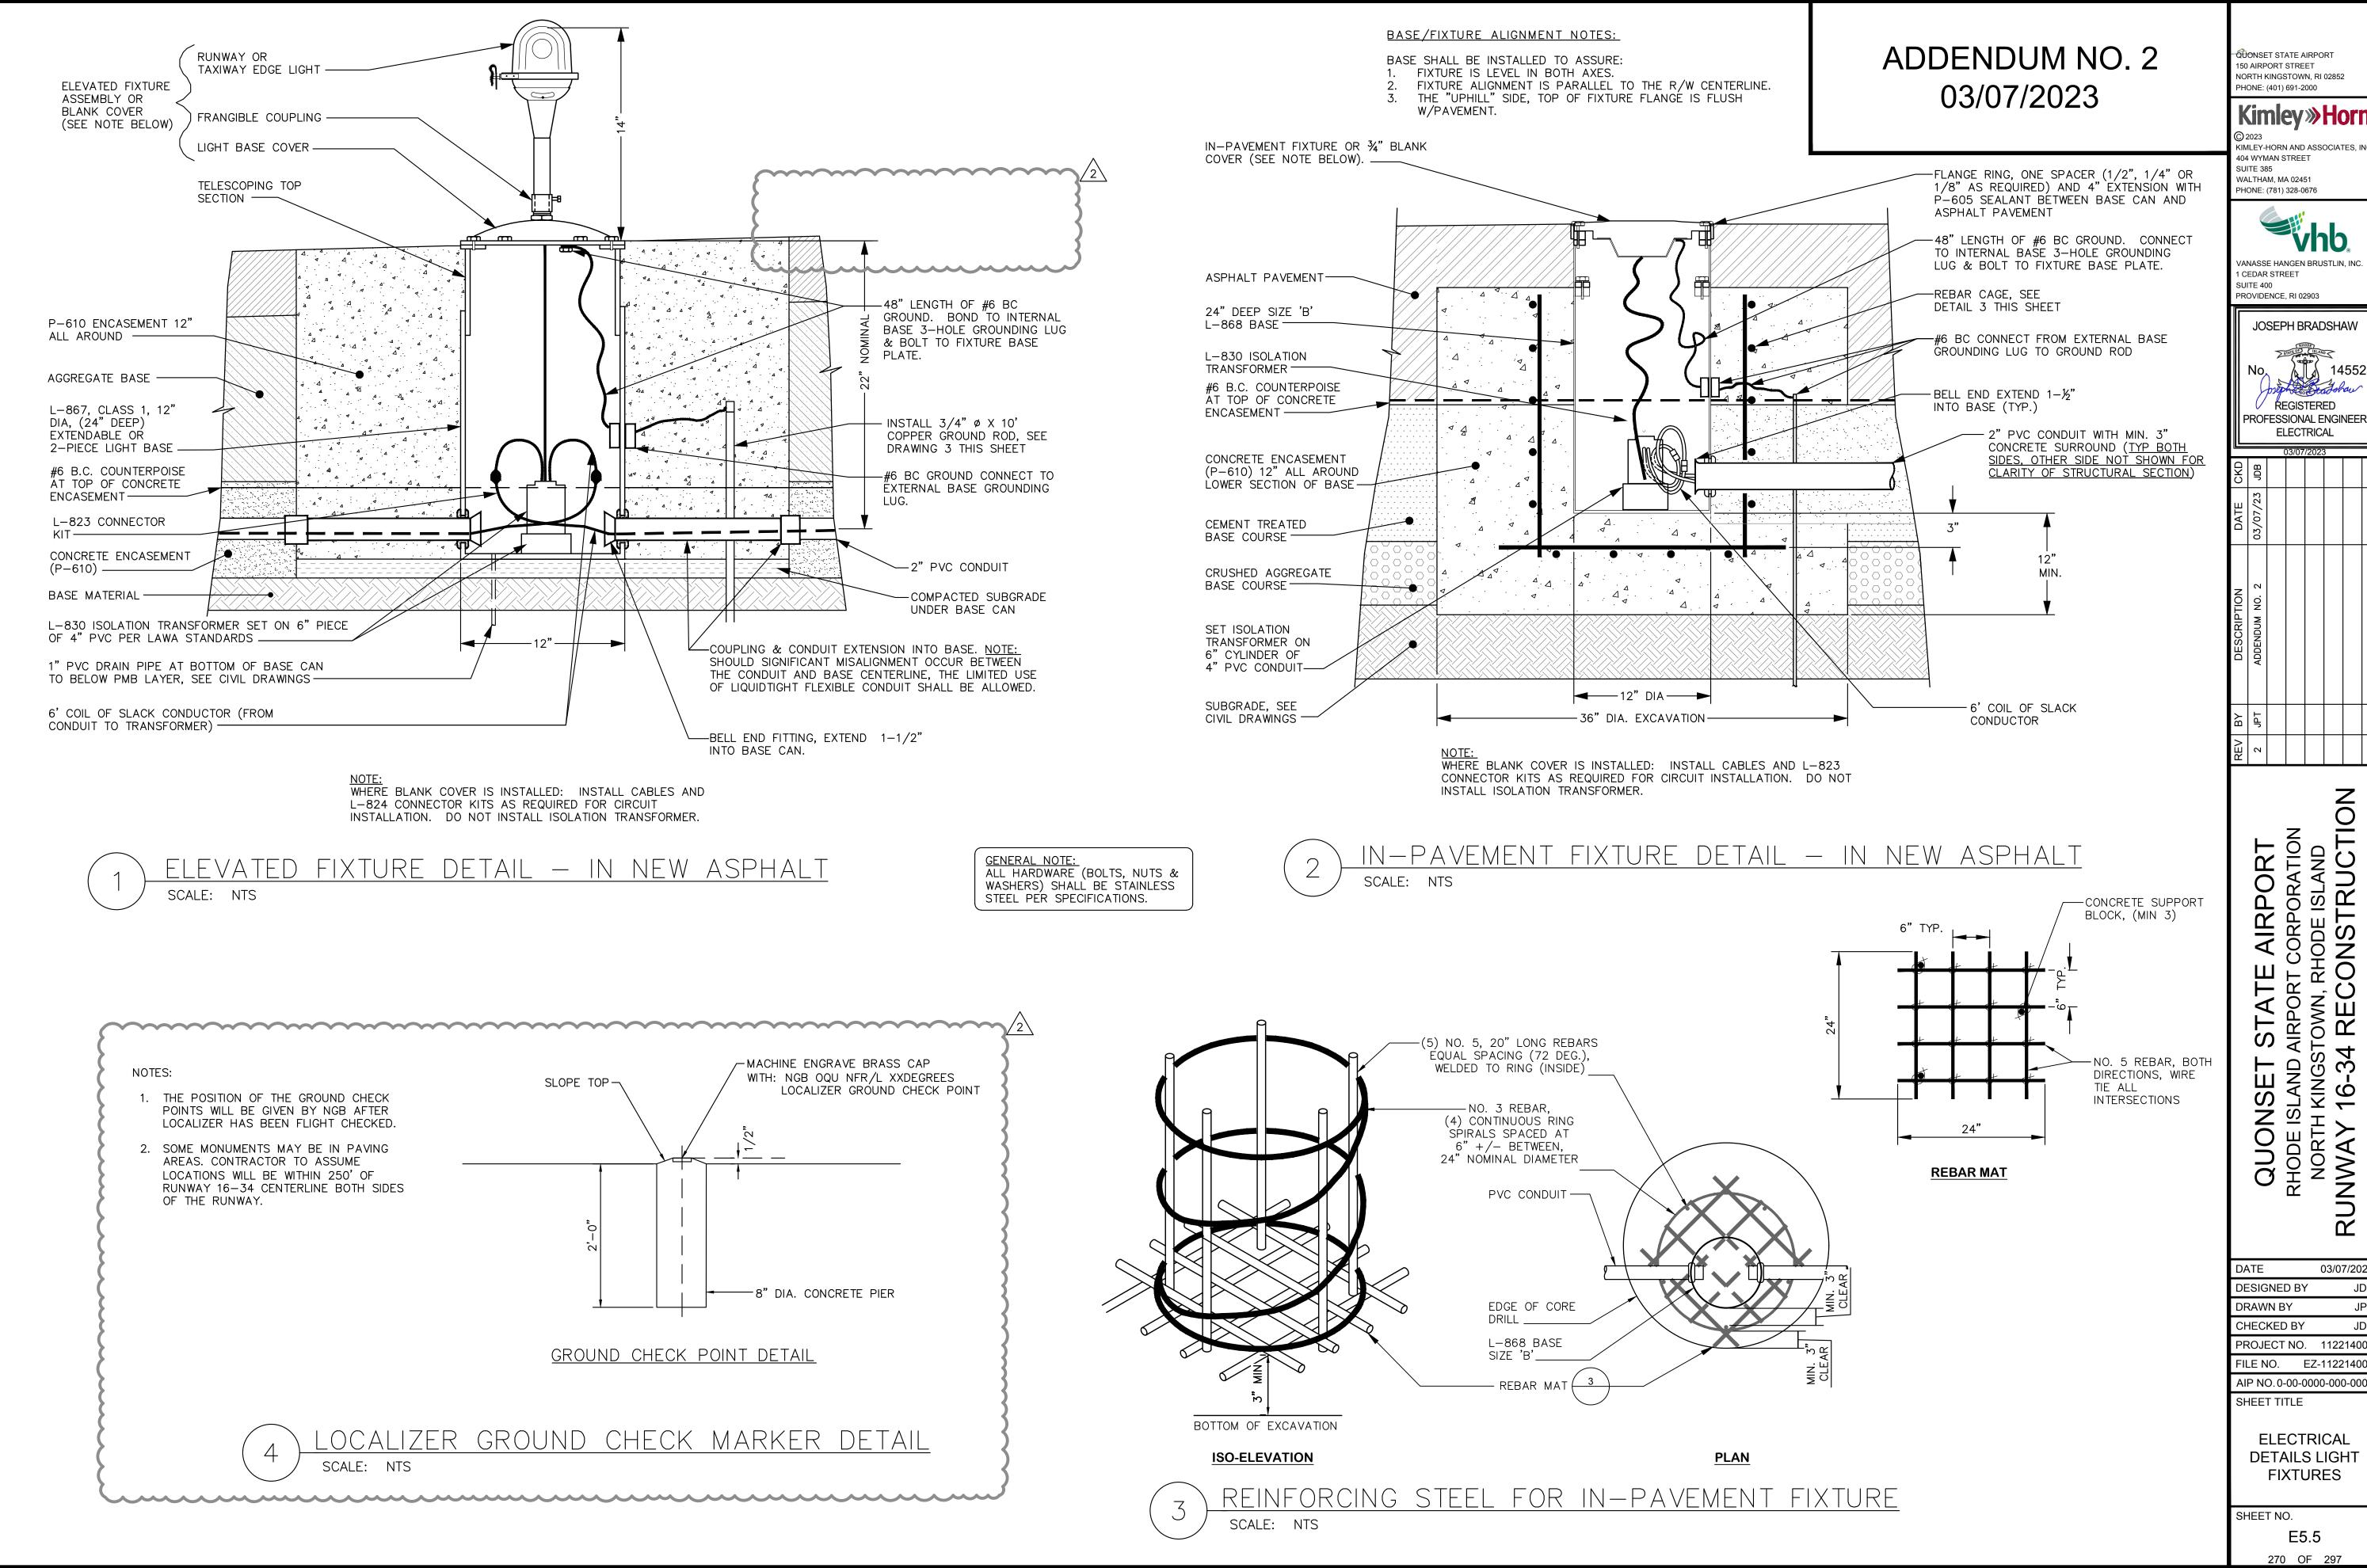
(AS REQ'D)

SCH. 40 PVC

WARNING TAPE (NOTE 3) _

COUNTERPOISE SYSTEM CABLE CONNECTION SCALE: NTS

LIGHTING



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JOSEPH BRADSHAW 14552 REGISTERED PROFESSIONAL ENGINEER

ELECTRICAL

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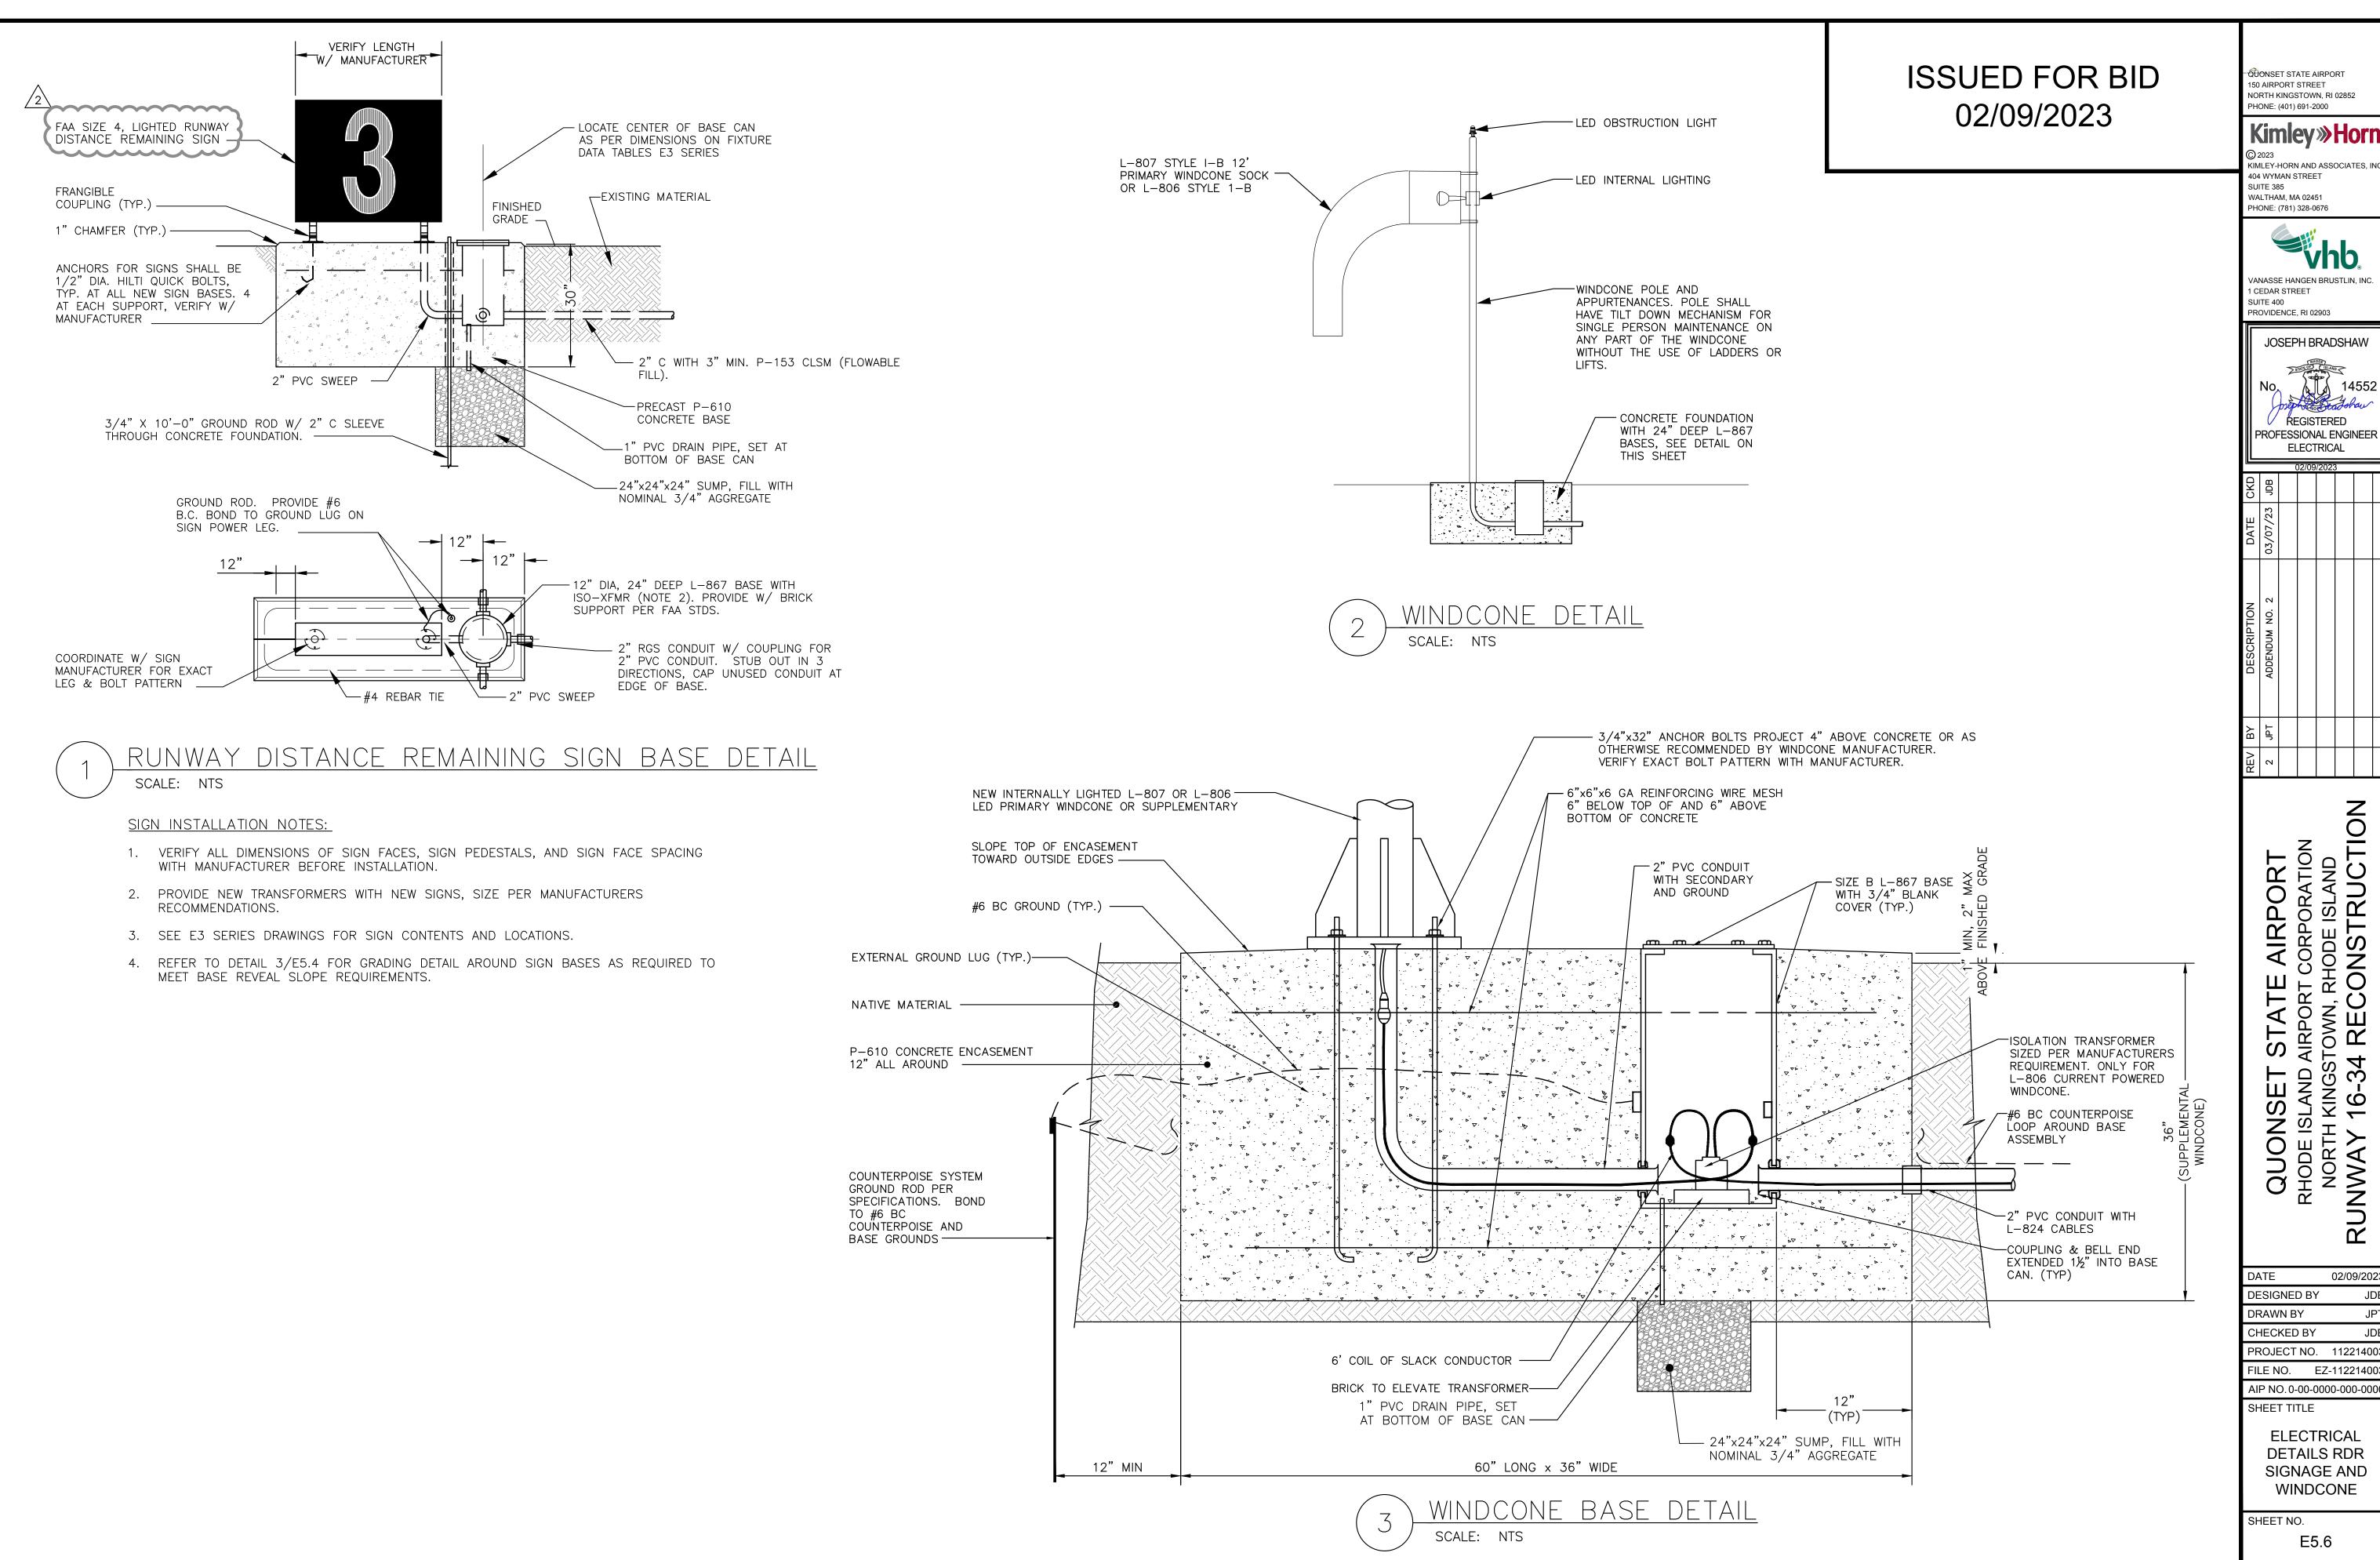
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SHEET TITLE ELECTRICAL

270 OF 297

DETAILS LIGHT **FIXTURES**

SHEET NO. E5.5



NORTH KINGSTOWN, RI 02852

Kimley » Horn

KIMLEY-HORN AND ASSOCIATES, INC

VANASSE HANGEN BRUSTLIN, INC.

JOSEPH BRADSHAW REGISTERED PROFESSIONAL ENGINEER

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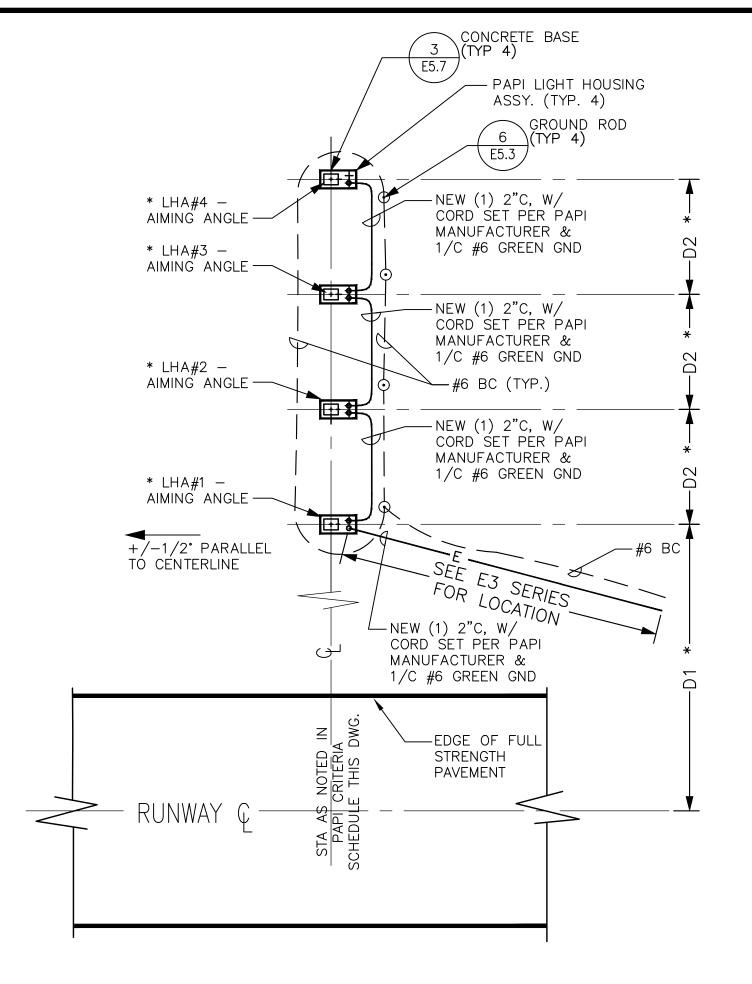
RHODE ISLAND

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02/09/2023 PROJECT NO. 112214003

AIP NO. 0-00-0000-000-0000

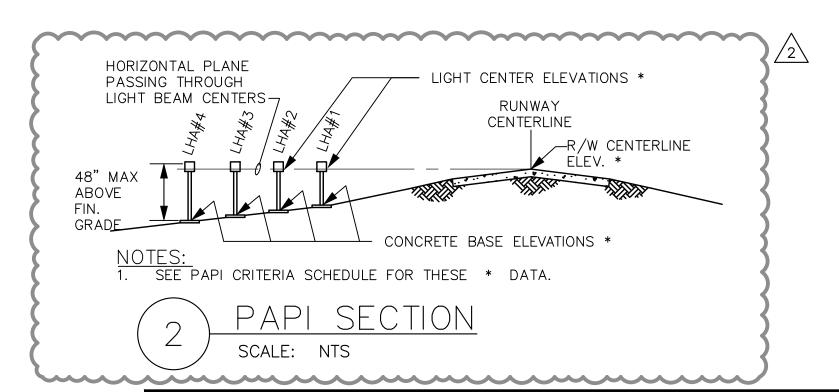
ELECTRICAL DETAILS RDR SIGNAGE AND WINDCONE

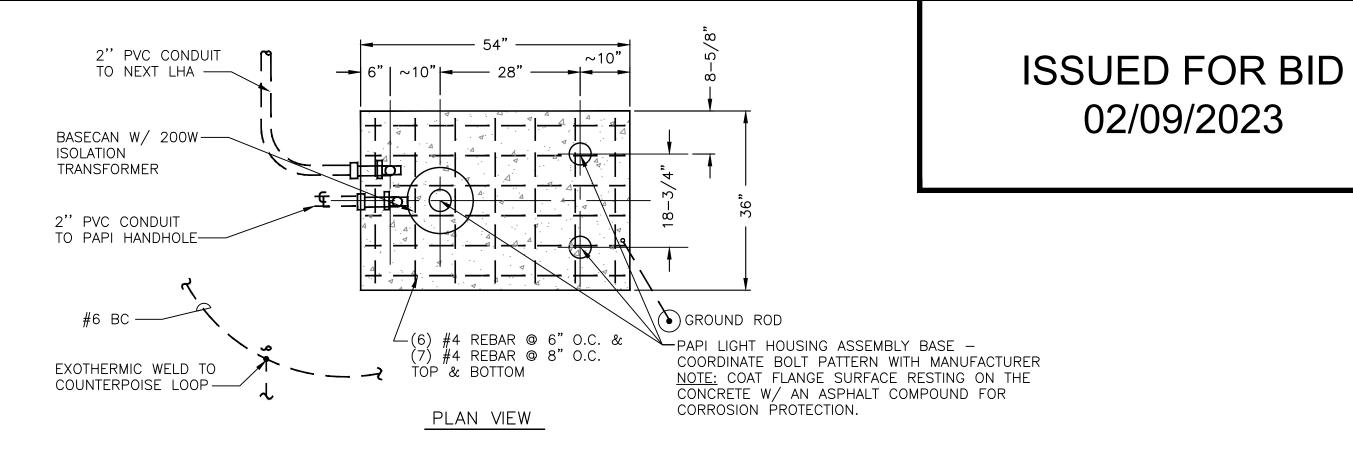


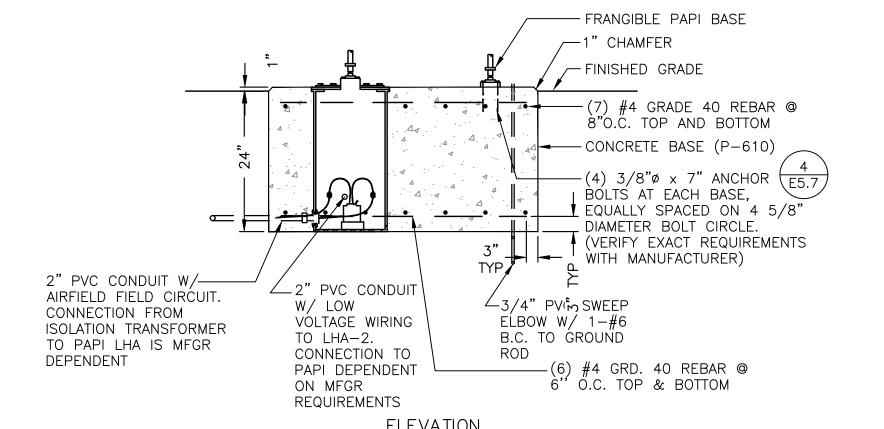
NOTES:

- 1. ALL UNITS IN A BAR SHALL BE LOCATED ON A LINE PERPENDICULAR TO THE RUNWAY CENTERLINE. THE FRONT FACES OF EACH LIGHT UNIT TO BE WITHIN ±6" OF THIS LINE.
- 2. WITHIN 5' OF THE LHA AND EQUIPMENT PADS: 4" DEEP, 3/4" GRAVEL.
- 3. SEE PAPI CRITERIA SCHEDULE FOR * DATA.

PAPI SITE PLAN








FOR REFERENCE ONLY. CONTRACTOR SHALL VERIFY EXACT DIMENSIONS AND REQUIREMENTS PER MANUFACTURER'S RECOMMENDATIONS.

NOTE: FOUNDATION DIMENSIONS ARE

LIGHT BOX CONCRETE BASE

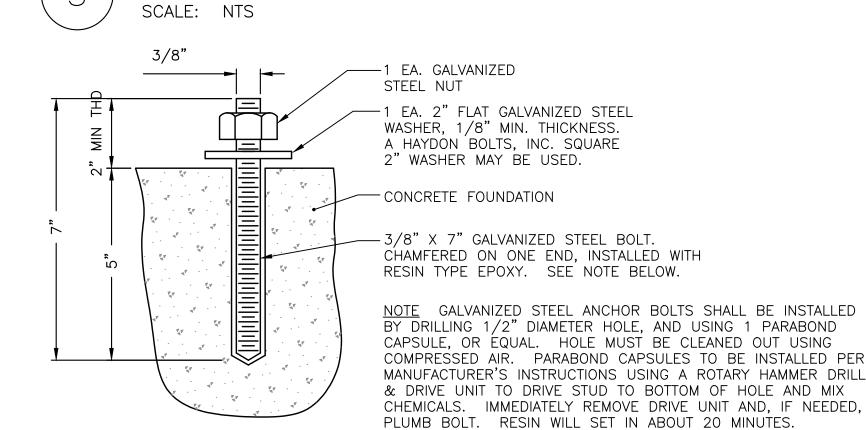NOTE: FINISH TOP OF CONCRETE BASE WITH 1/4"/FT. SLOPE, BOTH DIRECTIONS FROM LONGITUDINAL AXIS.



CHEMICAL ANCHOR BOLT DETAIL SCALE: NTS

			PA	API C	RITERIA	SCHE	EDUL	E				
R/W	STA	(DIST. FROM R/W © TO © OF LHA #1) (FT)	LIGHT HOUSING ASSEMBLY (LHA) SPA. O.C. (FT.)	R/W CL ELEV. (FT)	LIGHT CENTER ELEVATION (FT)	2	AIMING BASED O GLIDE			EFFECTIVE VISUAL THRESHOLD CROSSING HEIGHT (TCH)	THRESHOLD R/W CENTERLINE ELEVATION (FT)**	,
16	111+00.00	125'-0"	30'-0"	15.24'	15.60' (NOT TO EXCEED 1'	LHA#1	LHA#2	LHA#3	LHA#4	55.0'	18.30'	16
	111+00.00	123 -0	30 -0	13.24	ABOVE RUNWAY CL)	3° 30'	3° 10'	2° 50'	2° 30'	33.0	18.30	
34	159+50.00	125'-0"	30'-0"	11.34'	12.00' (NOT TO EXCEED 1'	LHA#1	LHA#2	LHA#3	LHA#4	55.0'	11.34'	34
34	139+30.00	125 -0	30 -0	11.34	ABOVE RUNWAY CL)	3° 30'	3° 10'	2° 50'	2° 30'	35.0	11.54	34
TEMP 34	139+50.00	125'-0"	30'-0"	11.34'	12.00' (NOT TO EXCEED 1'	LHA#1	LHA#2	LHA#3	LHA#4	55.0'	2 11.34'	TEMP 34
34	139+30.00	123 -0	30 -0	11.54	ABOVE RUNWAY CL)	3° 30'	3° 10'	2° 50'	2° 30'	33.0	7 - 11.54	J4

* COORD W/ AIRPORT FOR AIMING ANGLES PRIOR INSTALLING PLACARD AFTER FLIGHT TESTING. ** CONTRACTOR TO VERIFY ELEVATIONS IN THE FIELD PRIOR TO PAPI INSTALLATION.

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VANASSE HANGEN BRUSTLIN, INC. 1 CEDAR STREET SUITE 400 PROVIDENCE, RI 02903

JOSEPH BRADSHAW REGISTERED PROFESSIONAL ENGINEER

ELECTRICAL

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NORTH KINGST
RUNWAY 16-34

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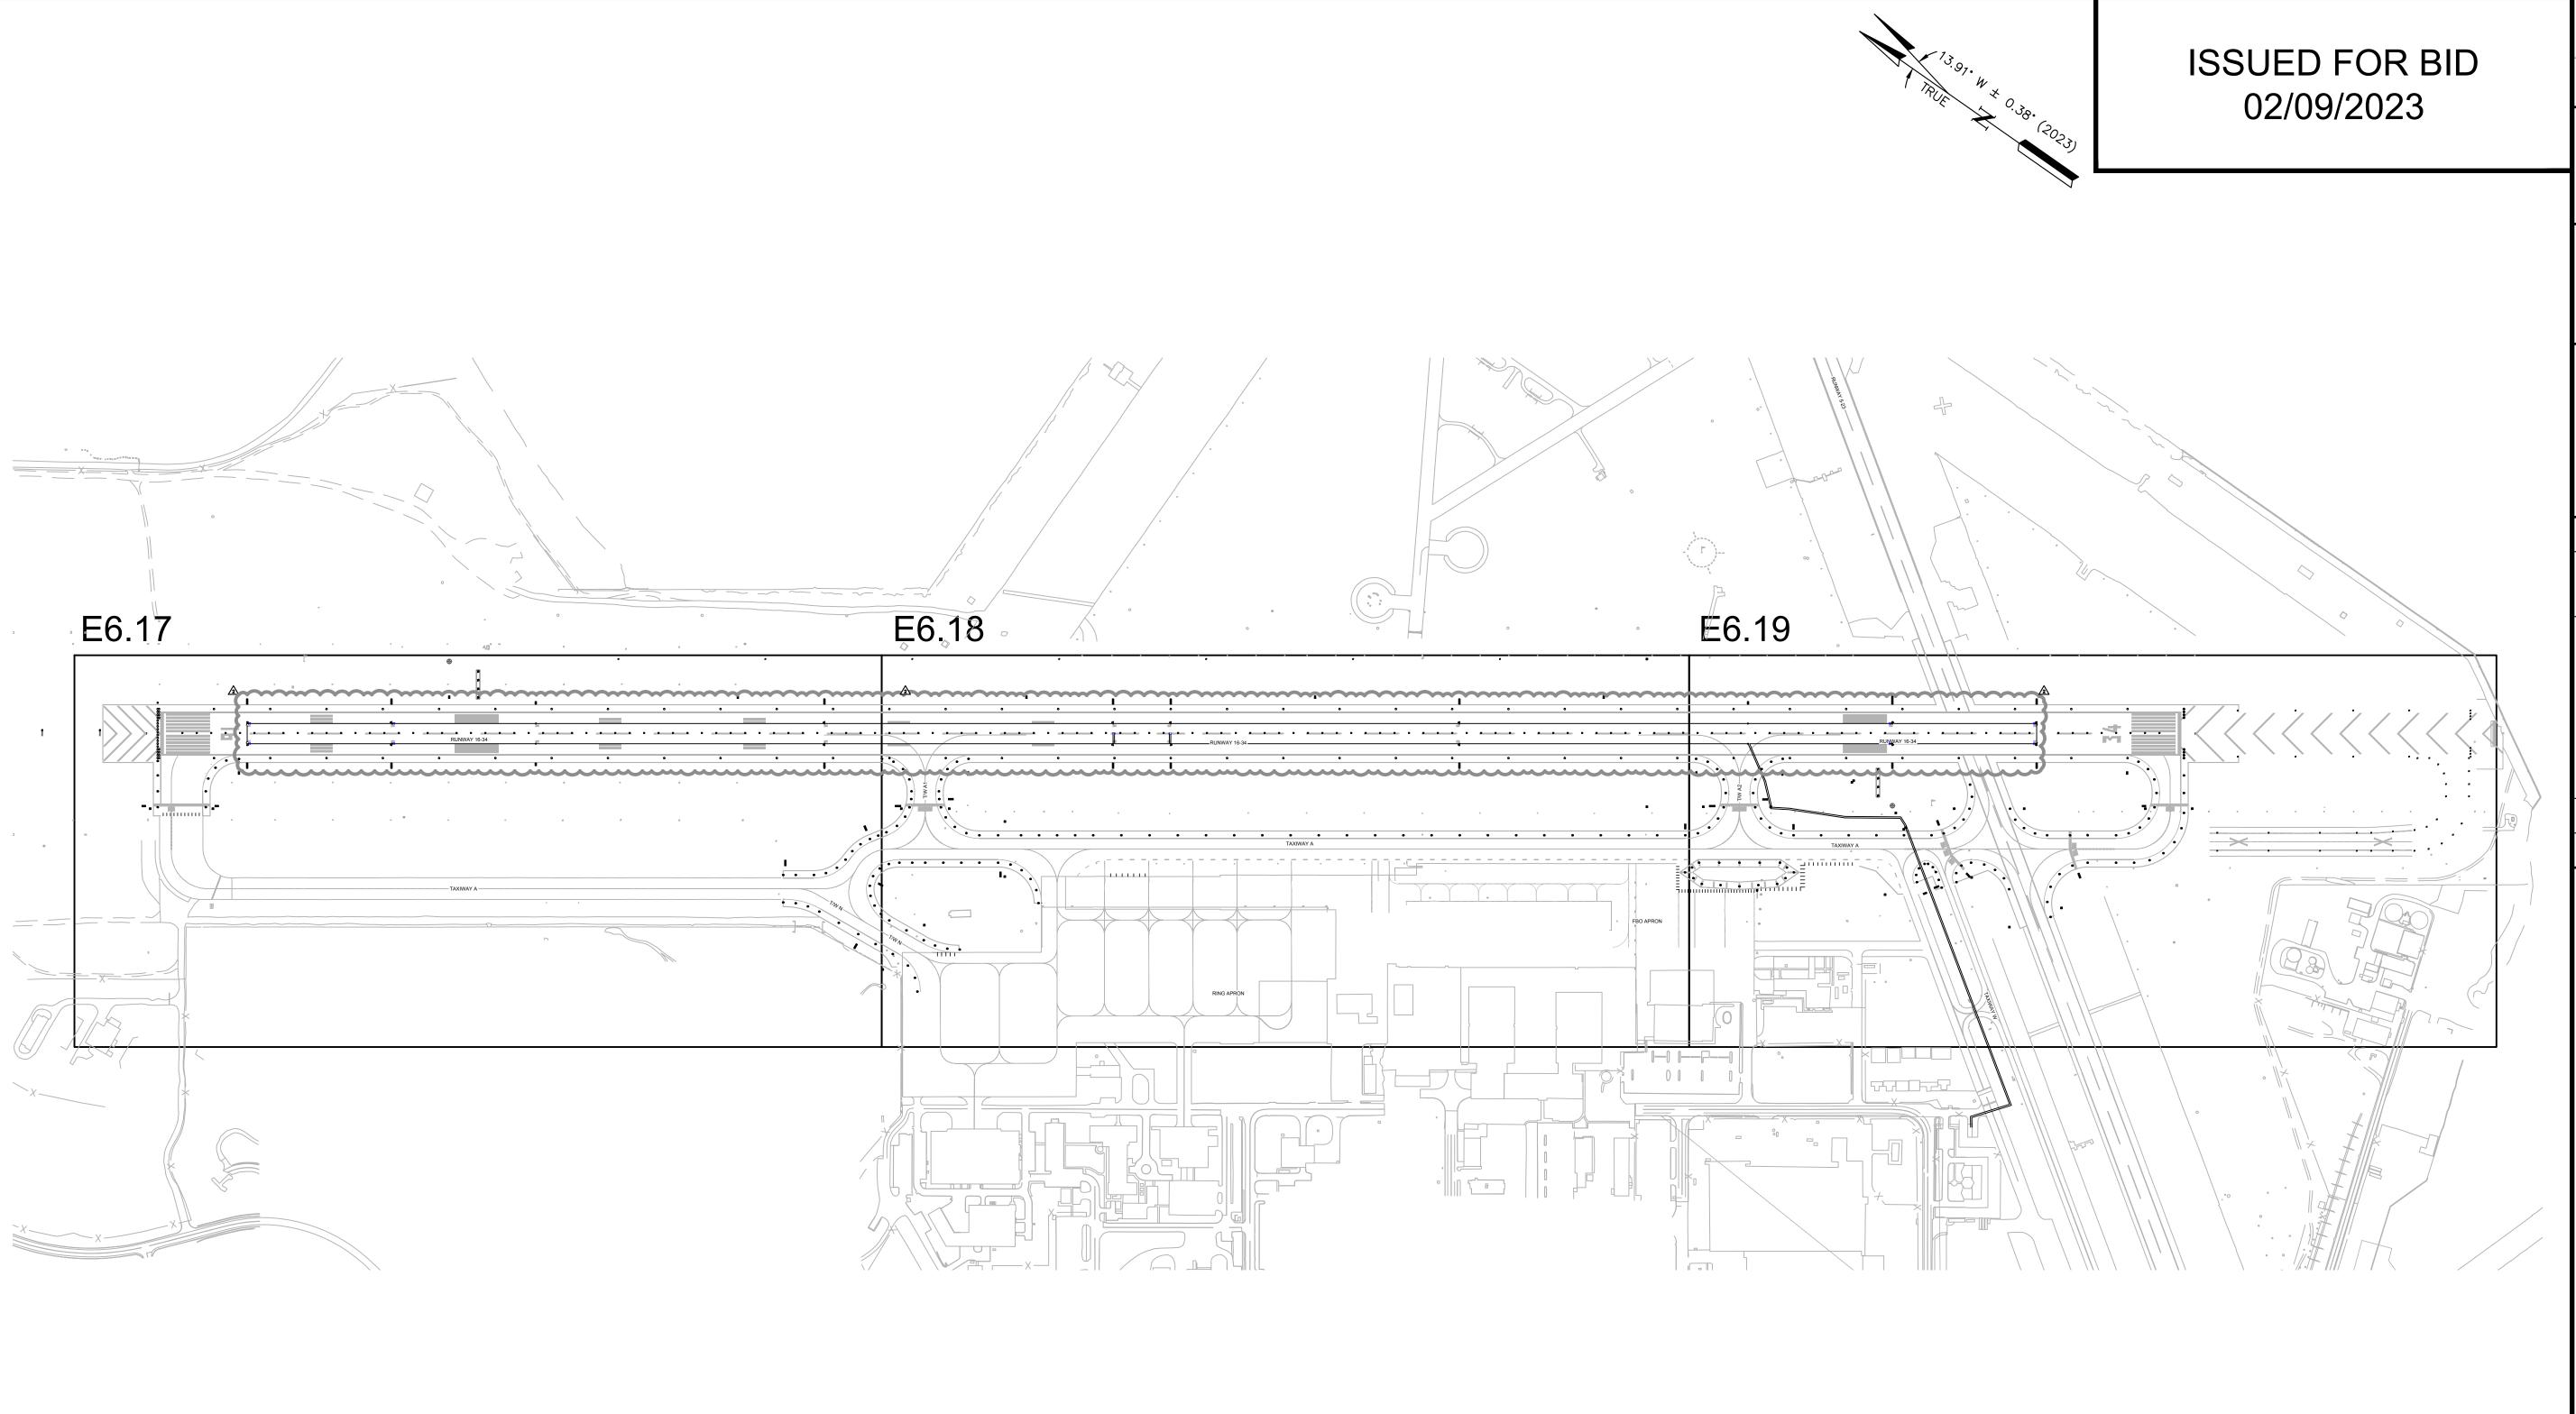
SHEET TITLE ELECTRICAL **DETAILS PAPI**

DETAILS

260 OF 286

AIP NO. 0-00-0000-000-0000

SHEET NO. E5.7



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OVERALL MILITARY


LANDING ZONE LIGHTING CIRCUIT MAP

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300 0 300 S C A L E I N F E E T

Know what's **below.**• **Call** before you dig.

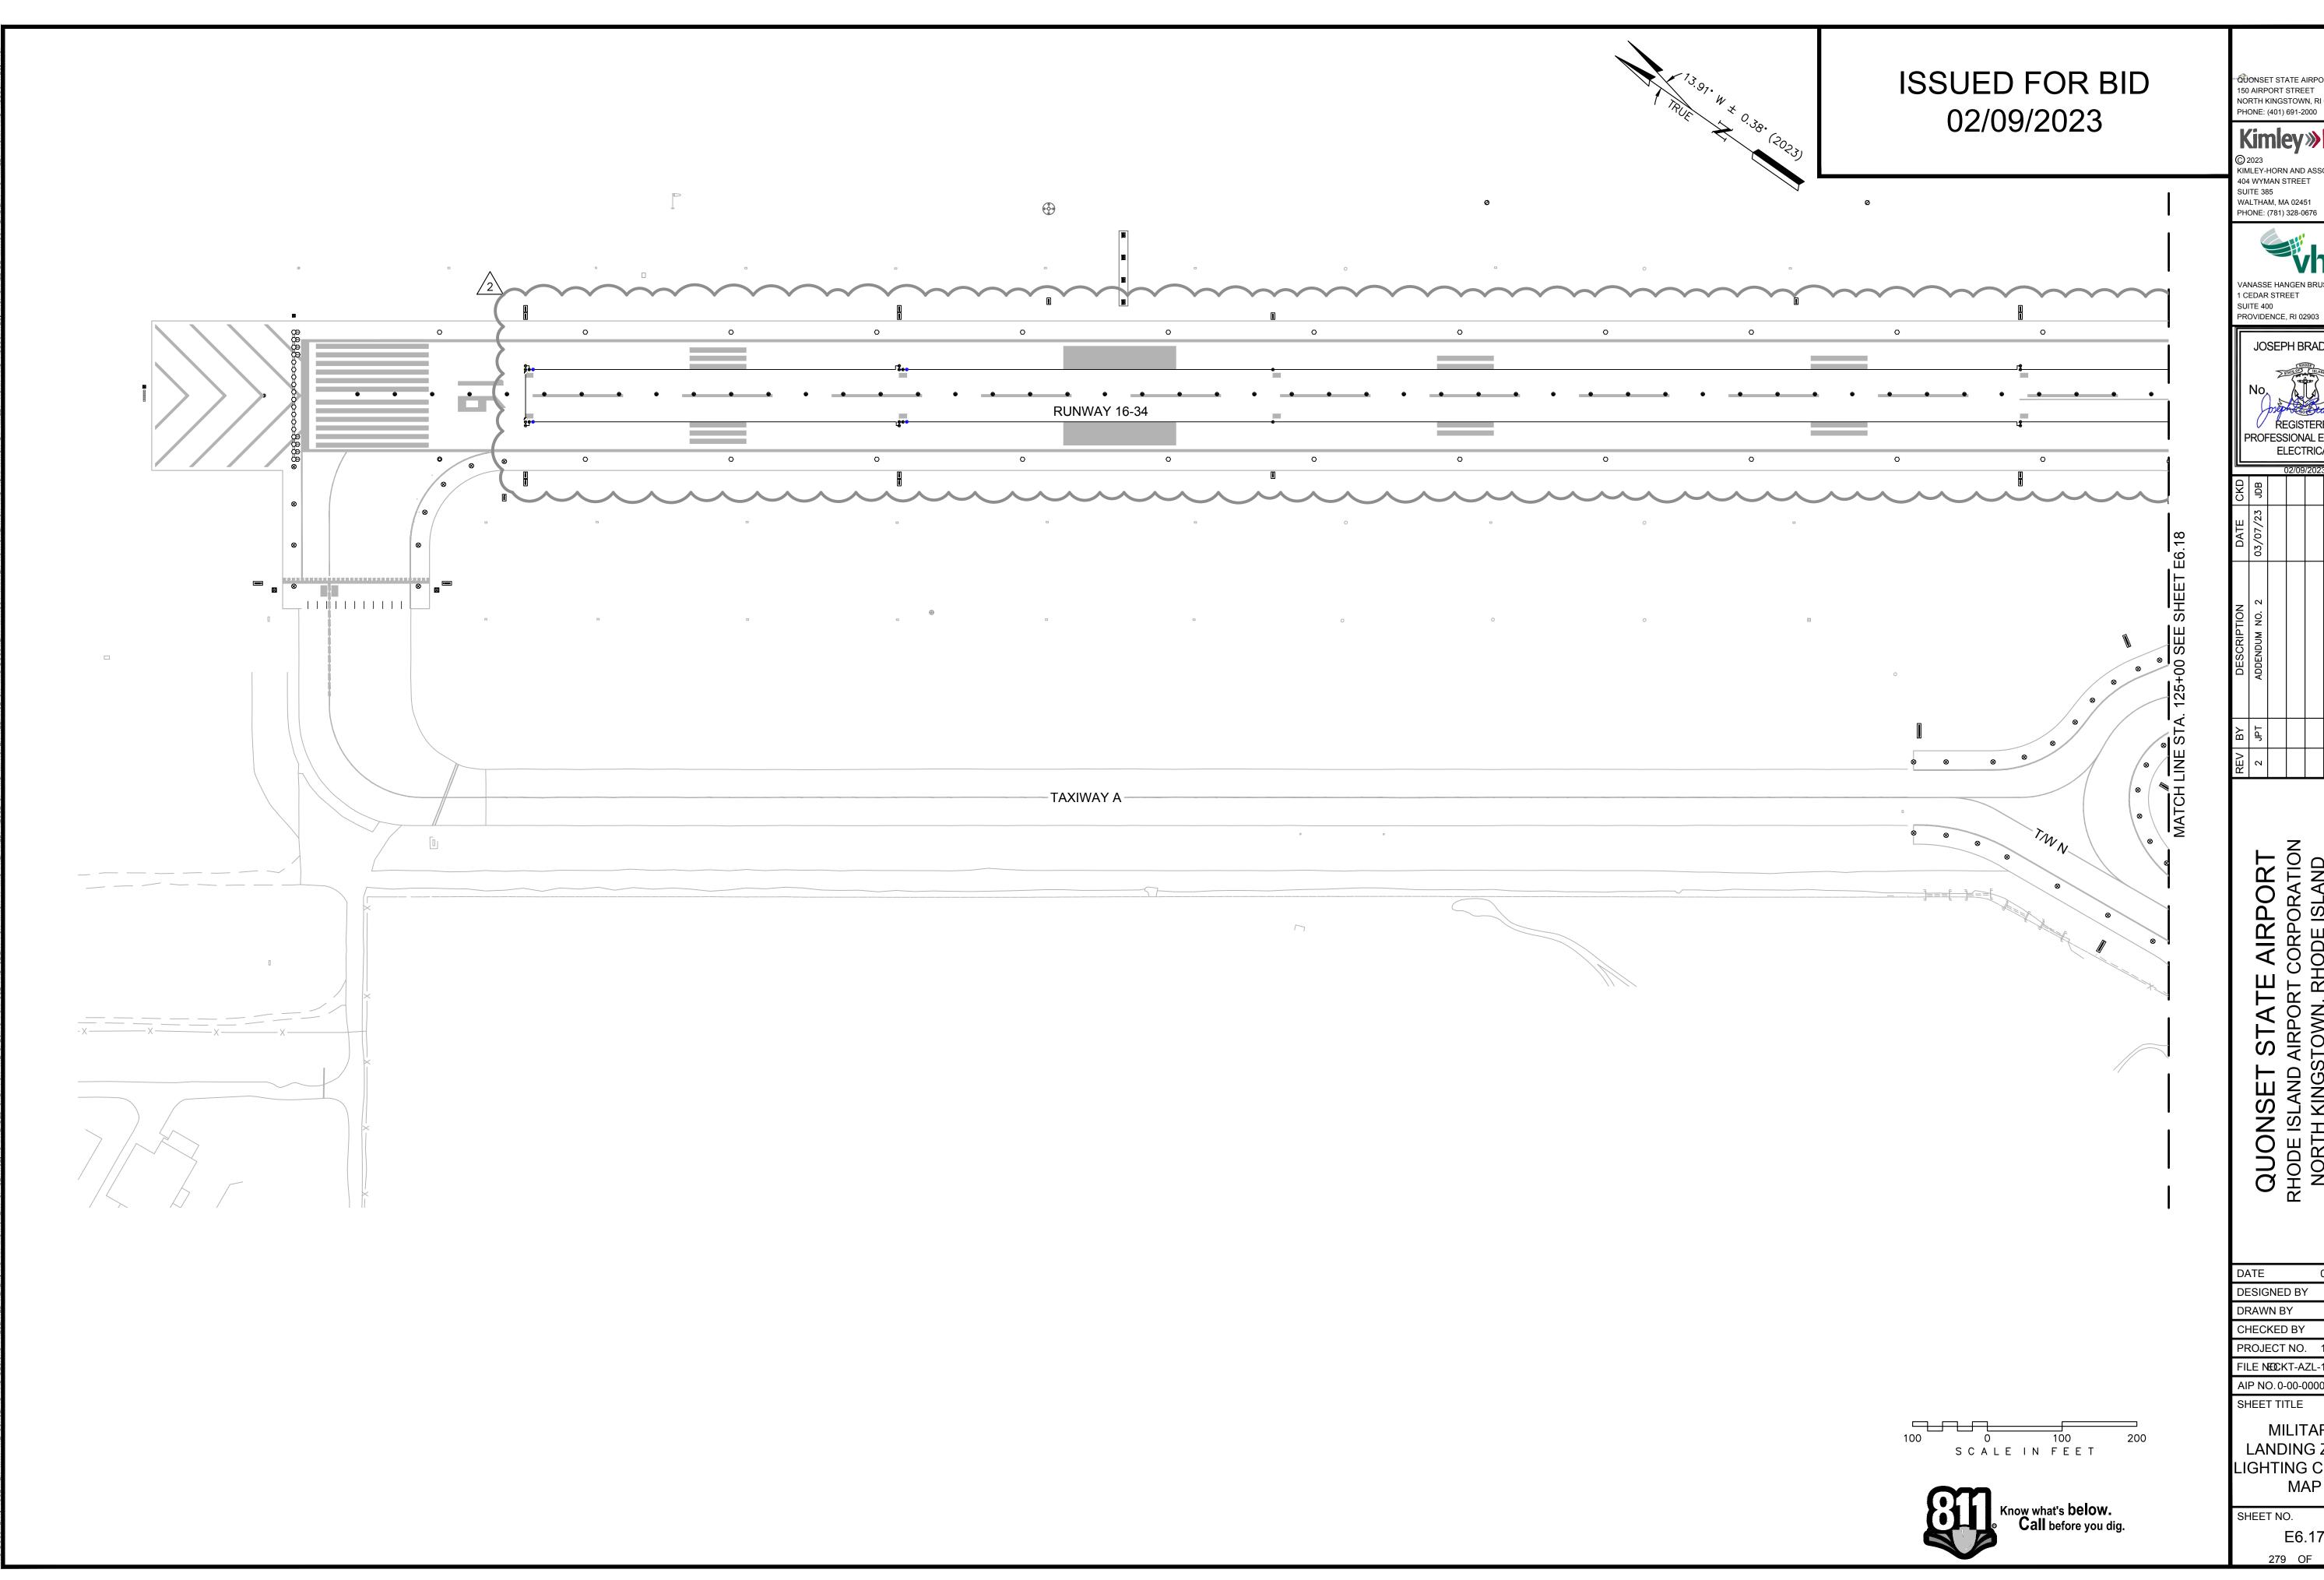E6.16 278 OF 286



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SUITE 400 PROVIDENCE, RI 02903 JOSEPH BRADSHAW

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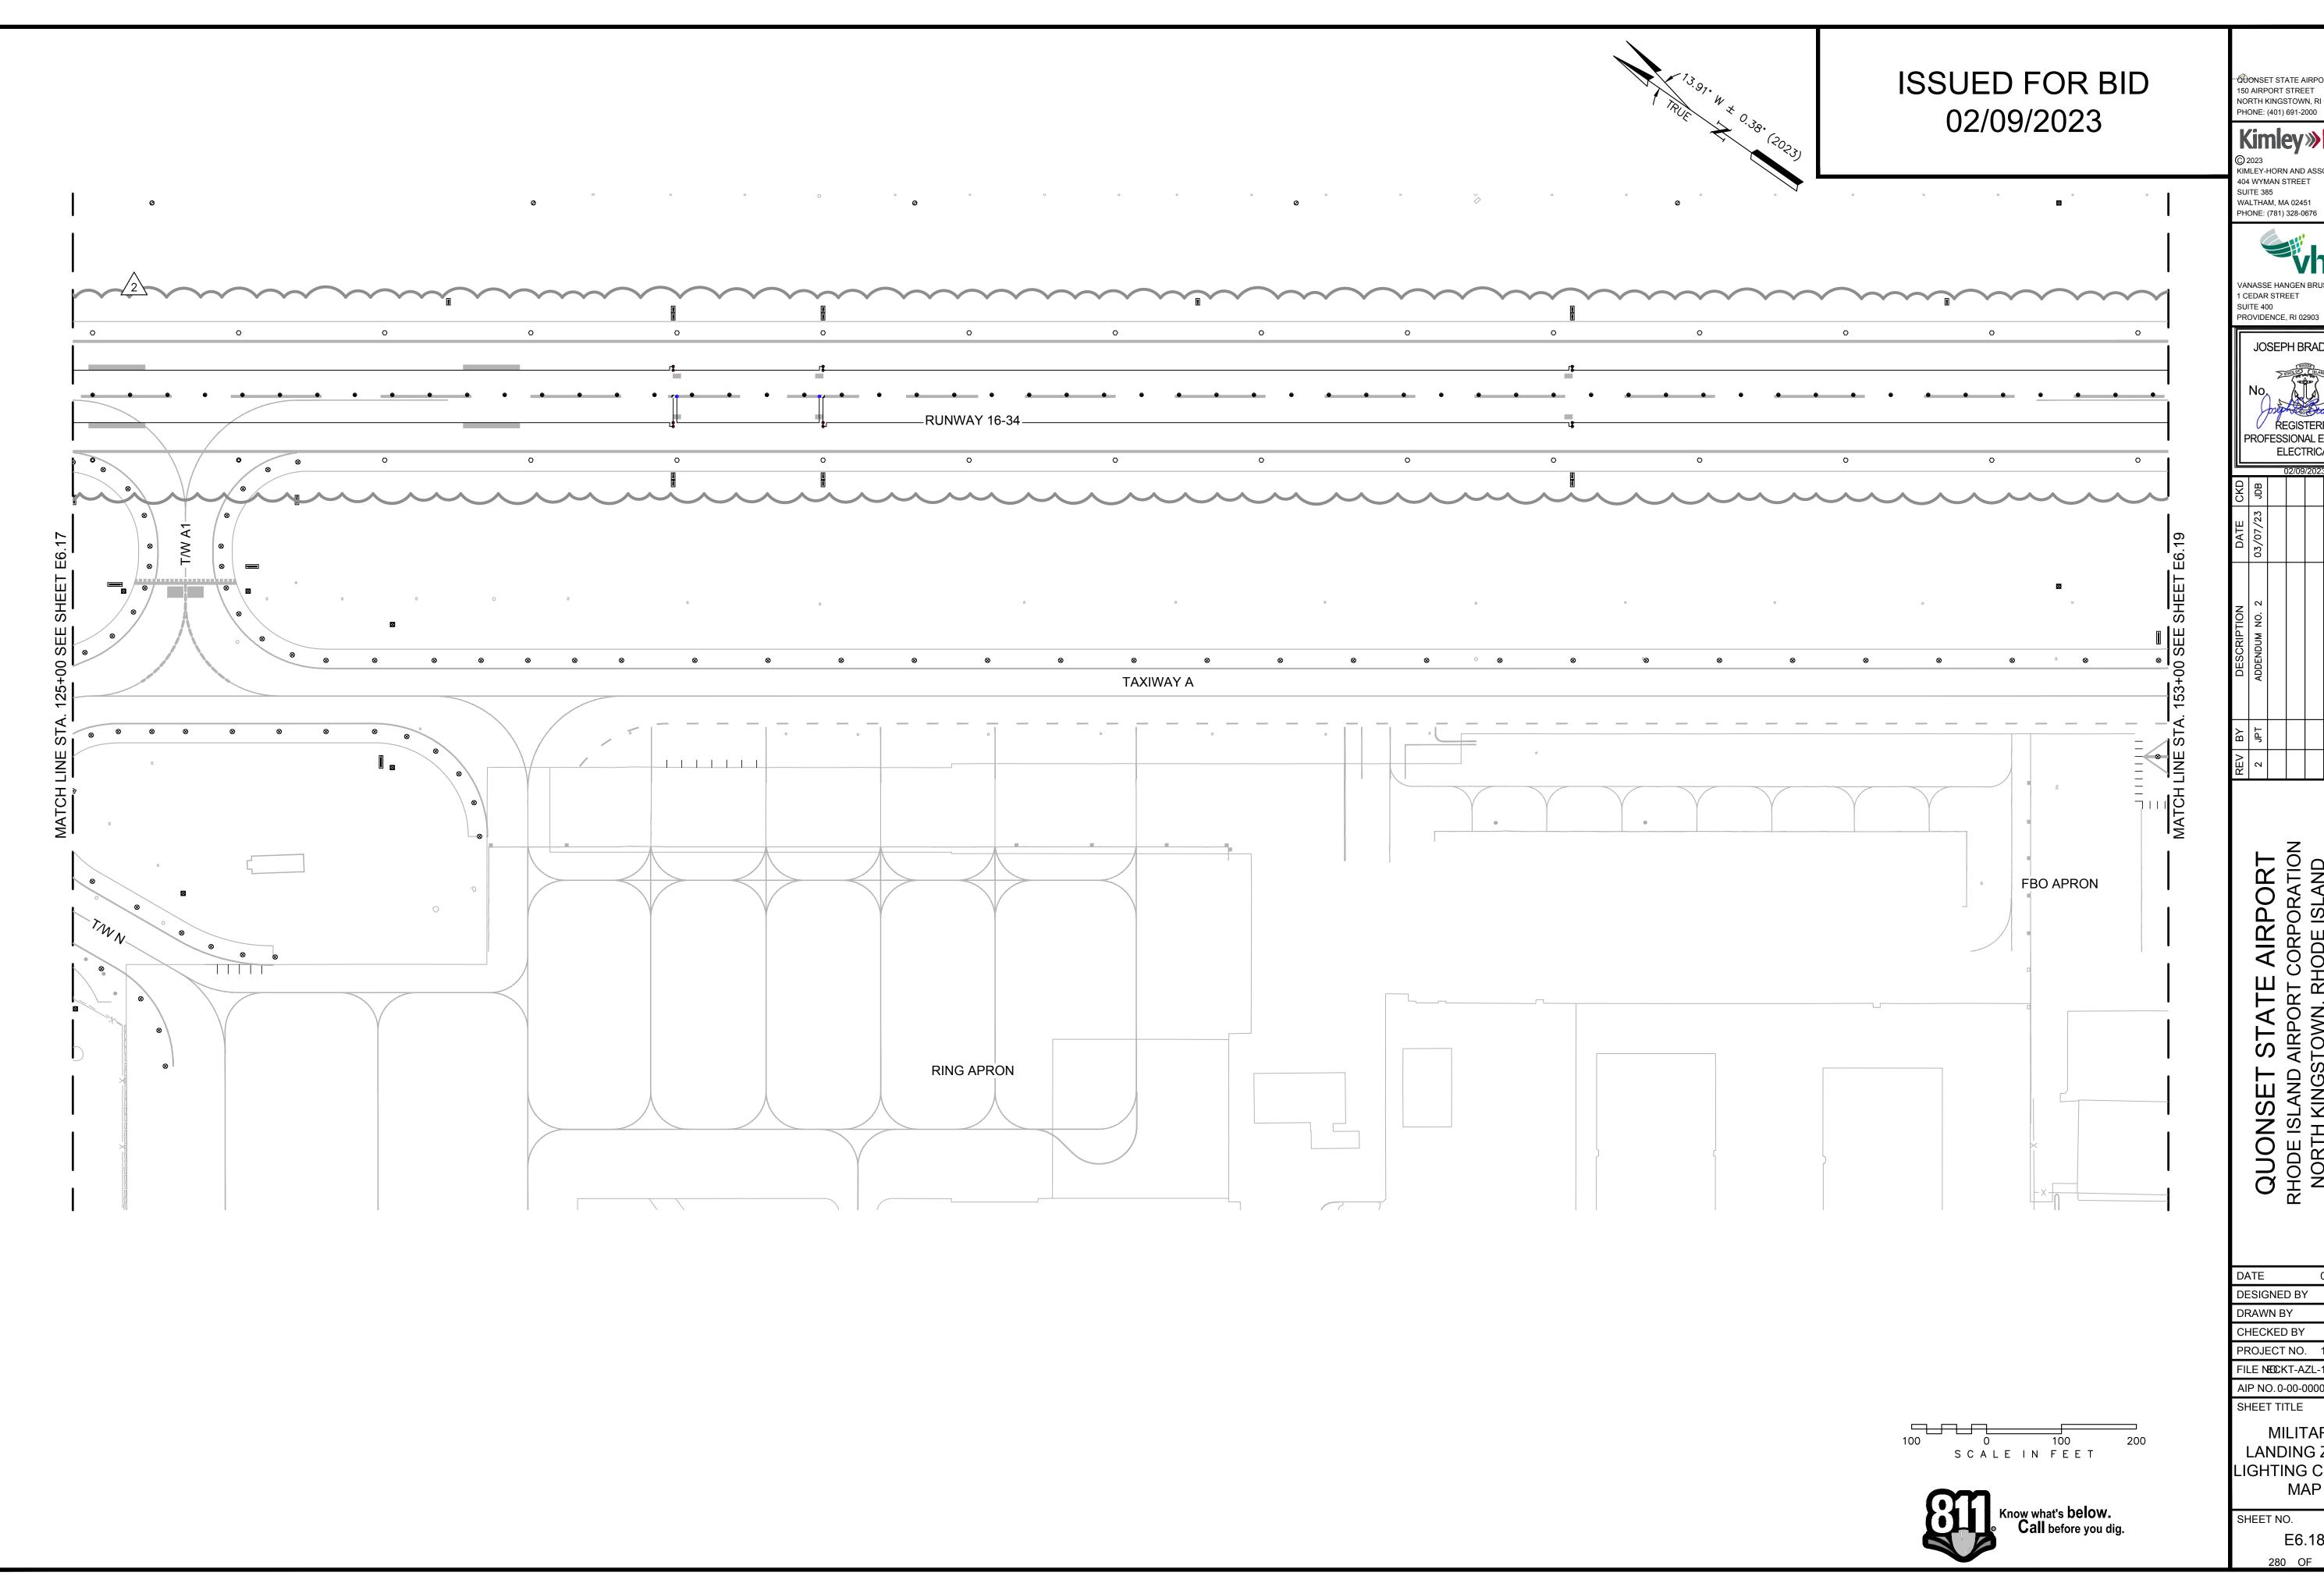
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MILITARY LANDING ZONE LIGHTING CIRCUIT MAP

SHEET NO.

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JOSEPH BRADSHAW PROFESSIONAL ENGINEER ELECTRICAL

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RUNWAY 16-34 RECONSTRU


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MILITARY LANDING ZONE LIGHTING CIRCUIT MAP
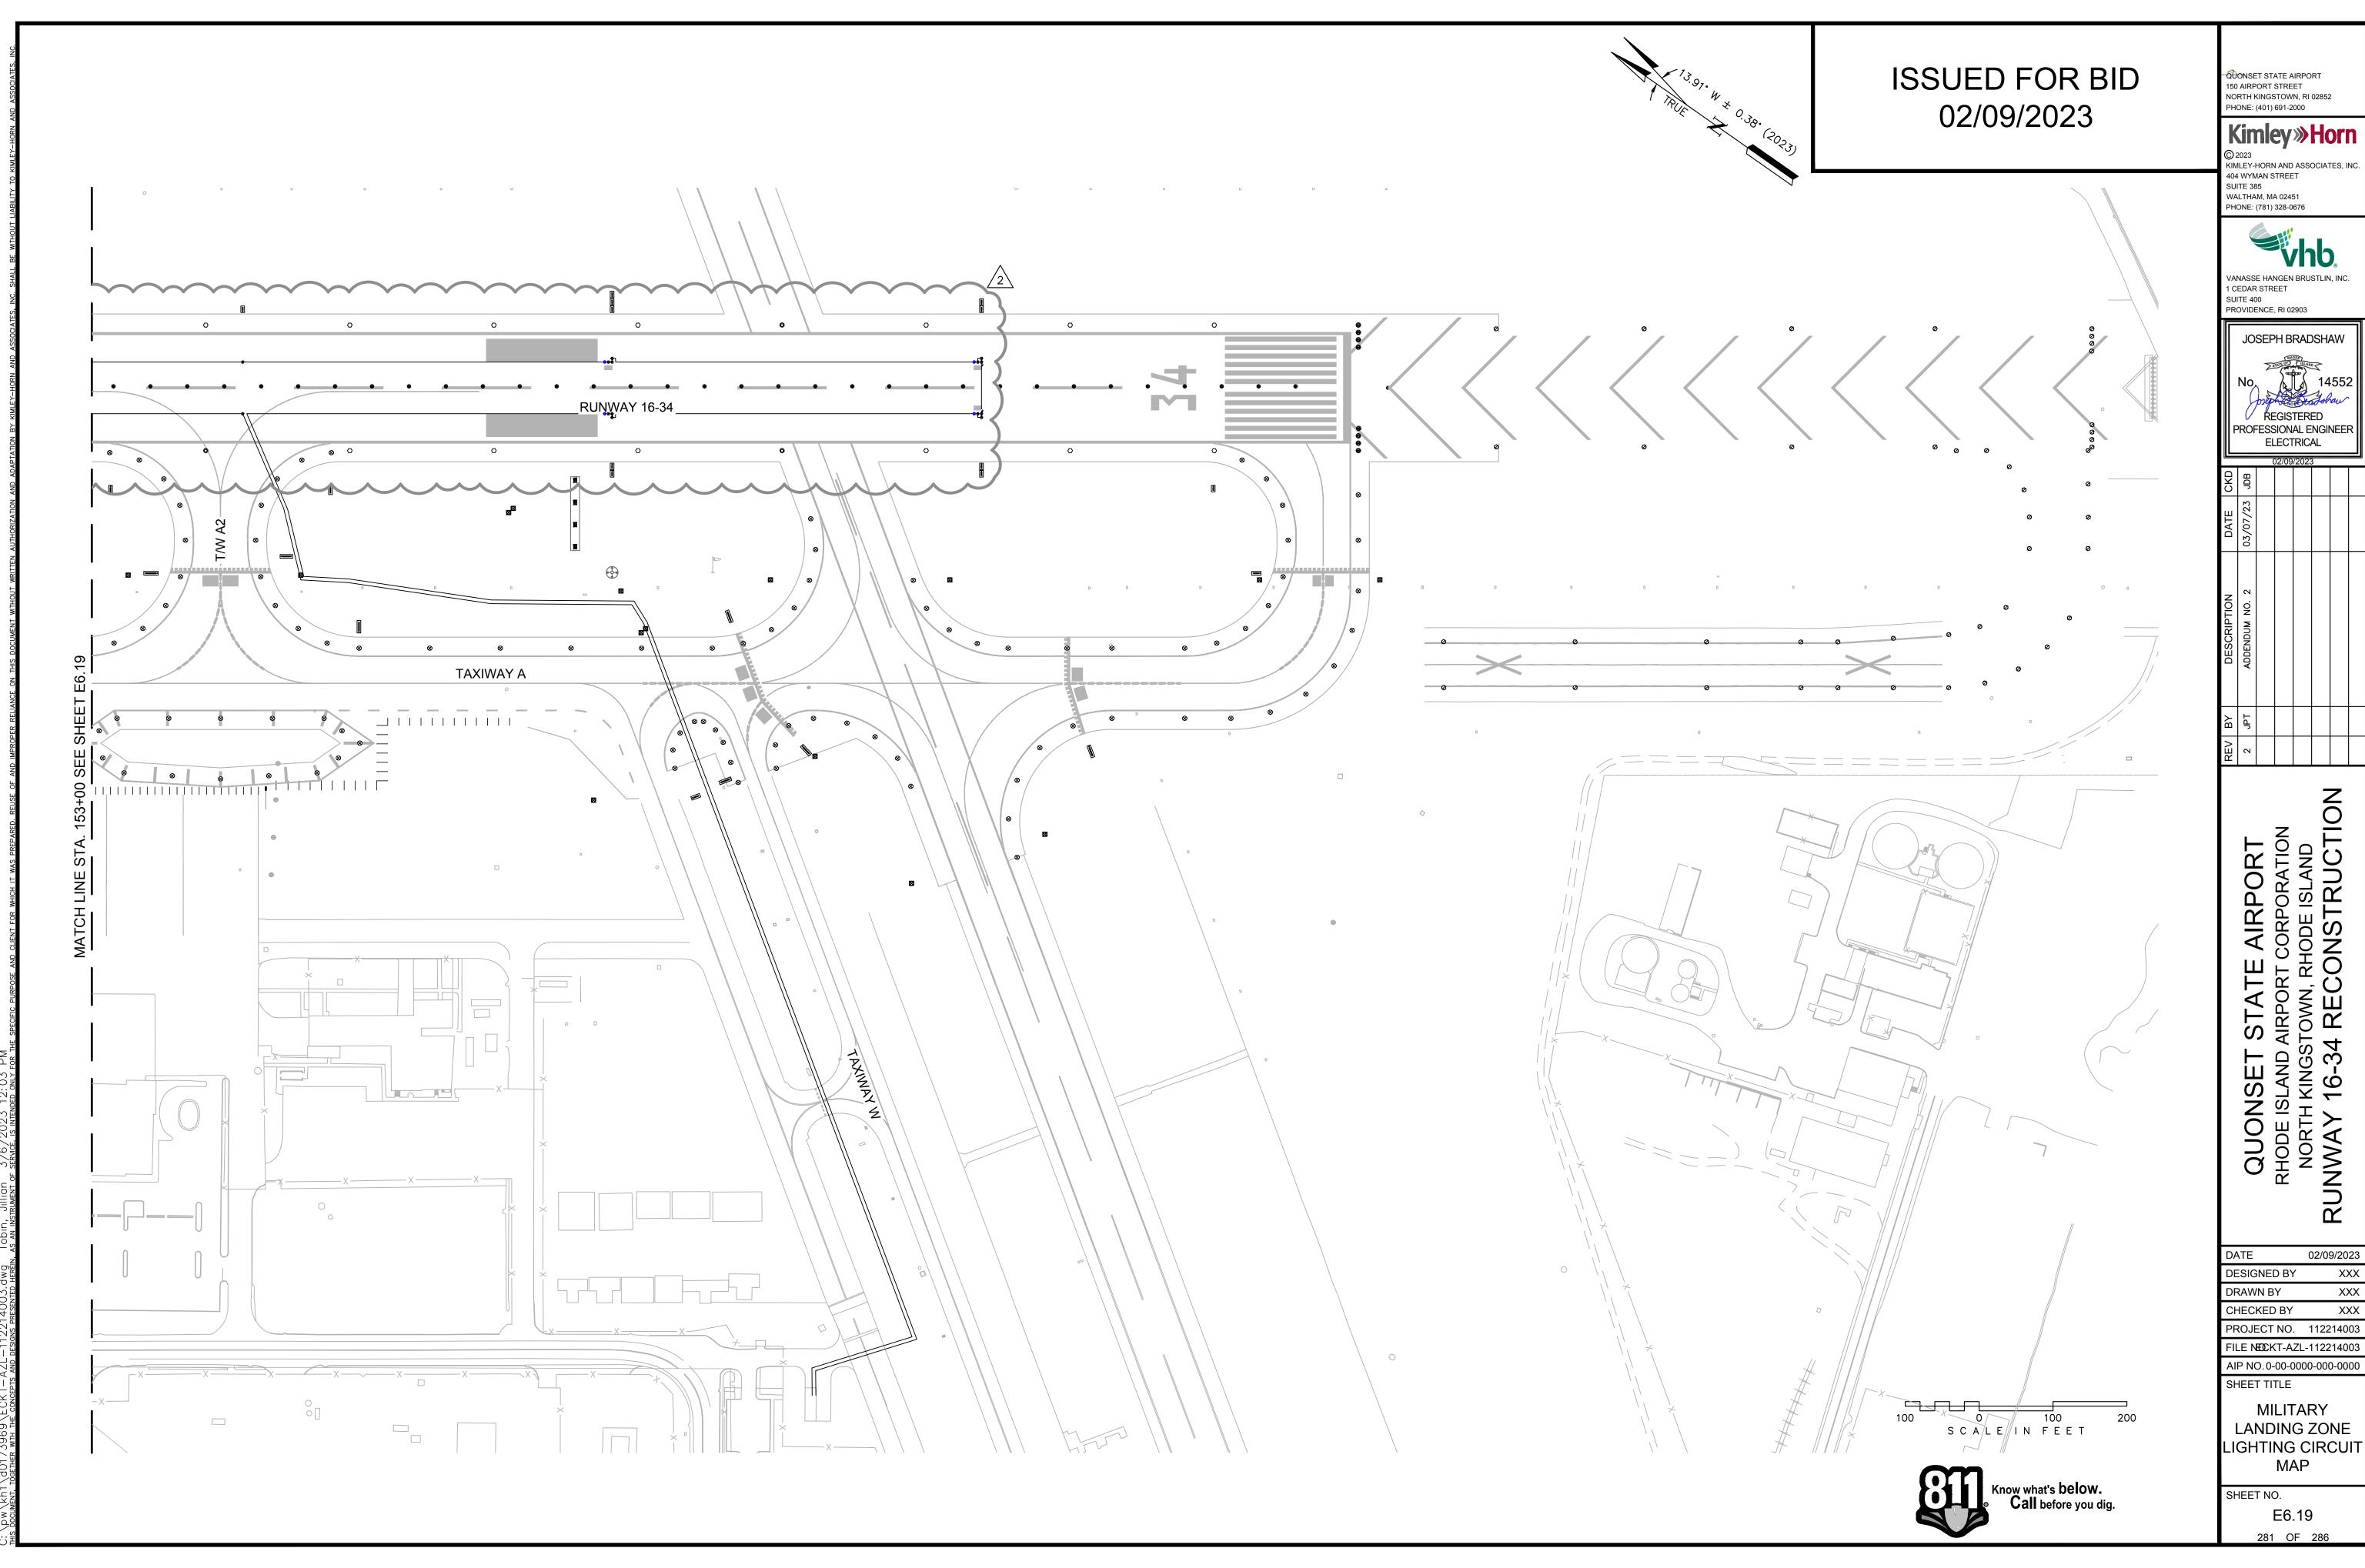
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